
COUNTY PROJECT NUMBER
DEKALB 2020-205

DEKALB 2020-205

LOCATION SKETCH (N.T.S.)

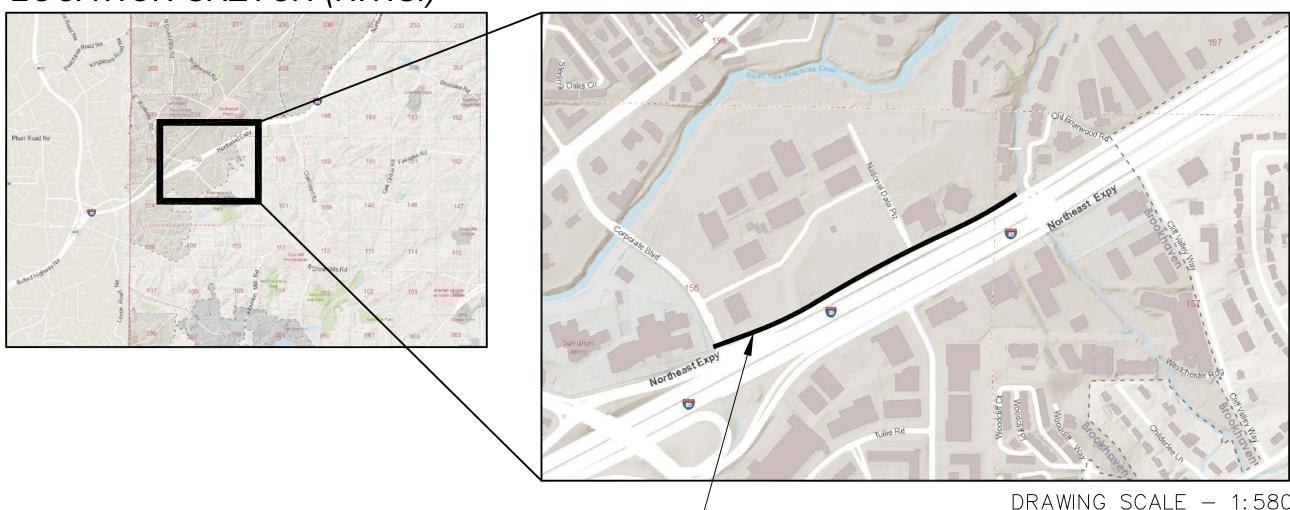

CONSTRUCTION PLANS FOR: CITY OF BROOHAVEN, DEPT. OF PUBLIC WORKS

N.E. EXPRESSWAY FRONTAGE ROAD MULTI-USE PATH

FROM CORPORATE BLVD. TO STONE CREEK APTS.

LAND LOT: 156 AND 157 DISTRICT 18

MONTH

1 | 2 | 3 | 4 | 5 | 6 | 7 | 8 | 9 | 10 | 11 |

City of Brookhaven Permit NO:LDP20-00035 GDOT Permit NO:A-089-005325-7 Dekalb County Permit NO: 3071835

TOTAL SITE AREA: 0.7 ACRES

DISTURBED AREA: 0.7 ACRES

PROPOSED ADDITIONAL IMPERVIOUS: 0.45 ACRES

STATE ROUTE 403 EXT. NDH-1 POSTED SPEED LIMIT: 45MPH

FUNCTIONAL CLASS: MULTI-USE TRAIL

THIS PROJECT IS 100% IN DEKALB COUNTY AND IS 100% IN CONG. DIST. NO.5

THIS PROJECT HAS BEEN PREPARED USING THE HORIZONTAL GEORGIA COORDINATE SYSTEM OF 1984 (NAD 1983)/94 WEST ZONE. AND THE NORTH AMERICAN VERTICAL DATUM (NAVD) OF 1988.

THE PROJECT DOES FALL WITHIN 200' OF STATE WATERS

LENGTH OF PROJECT

	LINEAR FEET
NET LENGTH OF ROADWAY	N/A
NET LENGTH OF PED. BRIDGES	N/A
NET LENGTH OF TRAIL	2068
NET LENGTH OF EXCEPTIONS	N/A
GROSS LENGTH OF PROJECT	2068

PROJECT DESCRIPTION-

PROJECT IS FOR THE CONSTRUCTION OF A 10'
MULTI-USE PATH WITHIN THE EXISTING LANDSCAPE
BUFFER OF I-85 FRONTAGE ROAD: THE PROJECT
INCLUDE SIDEWALK CONSTRUCTION, (3) RETAINING WALLS,
DRIVEWAY MODIFICATION, GRADING, MINOR UTILITY
RELOCATION, LANDSCAPING, AND SIGNING & MARKING

NOTE:

ALL REFERENCES IN THIS DOCUMENT, WHICH INCLUDES ALL PAPERS, WRITINGS, DOCUMENTS, DRAWINGS, OR PHOTOGRAPHS USED, OR TO BE USED IN CONNECTION WITH THIS DOCUMENT, TO "STATE HIGHWAY DEPARTMENT OF GEORGIA", "STATE HIGHWAY DEPARTMENT", "GEORGIA STATE HIGHWAY DEPARTMENT", OR "DEPARTMENT" WHEN THE CONTEXT THEREOF MEANS THE STATE HIGHWAY DEPARTMENT OF GEORGIA, AND SHALL BE DEEMED TO MEAN THE DEPARTMENT OF TRANSPORTATION.

THE DATA, TOGETHER WITH ALL OTHER INFORMATION SHOWN ON THESE PLANS OR IN ANYWAY INDICATED THEREBY, WHETHER BY DRAWING OR NOTES, OR IN ANY OTHER MANNER, ARE BASED UPON FIELD INVESTIGATIONS AND ARE BELIEVED TO BE INDICATIVE OF ACTUAL CONDITIONS. HOWEVER, THE SAME ARE SHOWN AS INFORMATION ONLY, ARE NOT GUARANTEED, AND DO NOT BIND THE DEPARTMENT OF TRANSPORTATION IN ANY WAY.

NO NPDES MONITORING TO OCCUR FOR THIS PROJECT

AND THE FEBRUARY 2021 INDICATE: FEBRUARY 2021 INDICATE: AUGUST 2022 THE SCHEDULE IS TO BE USED FOR FERNATING PURPOSES ONLY. FEFTER INDICATE: AUGUST 2022 THE SCHEDULE IS TO BE USED FOR FERNATING PURPOSES ONLY. FEFTER INDICATE AUGUST 2022 THE SCHEDULE IS TO BE USED FOR FERNATING PURPOSES ONLY. FEFTER INDICATE AUGUST 2022

EXISTING UTILITY STAKE HOLDERS:

DESCRIPTION

ISTALL EROSION CONTROL STRUCTURES

PPLY TEMPORARY VEGETATION, MULCH, & GRAVEL

NSTALL CONST. ENTRANCE NSTALL SEDIMENT BARRIER NSPECT BY CITY / OR COUNTY

NSTALL STORM DRAIN SEWER
NSTALL CURB & GUTTER

SALVAGE TIMBER CLEAR & GRUB SITE

GA POWER D.O.T - MELISSA WHEELER - MSWHEELE@SOUTHERCO.COM
GA POWER DISTRIBUTION - KENNETH DAVIS - KRDAVIS@SOUTHERCO.COM
AT&T - TIFFANY HAMMOND - TH638J@ATT.COM
COMCAST - ANSLEY JOHNSON - ANSLEY_JOHNSON@COMCAST.COM
CROWN CASTLE - VENESIA HORNE - VENESIA.HORNE@CROWNCASTLE.COM
ATLANTA GAS LIGHT - GINNY MAULDIN - VMAULDIN@SOUTHERNCO.COM
DEKALB WATER AND SEWER - (770) 621-7200

Charles M Abbott

Level II Certified Design Professional

Certification Number 0000041686

ISSUED: 04/13/2019 Expires: 04/13/2022

ALL WORK TO BE DONE IN ACCORDANCE WITH:

-2013 STANDARD SPECIFICATIONS AND 2016
SUPPLEMENTAL SPECIFICATIONS OF THE GEORGIA
DEPARTMENT OF TRANSPORTATION
-2010 AMERICANS WITH DISABILITIES ACT (ADA)
STANDARDS FOR ACCESSIBLE DESIGN
-ARCHITECTURAL BARRIERS ACT (ABA) ACCESSIBILITY
STANDARDS

OWNER/DEVELOPER (PRIMARY PERMITTEE)

CITY OF BROOKHAVEN
HARI KARIKARAN, P.E. & DONALD SHERRILL
PUBLIC WORKS DIRECTOR & DEPUTY DIRECTOR
4362 PEACHTREE RD, BROOKHAVEN, GA 30319
O: 404-637-0682 C: 404-991-4763
DON.SHERRILL@BROOKHAVENGA.GOV

24HR. CONTACT

DONALD SHERRILL
PUBLIC WORKS DEPUTY DIRECTOR
4362 PEACHTREE RD, BROOKHAVEN, GA 30319
O: 404-637-0682 C: 404-991-4763
DON.SHERRILL@BROOKHAVENGA.GOV

BROOKHAVEN CITY COUNCIL INFORMATION:

MEMBERS MAYOR: JOHN ERNST
REP. DISTRICT 1: LINLEY JONES
REP. DISTRICT 2: JOHN PARK
REP. DISTRICT 3: MADELEINE SIMMONS

REP. DISTRICT 4: JOE GEBBIA

PHONE: (404) 637-0500

PREPARED BY:

CONTACT INFORMATION EMAIL: MAYORANDCOUNCIL@BROOKHAVENGA.GOV



KAIZENCOLLABORATIVE

2390 Main Street | Tucker, GA 30084 | 404.239.2521


CHARLES M. ABBOTT JR, P.E.

DESIGN ENGINEER LEVEL II CERTIFICATION

GSWCC # 0000041686 EXPIRES: 04/13/2022

CHUCK.ABBOTT@KAIZENCOLLABORATIVE.COM

T: 404-239-2521

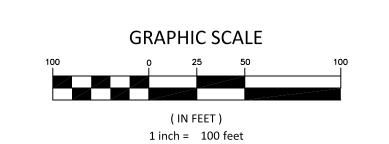

No. 31674 PROFESSIONAL ** No. 31674 PROFESSIONAL ** ABBOTT O3/17/2021 O3/17/2021
03/1/(5

EROSION AND CONSTRUCTION SCHEDULE


PLANS COMPLETED	11/20/2020	100% ISSUE FOR PERMIT
REVISION DATES	01/11/2021	REV. 1 CITY COMMENTS
	02/08/2021	REV. 2 AGENCY COMMENTS
	03/17/2021	REV. 3 GDOT COMMENTS

DEKALB COUNTY

DATE	02/08/2021

RF	EVISION ROUNDS	DWG NO.	DESCRIPTION
	TOTAL ROOMES		CONSTRUCTION PLANS
<u></u>	2	01-0001	COVER
1	<u>^2</u>	02-0001	INDEX
<u></u>	<u>^2</u>	04-0001 TO 04-0002	GENERAL NOTES & LEGENDS
		03-0000	TOPOGRAPHIC SURVEY: COMPOSITE MAP
		03-0001 TO 03-0004	TOPOGRAPHIC SURVEY
<u>^</u> î\	<u>^2</u>	05-0001	TYPICAL SECTIONS
<u>^1</u>	2	09-0001	DETAILED ESTIMATE
^		10 202	
$\frac{\hat{1}}{\hat{1}}$		10-0001	TRAFFIC CONTROL PLANS
<u> </u>		10-0002	TRAFFIC CONTROL DETAIL
<u>^1</u>	2	13-0001 TO 13-0004	MAINLINE PLANS
		15-0001 TO 15-0004	MAINLINE PROFILE
		23-0001 TO 23-0003	CROSS-SECTIONS
<u></u>		24-0000	UTILITY NOTES AND LEGEND
<u></u>	<u>/2</u> \	24-0001 TO 24-0004	UTILITY PLANS
		26-0000	SIGNING AND MARKING NOTES AND DETAILS
	<u>^2</u>	26-0001 TO 26-0004	SIGNING AND MARKING PLANS
<u></u>	<u>^2</u>	29-0000	LANDSCAPE NOTES, DETAILS, AND PLANT SCHEDULE
1	2	29-0001 TO 29-0004	LANDSCAPE AND TREE PROTECTION PLANS
			RETAINING WALL PLANS
		32-0001	GENERAL NOTES AND SECTION DETAILS
		32-0002	WALL #1 PLAN VIEW
		32-0003	WALL #2 PLAN & SECTION DETAIL
		32-0004	WALL #2 PLAN & SECTION DETAIL
			SPECIAL CONSTRUCTION DETAILS
<u> </u>	<u> </u>	38-0001 TO 38-0004	SPECIAL CONSTRUCTION DETAILS
<u>^1</u>		40-0001 TO 40-0002	GDOT STANDARD DETAILS
			EROSION CONTROL PLANS
<u> </u>	<u>^2</u>	51-0001 TO 51-0004	EROSION, SEDIMENTATION & POLLUTION CONTROL PLAN
<u> </u>	<u>^2</u>	51-0005	EROSION CONTROL CHECKLIST
$\frac{\hat{1}}{\hat{1}}$	2	51-0006	EROSION CONTROL BMP
1	2	56-0007 TO 51-0009	EROSION CONTROL DETAILS



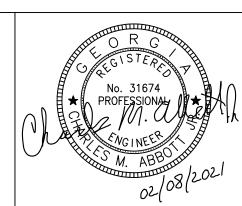



CHARLES M. ABBOTT JR, P.E.

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Brookhaven
DONALD SHERRILL - PUBLIC WORKS
DEPUTY DIRECTOR
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O: 404-991-4763 C: 404-637-0682

REVISION DAT	ES	STATE OF GEORGIA	Λ TI (
100% ISSUE FOR PERMIT	11/20/2020	DEPARTMENT OF TRANSPORTA OFFICE: DISTRICT 7	ATION
REV. 1 CITY COMMENTS	01/11/2021	OFFICE. DISTRICT /	
2 REV. 2 AGENCY COMMENTS	02/08/2021	INDEX	
		N.E. EXPRESSWAY FRONTAGE ROAD	DRAWING No.
		MUTI-USE PATH	02-0001

PROJECT NUMBER

2020-205

COUNTY DEKALB

COUNTY PROJECT NUMBER DEKALB 2020-205

GENERAL NOTES

1. PROPOSED CONTOURS AND SPOT ELEVATIONS REPRESENT FINAL GRADE. PROPOSED GRADE ELEVATIONS SHOWN WITHIN PAVED AREA REPRESENT TOP OF PAVEMENT ELEVATIONS. CONTRACTOR SHALL ALLOW FOR PAVEMENT THICKNESS, TOPSOIL, BASE COURSE, SLABS, ETC. WHEN GRADING TO SUBGRADE ELEVATIONS

2. DIMENSIONS ARE TO FACE OF CURB, CENTER OF STRUCTURE AND CENTER LINE OF COLUMN LINE, UNLESS OTHERWISE NOTED. ANGLES SHOWN ON STORM AND SANITARY SEWER ARE TO CENTER OF PIPE, UNLESS OTHERWISE NOTED.

3. CALL BEFORE YOU DIG 811. THE LOCATIONS OF EXISTING UTILITIES ARE APPROXIMATE AND SHALL BE VERIFIED BY THE CONTRACTOR PRIOR TO BEGINNING CONSTRUCTION. BEWARE OF HIDDEN UTILITIES NOT SHOWN. CONTRACTOR SHALL BE RESPONSIBLE FOR CONTACTING APPROPRIATE UTILITY COMPANIES PRIOR TO EXCAVATION. IF UNCHARTED UTILITIES ARE ENCOUNTERED DURING EXCAVATION OPERATIONS, THE CONTRACTOR SHALL NOTIFY THE PROJECT ENGINEER IMMEDIATELY FOR INSTRUCTIONS. ANY DAMAGE OR INTERRUPTION OF EXISTING UTILITIES SHALL BE THE SOLE RESPONSIBILITY OF THE CONTRACTOR AND SHALL BE REPAIRED PROMPTLY AT THE CONTRACTOR'S EXPENSE.

4. PRIOR TO COMMENCING LAND DISTURBANCE ACTIVITY, THE LIMITS OF LAND DISTURBANCE SHALL BE CLEARLY AND ACCURATELY DEMARCATED WITH STAKES, RIBBONS, OR OTHER APPROPRIATE MEANS. THE LOCATION AND EXTENT OF ALL AUTHORIZED DISTURBANCE SHALL BE DEMARCATED FOR THE DURATION OF THE CONSTRUCTION ACTIVITY. NO DISTURBANCE SHALL OCCUR OUTSIDE THE LIMITS INDICATED ON THE DRAWINGS WITHOUT APPROVAL IN WRITING FROM THE PROJECT ENGINEER.

5. TEMPORARY TRAFFIC CONTROL AND WARNING DEVICES SHALL BE PLACED PRIOR TO THE COMMENCEMENT OF ANY ROADWAY IMPROVEMENT WORK ON CITY ROADS AND SHALL REMAIN IN PLACE UNTIL THE CONCLUSION OF ALL SIGNING AND STRIPPING WORK.

6. THROUGHOUT CONSTRUCTION, THE CONTRACTOR SHALL PROVIDE AND MAINTAIN SUFFICIENT BARRICADES, LIGHTS, WARNING SIGNS, AND OTHER TRAFFIC CONTROL METHODS ADJACENT TO EXISTING ROADWAYS AND PARKING AREAS AS MAY BE REQUIRED FOR THE PROTECTION AND SAFETY OF THE PUBLIC. ALL TRAFFIC CONTROL MEASURES UTILIZED WITHIN PUBLIC RIGHT-OF-WAY SHALL COMPLY WITH MANUAL FOR UNIFORM TRAFFIC CONTROL DEVICES (MUTCD), CURRENT EDITION.

7. THE CONTRACTOR SHALL BE RESPONSIBLE FOR THE LAYOUT OF ALL CONSTRUCTION ELEMENTS, WITH SOME FIELD ADJUSTMENTS ALLOWED AS NECESSARY WITH PRIOR APPROVAL GIVEN BY THE ENGINEER. IN ADDITION, THE CONTRACTOR SHALL BE RESPONSIBLE FOR INSURING THAT TRAIL AND AMENITY CONSTRUCTION COMPLIES WITH AASHTO REQUIREMENTS, PARTICULARLY WITH RESPECT TO TRAIL CROSS-SLOPES AND GRADIENTS.

8. THE CONTRACTOR SHALL BE RESPONSIBLE FOR TEMPORARY AND PERMANENT GROUNDWATER CONTROL DURING CONSTRUCTION, AS WELL AS PROVISIONS FOR CONTROLLING SURFACE WATER RUN-OFF, IN ORDER TO PREVENT PONDING IN OPEN EXCAVATIONS AND POTENTIAL UNDERMINING OF PERMANENT CONSTRUCTION FEATURES.

9. EARTHWORK OPERATIONS AND SOIL COMPACTION SHALL BE PERFORMED IN STRICT ACCORDANCE WITH THE PROJECT SPECIFICATIONS AND DRAWINGS. PRIOR TO POURING CONCRETE, EARTHWORK SHALL BE CLEAR OF DEBRIS AND MACHINE COMPACTED. CONSTRUCTION ACTIVITIES SHALL BE MONITORED BY A GEOTECHNICAL CONSULTING FIRM APPROVED BY THE OWNER TO VERIFY THAT EARTHWORK, WALL CONSTRUCTION, AND OTHER OPERATIONS CONFORM WITH THE CONTRACT DOCUMENTS. GEOTECHNICAL SERVICES SHALL BE AT THE COST OF THE CONTRACTOR.

10. THE TOPOGRAPHIC SURVEY INFORMATION HAS BEEN PROVIDED BY PLATINUM GEOMETRICS, (404) 295-8653, AND IS REFERENCED TO THE GEORGIA STATE PLANE COORDINATE SYSTEM (WEST ZONE).

11. DEMOLITION DEBRIS SHALL BECOME PROPERTY OF THE CONTRACTOR AND WASTE SOILS, VEGETATION, AND OTHER DELETERIOUS MATERIALS SHALL BE HAULED OFF-SITE AND BE DISPOSED OF AT AN APPROVED LOCATION IN ACCORDANCE WITH LOCAL, STATE, AND FEDERAL REGULATIONS. BURNING WILL NOT BE ALLOWED ON THIS PROJECT.

12. EROSION CONTROL MEASURES AND OTHER SITE ISSUES SHALL BE INSPECTED AS REQUIRED BY NPDES PERMITTING BY CONTRACTOR.

13. ON ALL AREAS WHERE ROADWAYS, CONCRETE TRAILS, RETAINING WALLS, OR OTHER STRUCTURES ARE TO BE CONSTRUCTED ON COMPACTED SUBGRADE, FOUNDATION SOILS SHALL BE REVIEWED AND APPROVED BY THE GEOTECHNICAL CONSULTING FIRM PRIOR TO THE PLACEMENT OF CONCRETE, AGGREGATE BASE, OR FILL MATERIALS.

14. CONSTRUCTION ACCESS POINTS ARE APPROXIMATE LOCATIONS AND MUST BE FIELD VERIFIED AND APPROVED BY CITY OF BROOKHAVEN.

15. ALL WORK TO BE DONE IN ACCORDANCE WITH THE 2013 STANDARD SPECIFICATIONS AND 2016 SUPPLEMENTAL SPECIFICATIONS OF THE GEORGIA DEPARTMENT OF TRANSPORTATION, AND AS MODIFIED BY CONTRACT DOCUMENTS.

16. ALL CONCRETE TO BE USED FOR THE CONSTRUCTION OF TRAILS TO BE 3000 PSI CONCRETE.

17. CONTRACTOR SHALL SCHEDULE A PRE-CONSTRUCTION MEETING WITH CITY OF BROOKHAVEN AND KAIZEN COLLABORATIVE PRIOR TO BEGINNING CONSTRUCTION. CONTRACTOR SHALL REQUEST CAD STAKING DATA FROM ENGINEER UPON AWARD OF CONTRACT.

18. NOTICE: IT IS THE OWNER'S RESPONSIBILITY TO COMPLY WITH ALL ENVIRONMENTAL IMPACT ISSUES AND TO OBTAIN ALL NECESSARY PERMITS FROM THE APPROPRIATE GOVERNING AUTHORITIES.

19. IF THE PROPERTY OWNER ADDS LIGHTING IN THE FUTURE TO THE PROJECT, ALL LIGHTS MUST BE INSTALLED ON PRIVATE PROPERTY AND MAINTAINED BY THE PROPERTY OWNER.

TRAIL NOTES

1. THE CONTRACTOR IS RESPONSIBLE FOR MAINTAINING MINIMUM SLOPES ALONG THE TRAIL. THE SLOPES SHALL NOT EXCEED 8.33% PERCENT FOR 200 LF, UNLESS SPECIFICALLY NOTED.

2. THE LAYOUT OF THE TRAIL IS SHOWN IN RELATION TO THE BEST AVAILABLE INFORMATION. THE CONTRACTOR SHALL VERIFY THE LAYOUT WITH OWNER PRIOR TO CONSTRUCTION OF TRAIL.

3. THE CONTRACTOR IS RESPONSIBLE FOR VERTICAL & HORIZONTAL CLEARING OF ALL UNDER-STORY VEGETATION WITHIN 10' OF TRAIL. CLEARING AREA MAY INCREASE WHERE INVASIVE PLANTS ARE LOCATED. CONTRACTOR SHALL CONFIRM VEGETATION TO BE CLEARED WITH PROJECT ENGINEER PRIOR TO CLEARING.

4. ALL SIGNING & MARKING SHALL BE IN ACCORDANCE WITH THE MANUAL ON UNIFORM TRAFFIC CONTROL DEVICES (MUTCD), LATEST EDITION.

5. ALL ROAD PAVEMENT MARKING SHALL BE THERMOPLASTIC UNLESS OTHERWISE NOTED ON PLANS.

6. WHEN NECESSARY, EXISTING STRIPING SHALL BE REMOVED BY GRINDING, UNLESS SPECIFIED BY BROOKHAVEN TRAFFIC ENGINEER.

CONSTRUCTION NOTES

1. TRAIL BACKFILL DIRT SHALL BE CLEAN, COHESIVE CLAY OR SANDY CLAY FREE OF DEBRIS, ORGANICS, DELETERIOUS MATERIAL AND ROCKS GREATER THAN 3" DIAMETER.

2. DESIRABLE GRADED SLOPES ARE TO BE 3:1 (H:V) OR FLATTER. MAX CUT OR FILL SLOPES SHALL BE 2:1 (H:V), UNLESS SPECIFICALLY NOTED.

3. EQUIPMENT AND MATERIALS SHALL BE STORED IN AREAS DESIGNATED BY THE OWNER. CONSTRUCTION AND STORAGE AREAS SHALL BE KEPT NEAT AND CLEAN. TREE SAVE AREAS SHALL NOT BE USED FOR STORAGE OR PARKING. EQUIPMENT AND MATERIAL SHALL NOT BE STORED WITHIN THE DRIP LINE OF TREES.

4. CONTRACTOR TO VERIFY THE ELEVATIONS OF ALL TIE-IN POINTS FOR INSTALLATION OF UTILITIES, CURB & GUTTER AND PAVING.

5. TRENCH BACKFILL MATERIAL SHALL BE COMPACTED TO NOT LESS THAN 95% OF THE OPTIMUM COMPACTION FOR ANY SOIL CLASSIFICATION AS DETERMINED BY THE STANDARD PROCTOR TEST AASHTO T-180 METHOD "A". THE TOP 2 FEET OF ALL AREAS TO RECEIVE PAVEMENT SHALL BE COMPACTED TO 100% STANDARD PROCTOR DENSITY. BACKFILL MATERIAL SHALL BE CLEAN AND FREE OF ROOTS, ROCK OR DELETERIOUS MATTER. CONTRACTOR SHALL CORRECT ANY DAMAGE TO CURBING OR PAVING CAUSED BY TRENCH SETTLEMENT WHICH OCCURS WITHIN 12 MONTHS OF PROJECT ACCEPTANCE.

6. THE CONTRACTOR SHALL NOTIFY THE ENGINEER OF ANY DISCREPANCIES BETWEEN PLAN AND FIELD CONDITIONS PROMPTLY UPON DISCOVERY.

7. ALL EXISTING ELECTRICAL BOXES, WATER METER BOXES, AND VALVE BOXES THAT ARE TO REMAIN SHALL BE SET FLUSH WITH THE TOP OF THE PROPOSED GRADE.


8. AREAS INTENDED TO SUPPORT PAVEMENT OR NEW FILL SHALL BE PROOF ROLLED IN THE PRESENCE OF THE GEOTECHNICAL PROJECT MANAGER. PROJECT MANAGER MAY REQUEST A GEOTECHNICAL ENGINEER IF SOILS ARE DETERMINED UNSUITABLE. AREAS WHICH PUMP WHILE PROOF ROLLED SHALL BE UNDERCUT AND BACK-FILLED AS DIRECTED BY GEOTECHNICAL ENGINEER.

9. GRADED AGGREGATE BASE COURSE IN PAVEMENT BASE SHALL CONFORM WITH SECTION 815 OF THE STATE OF GEORGIA, DEPARTMENT OF TRANSPORTATION, STANDARD SPECIFICATIONS. ALL ASPHALT MATERIAL AND PAVING OPERATIONS SHALL MEET APPLICABLE SPECIFICATIONS OF THE GEORGIA DEPARTMENT OF TRANSPORTATION.

10. ALL FILL AREAS MUST BE COMPACTED TO A MINIMUM 95% STANDARD PROCTOR. THE TOP 2 FEET OF ALL AREAS TO RECEIVE PAVEMENT SHALL BE COMPACTED TO 100% STANDARD PROCTOR DENSITY. A REPORT FROM A GEOTECHNICAL ENGINEER WILL BE REQUIRED FOR ALL FILL AREAS WITHIN THE RIGHT-OF-WAY.

11. CONTRACTOR SHALL ENSURE POSITIVE DRAINAGE ACROSS DISTURBED AREA AND INTO DRAINAGE FEATURES.



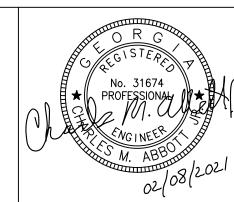

PLANS PREPARED BY:

KAIZENCOLLABORATIVE

2390 Main Street | Tucker, GA 30084 | 404.239.2521

CHARLES M. ABBOTT JR, P.E.

PEGICAL FAIGURES DE SENTINGATION

CHARLES M. ABBOTT JR, P.E.

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GSWCC # 0000041686 EXPIRES: 04/13/2022
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CITY OF BROOKHAVEN

DONALD SHERRILL - PUBLIC WORKS

DEPUTY DIRECTOR

4362 PEACHTREE RD., BROOKHAVEN, GA 30319

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REVISION DATES

100% ISSUE FOR PERMIT

11/20/2020

1 REV. 1 CITY COMMENTS

01/11/2021

2 REV. 2 AGENCY COMMENTS

02/08/2021

N.E

DEPARTMENT OF TRANSPORTATION
OFFICE: DISTRICT 7

STATE OF GEORGIA

GENERAL NOTES & LEGENDS

N.E. EXPRESSWAY FRONTAGE ROAD

MUTI-USE PATH

DRAWING No. 04-001

COUNTY PROJECT NUMBER DEKALB 2020-205

SITE DATA

TOTAL SITE AREA = 0.7 ACRES
DISTURBED AREA = 0.7 ACRES

NPDES FEE = NOT APPLICABLE <1 ACRE STATE AMOUNT = N/A CITY AMOUNT = N/A

CONTACTS


PRIMARY CONTACTS:

CITY OF BROOKHAVEN
DONALD SHERRILL - M-F 8:00 AM - 5:00 PM
DON.SHERRILL@BROOKHAVENGA.GOV
Office 404-637-0682 Cell 404-991-4763


EROSION & SEDIMENT CONTROL


- 1. THE ESCAPE OF SEDIMENT FROM THE SITE SHALL BE PREVENTED BY THE INSTALLATION OF EROSION AND SEDIMENT CONTROL MEASURES AND PRACTICES PRIOR TO, OR CONCURRENT WITH, LAND DISTURBANCE ACTIVITIES.
- 2. EROSION CONTROL MEASURES WILL BE MAINTAINED AT ALL TIMES. IF FULL IMPLEMENTATION OF THE APPROVED PLAN DOES NOT PROVIDE FOR EFFECTIVE EROSION CONTROL, ADDITIONAL EROSION AND SEDIMENT CONTROL MEASURES SHALL BE IMPLEMENTED TO CONTROL OR TREAT THE SEDIMENT SOURCE.
- 3. ANY DISTURBED AREA LEFT EXPOSED FOR A PERIOD GREATER THAN 14 DAYS SHALL BE STABILIZED WITH MULCH OR TEMPORARY SEEDING.
- 4. ADDITIONAL EROSION AND SEDIMENT CONTROL MEASURES AND PRACTICES WILL BE INSTALLED IF DEEMED NECESSARY BY THE ON-SITE INSPECTOR.
- 5. EROSION AND SEDIMENT MEASURES AND PRACTICES TO BE INSPECTED DAILY.
- 6. ALL INSPECTION, MONITORING, AND REPORTING SHALL BE PERFORMED AS REQUIRED BY NPDES PERMIT AND BY PROJECT EROSION, SEDIMENTATION, AND POLLUTION CONTROL NOTES.

(SEE EROSION CONTROL SHEETS FOR EROSION CONTROL CONSTRUCTION SCHEDULE)

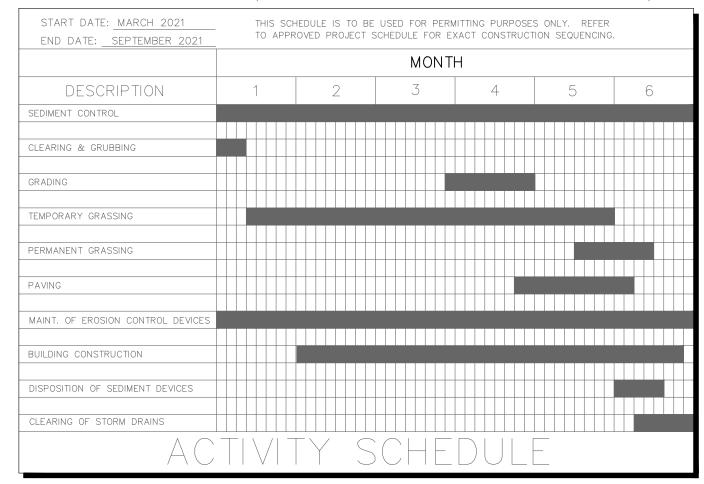


CONSTRUCTION LEGEND

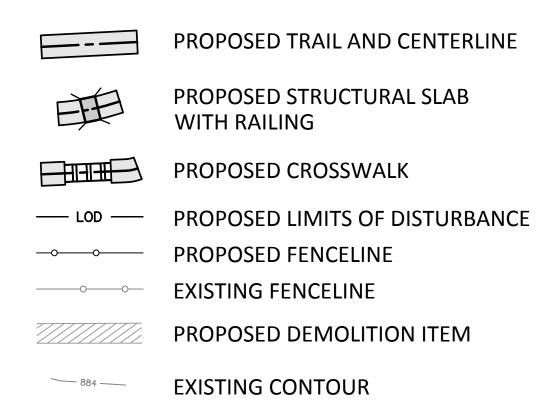

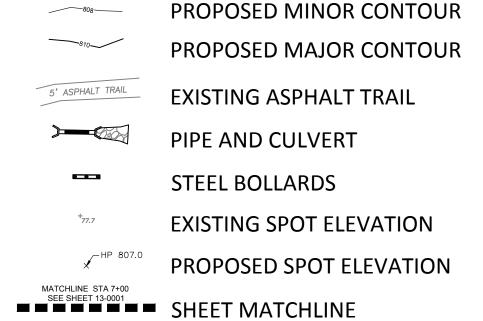

----- PROPERTY LINE

		LEGEND		
1033 CATCH BASIN 1034 CATCH BASIN 1019A DROP INLET 1011A JUNCTION BOX 1019A TYPE E CURB INLE 1125 HEADWALL DRAINAGE SLOPE SEWER MANHOLE EXISTING FIRE HYDRANT	—UGP— —P— —UGC— —T— —FOC— —W—	WATER VALVE GAS VALVE HANDICAPPED PARKING TRAFFIC FLOW UNDERGROUND POWER OVERHEAD POWER UNDERGROUND CABLE OVERHEAD TELEPHONE FIBER OPTIC CABLE WATER	—SF— —TP— —0—0— —X—X— —100— —100—	SILT FENCE TREE PROTECTION FENCE CHAIN LINK FENCE EXISTING FENCE EXISTING CONTOUR PROPOSED CONTOUR EXISTING CURB & GUTTER PROPOSED CURB & GUTTER
PROPOSED FIRE HYDRAN' LAMP POST GUY POLE	—SS— —FM—	SANITARY SEWER FORCE MAIN GAS	X 1010 ⊗ 1010	EXISTING SPOT ELEVATION PROPOSED SPOT ELEVATION

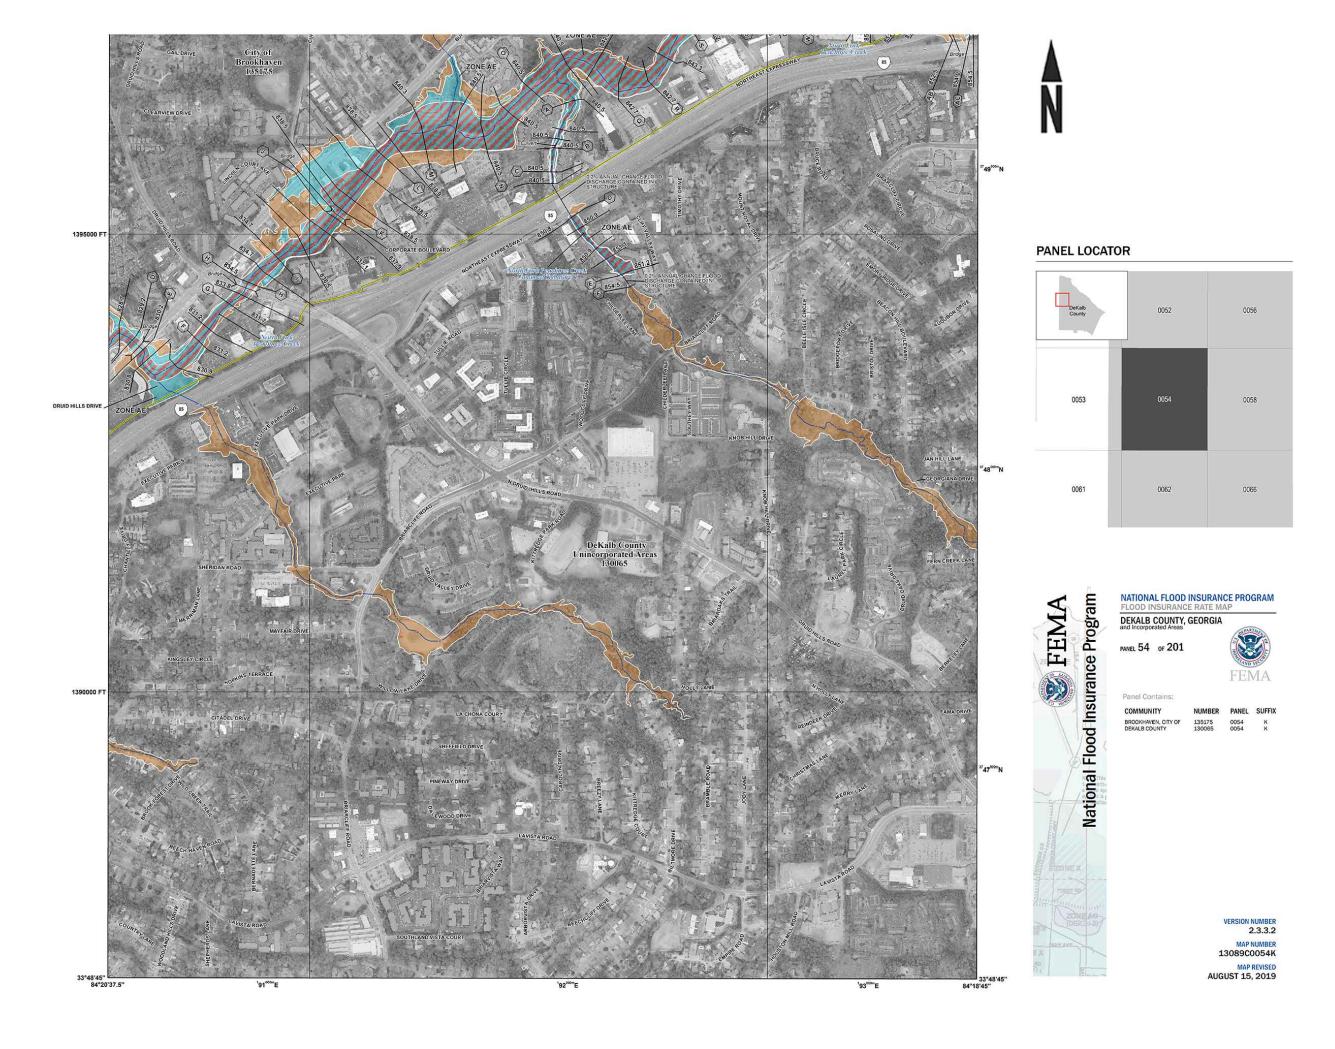


F.E.M.A. F.I.R.M. MAP SCALE: N.T.S.

THIS IS AN OFFICIAL COPY OF A POTION OF THE ABOVE REFERENCE FLOOD MAP. IT WAS EXTRACTED USING F-MIT ON-LINE. THIS MAP DOES NOT REFLECT CHANGES OR AMENDMENTS WHICH MAY HAVE BEEN MADE SUBSEQUENT TO THE DATE ON THE TITLE BLOCK. FOR THE LATEST PRODUCT INFORMATION ABOUT NATIONAL FLOOD INSURANCE PROGRAM FLOOD MAPS CHECK THE FEMA FLOOD MAP STORE AT www.msc.fema.gov



Know what's **below. Call** before you dig.



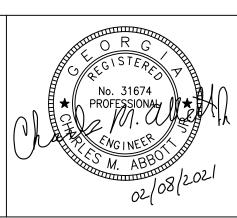

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	DONALD SHERRILL - PUBLIC WORKS
Von	DEPUTY DIRECTOR
ven	4362 PEACHTREE RD., BROOKHAVEN, GA 30319
	E: DON.SHERRILL@BROOKHAVENGA.GOV
	O: 404-991-4763 C: 404-637-0682

REVISION DA	11/20/2020
REV. 1 CITY COMMENTS	01/11/2021
REV. 2 AGENCY COMMENTS	6 02/08/2021

STATE OF GEORGIA DEPARTMENT OF TRANSPORTATION OFFICE: DISTRICT 7

GENERAL NOTES & LEGENDS

I.E. EXPRESSWAY FRONTAGE ROAD

MUTI-USE PATH

DRAWING No. 04-002



Legend

Property Corner Found

1/2"Rebar with Cap Set

Concrete Right-of-way Monument Found

Un-Monumented Angle Break

Not to Scale

Electric Marker

Electric Box

E

Sanitary Sewer Manhole

Storm Manhole

Storm Drop Inlet

Survey Control

Light Pole

Water Line Marker

Water Valve

Fire Hydrant


Communication Line Marker

Communication Box

Paint Striping

Chain Link Fence X — X — Rip Rap Underground Water Supply Line — X

Wisinita Man (Not to Co

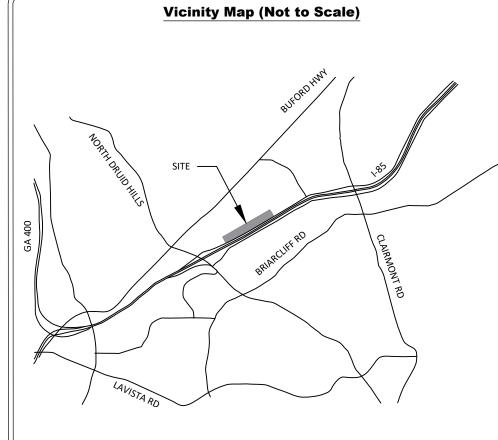


Surveyor's Certification

This is a topographic map derived from a field survey that was performed under my direct supervision that was checked and found to be accurate to support 1 foot contours. This map does not constitute a boundary survey and should not be used to convey property.



Byron T Freeman, GA RLS #3184 D

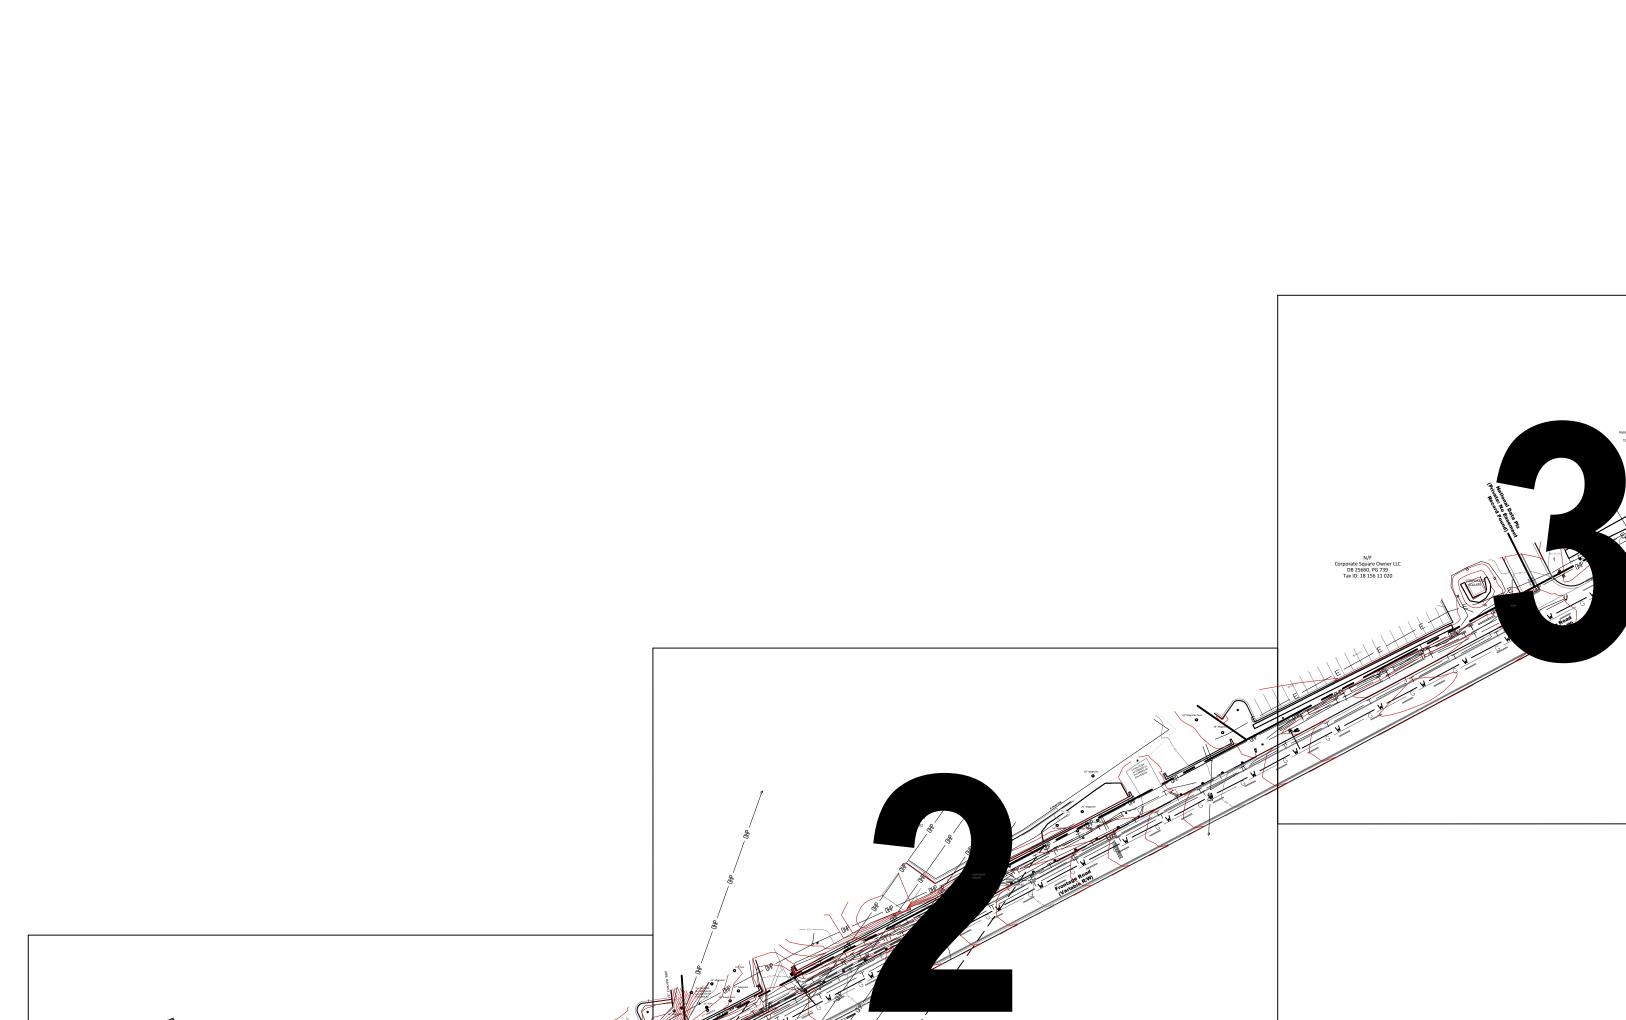

PLATINUM geomatics



SSWay Broom

theast Express

Land District:

Land District:

City, County, & State:

City of Brookhaven,

Dekalb County, Georgia

Units of Measurment:

U.S. Survey Foot

 Revision
 April 2020

 Date of Plat Preparation:
 Land District:

 October 2nd, 2020
 City, County, & Statt

 Approved By:
 B Freeman
 Dek


 Platinum Geomatics Project No:
 Units of Measurmer


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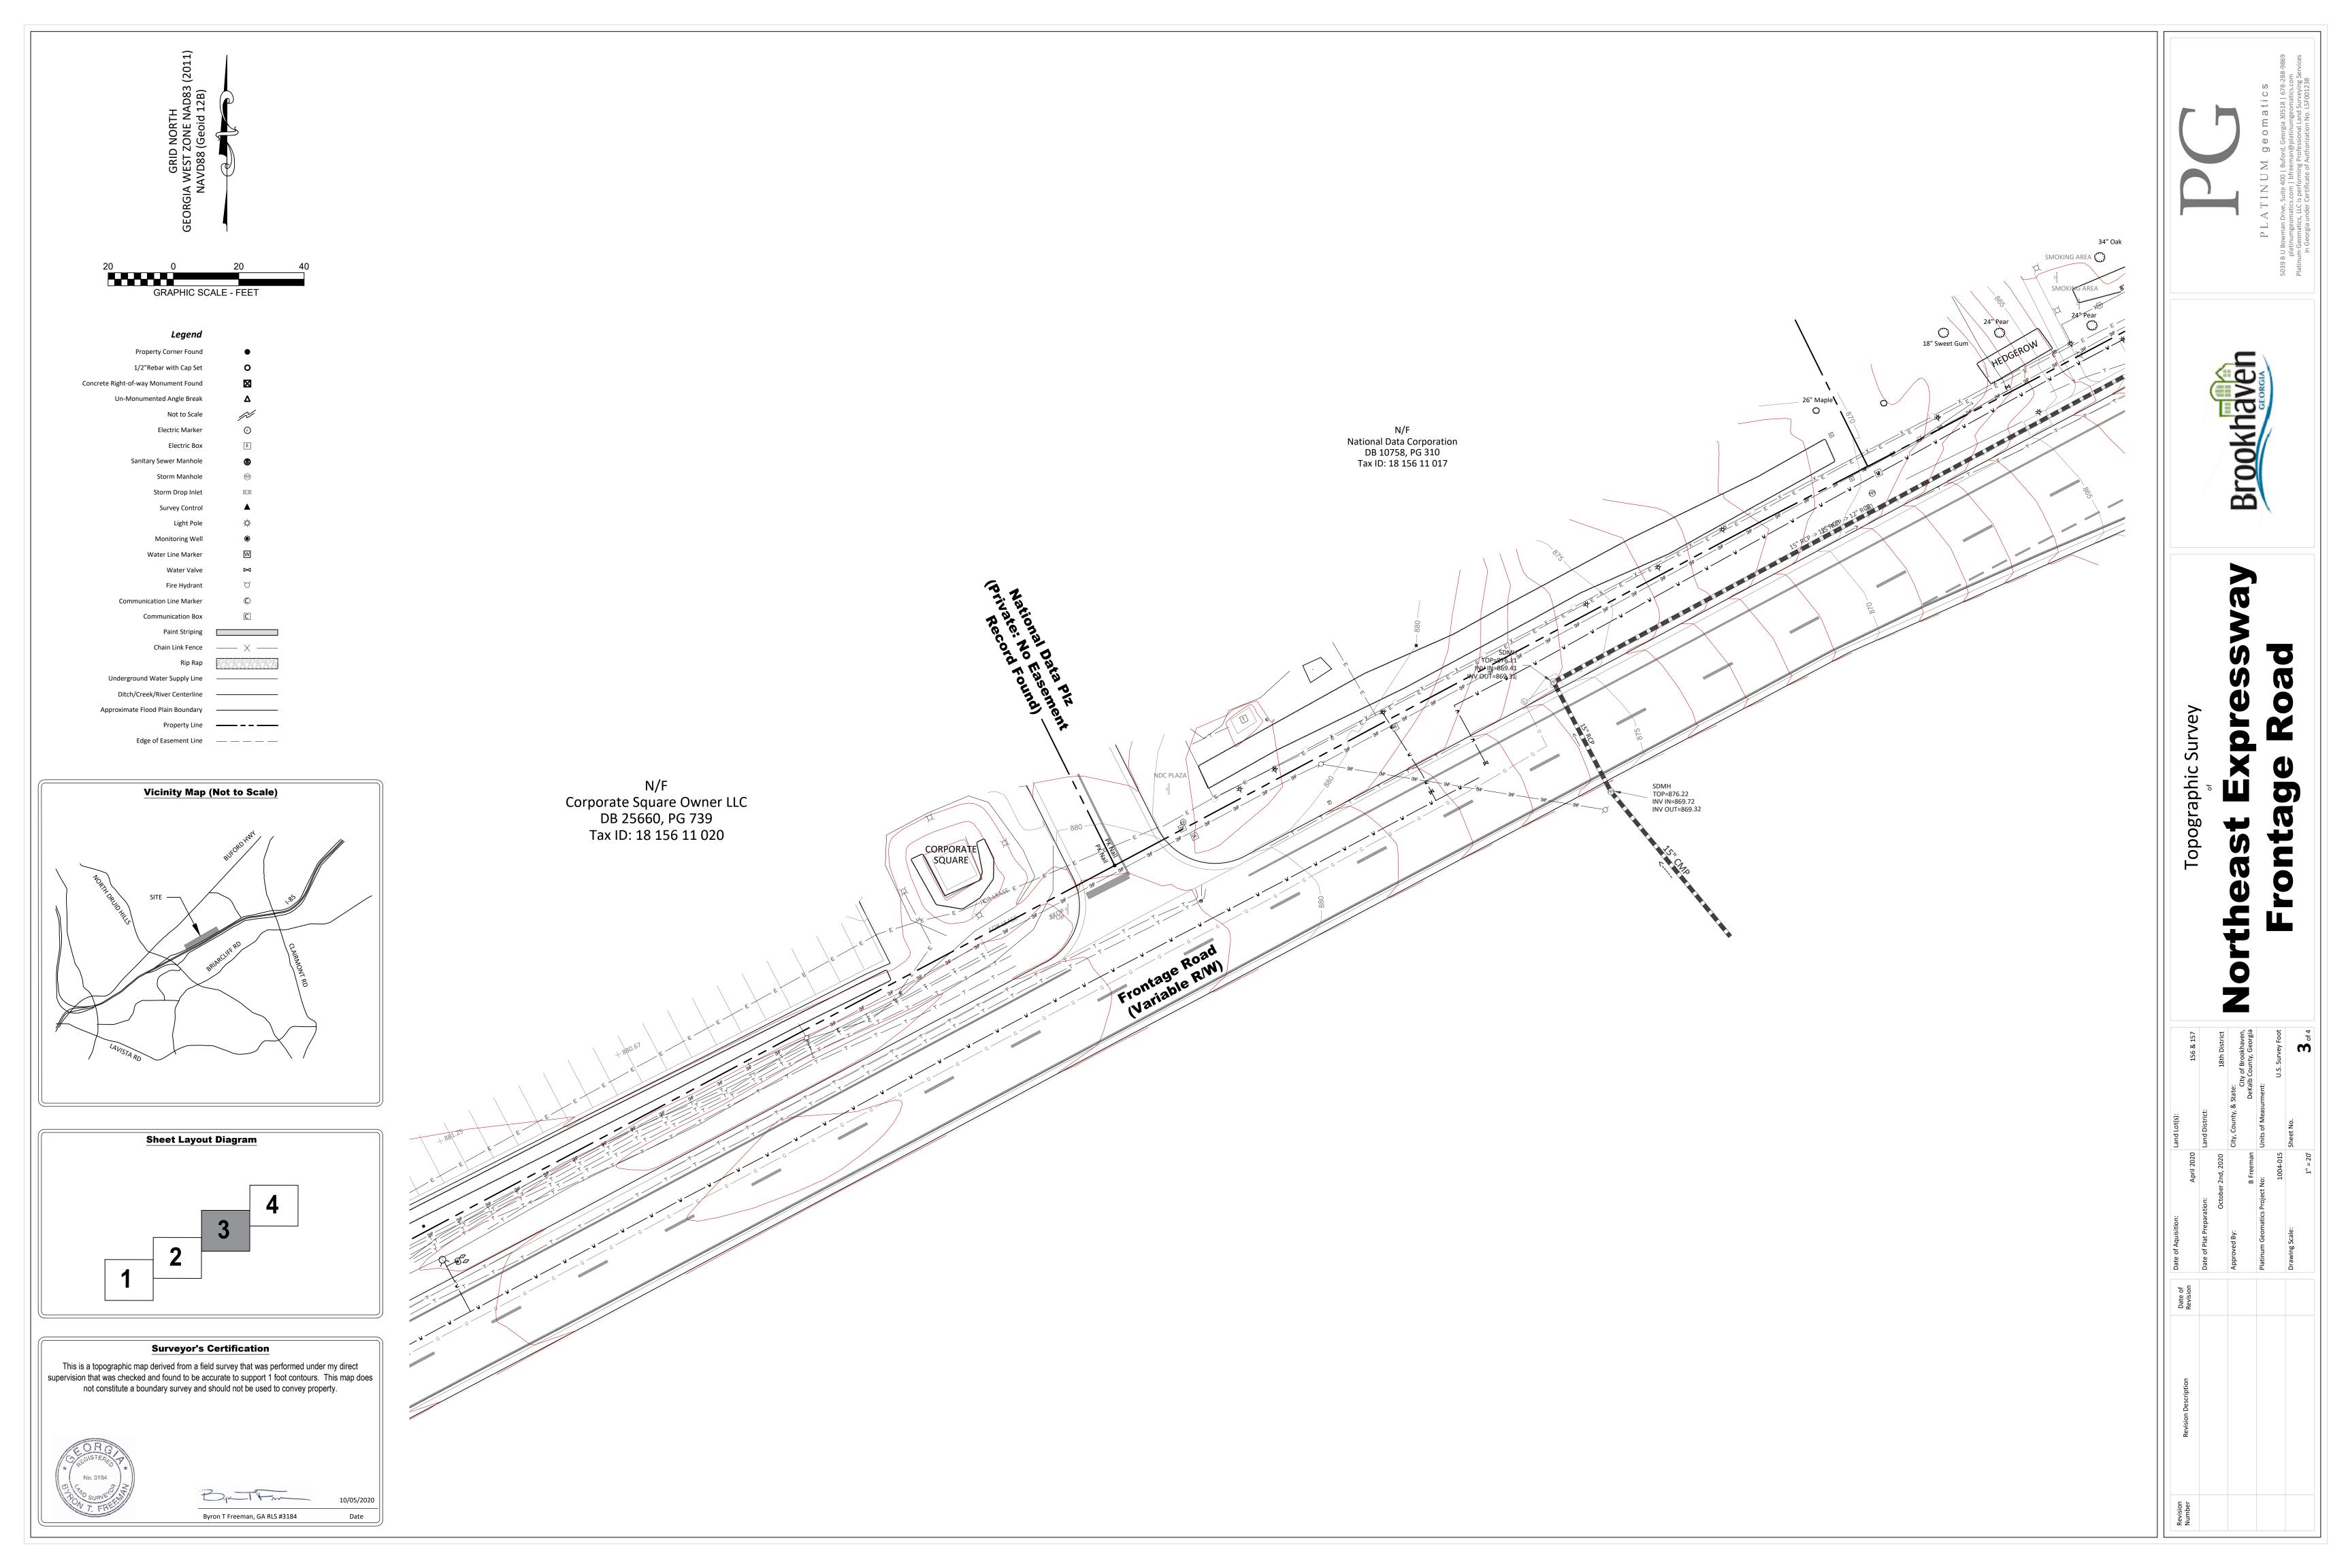
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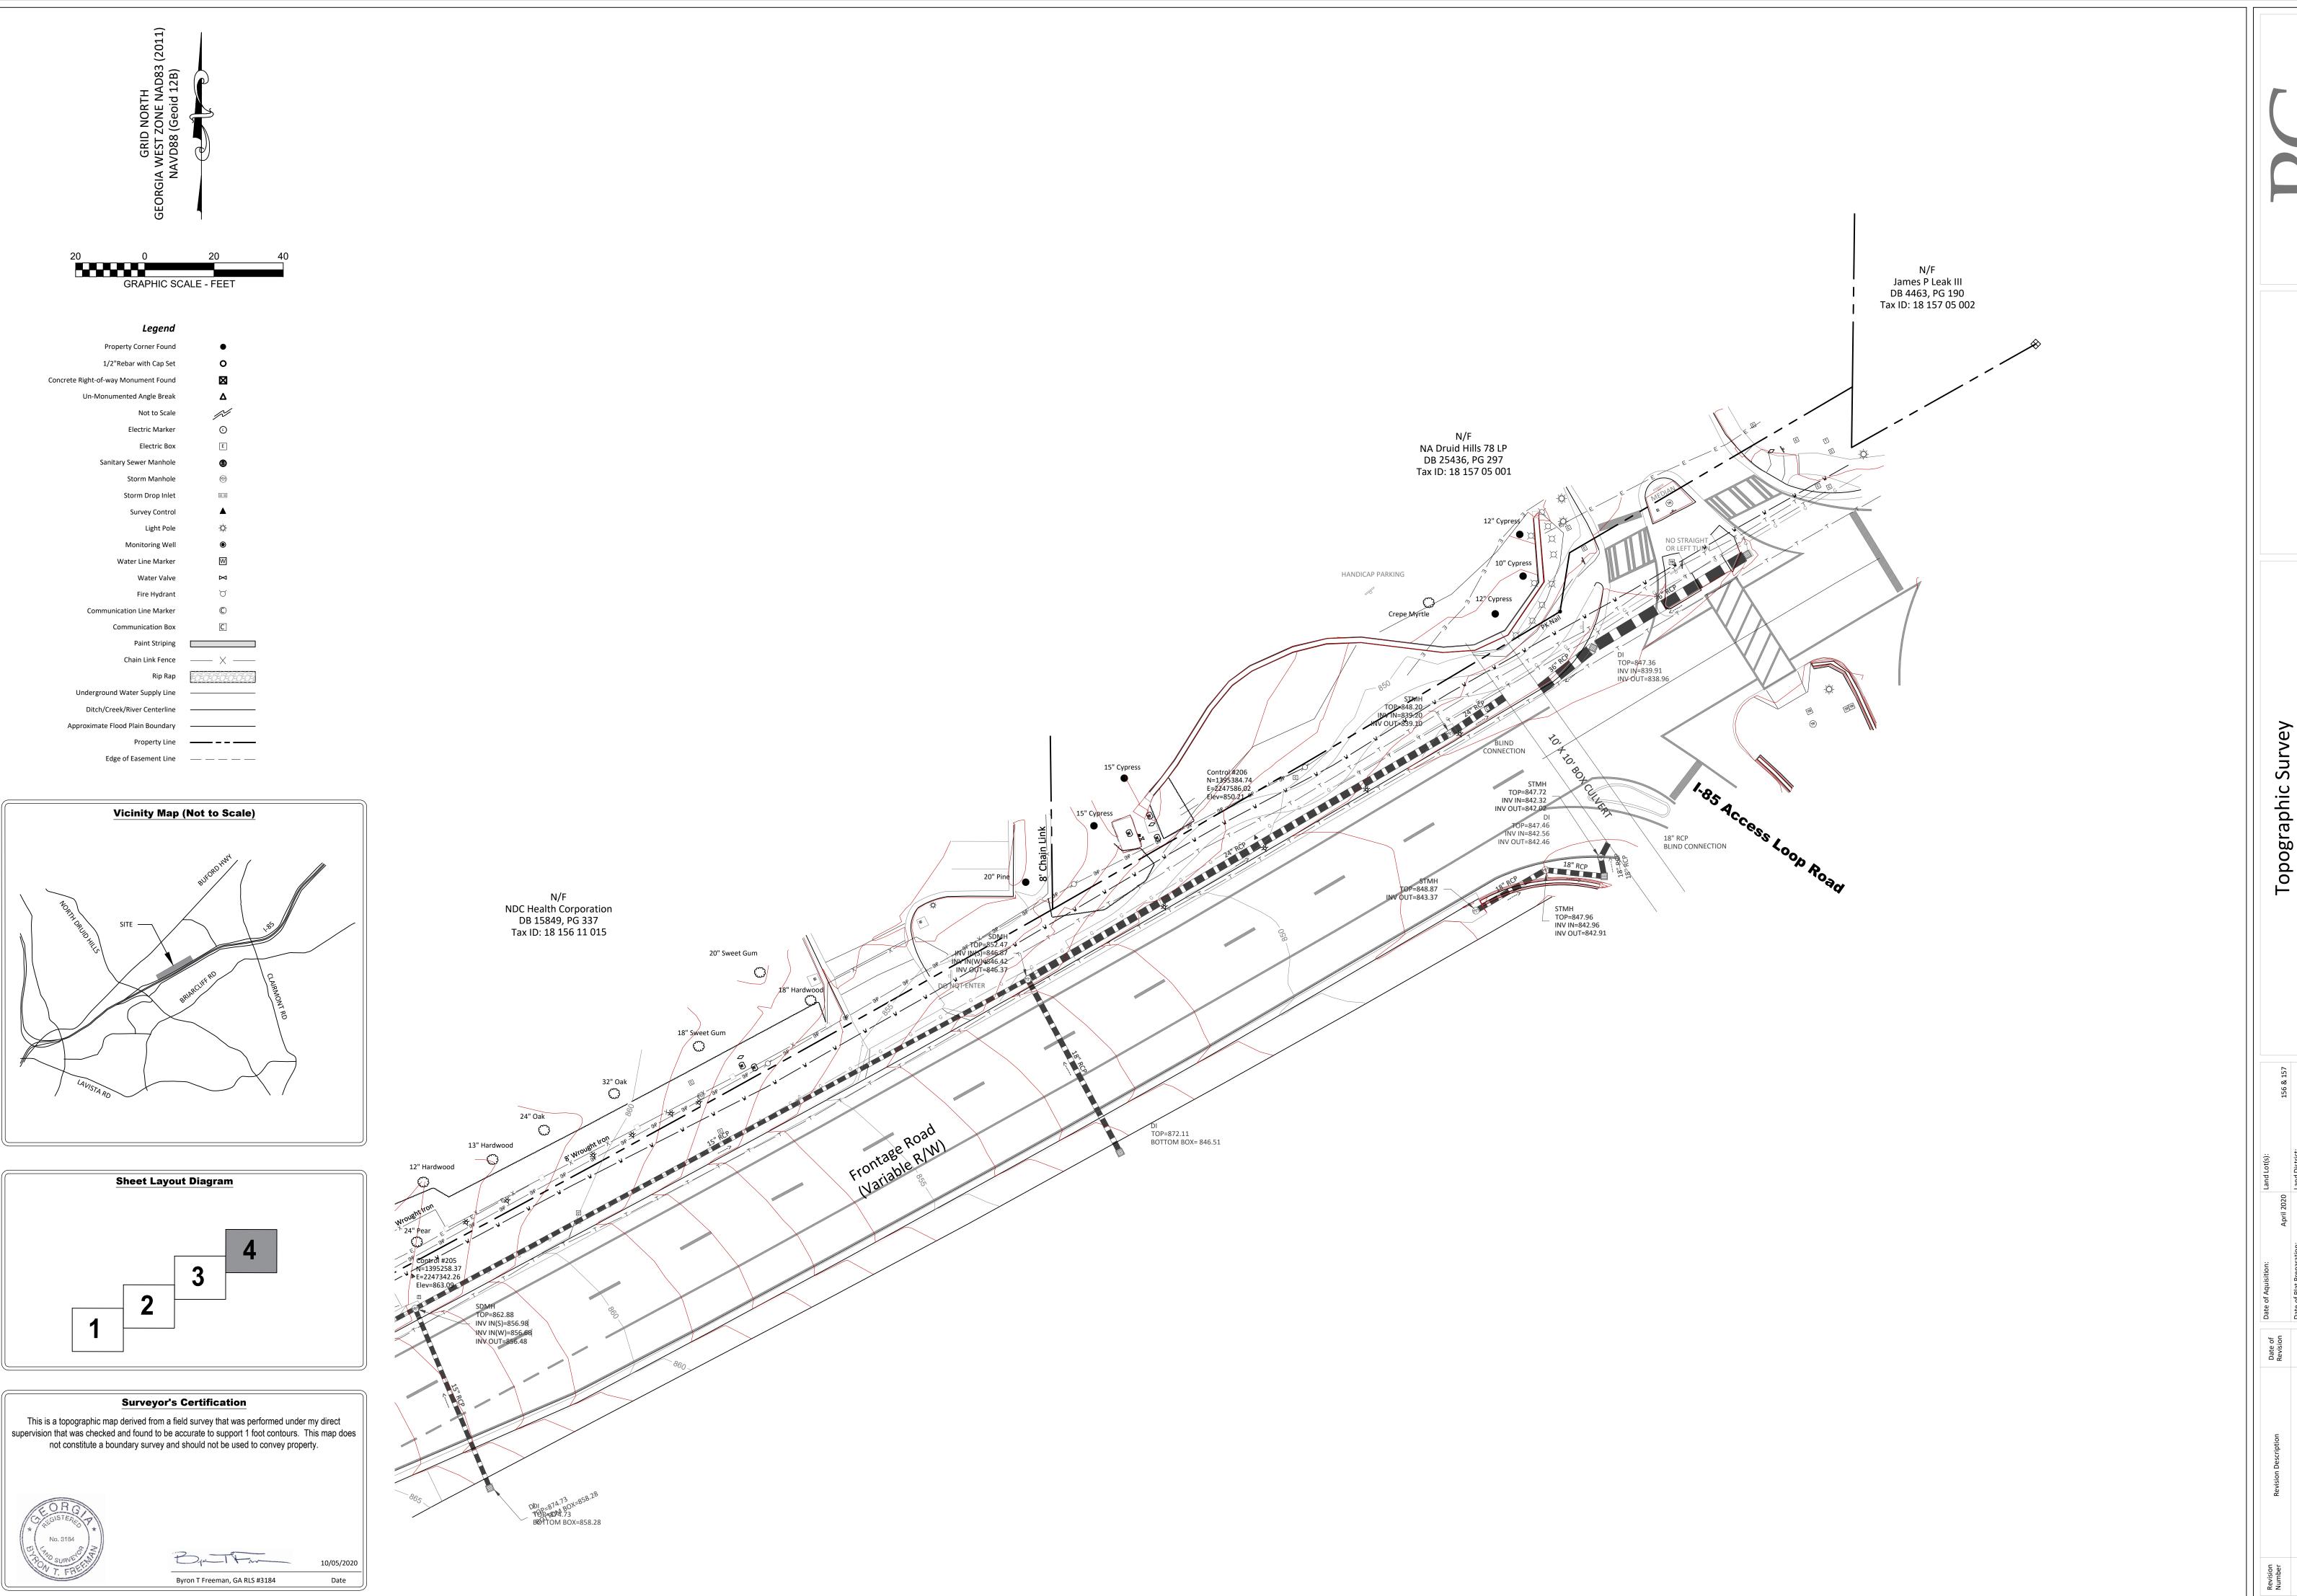
Revision

Date of
Approve





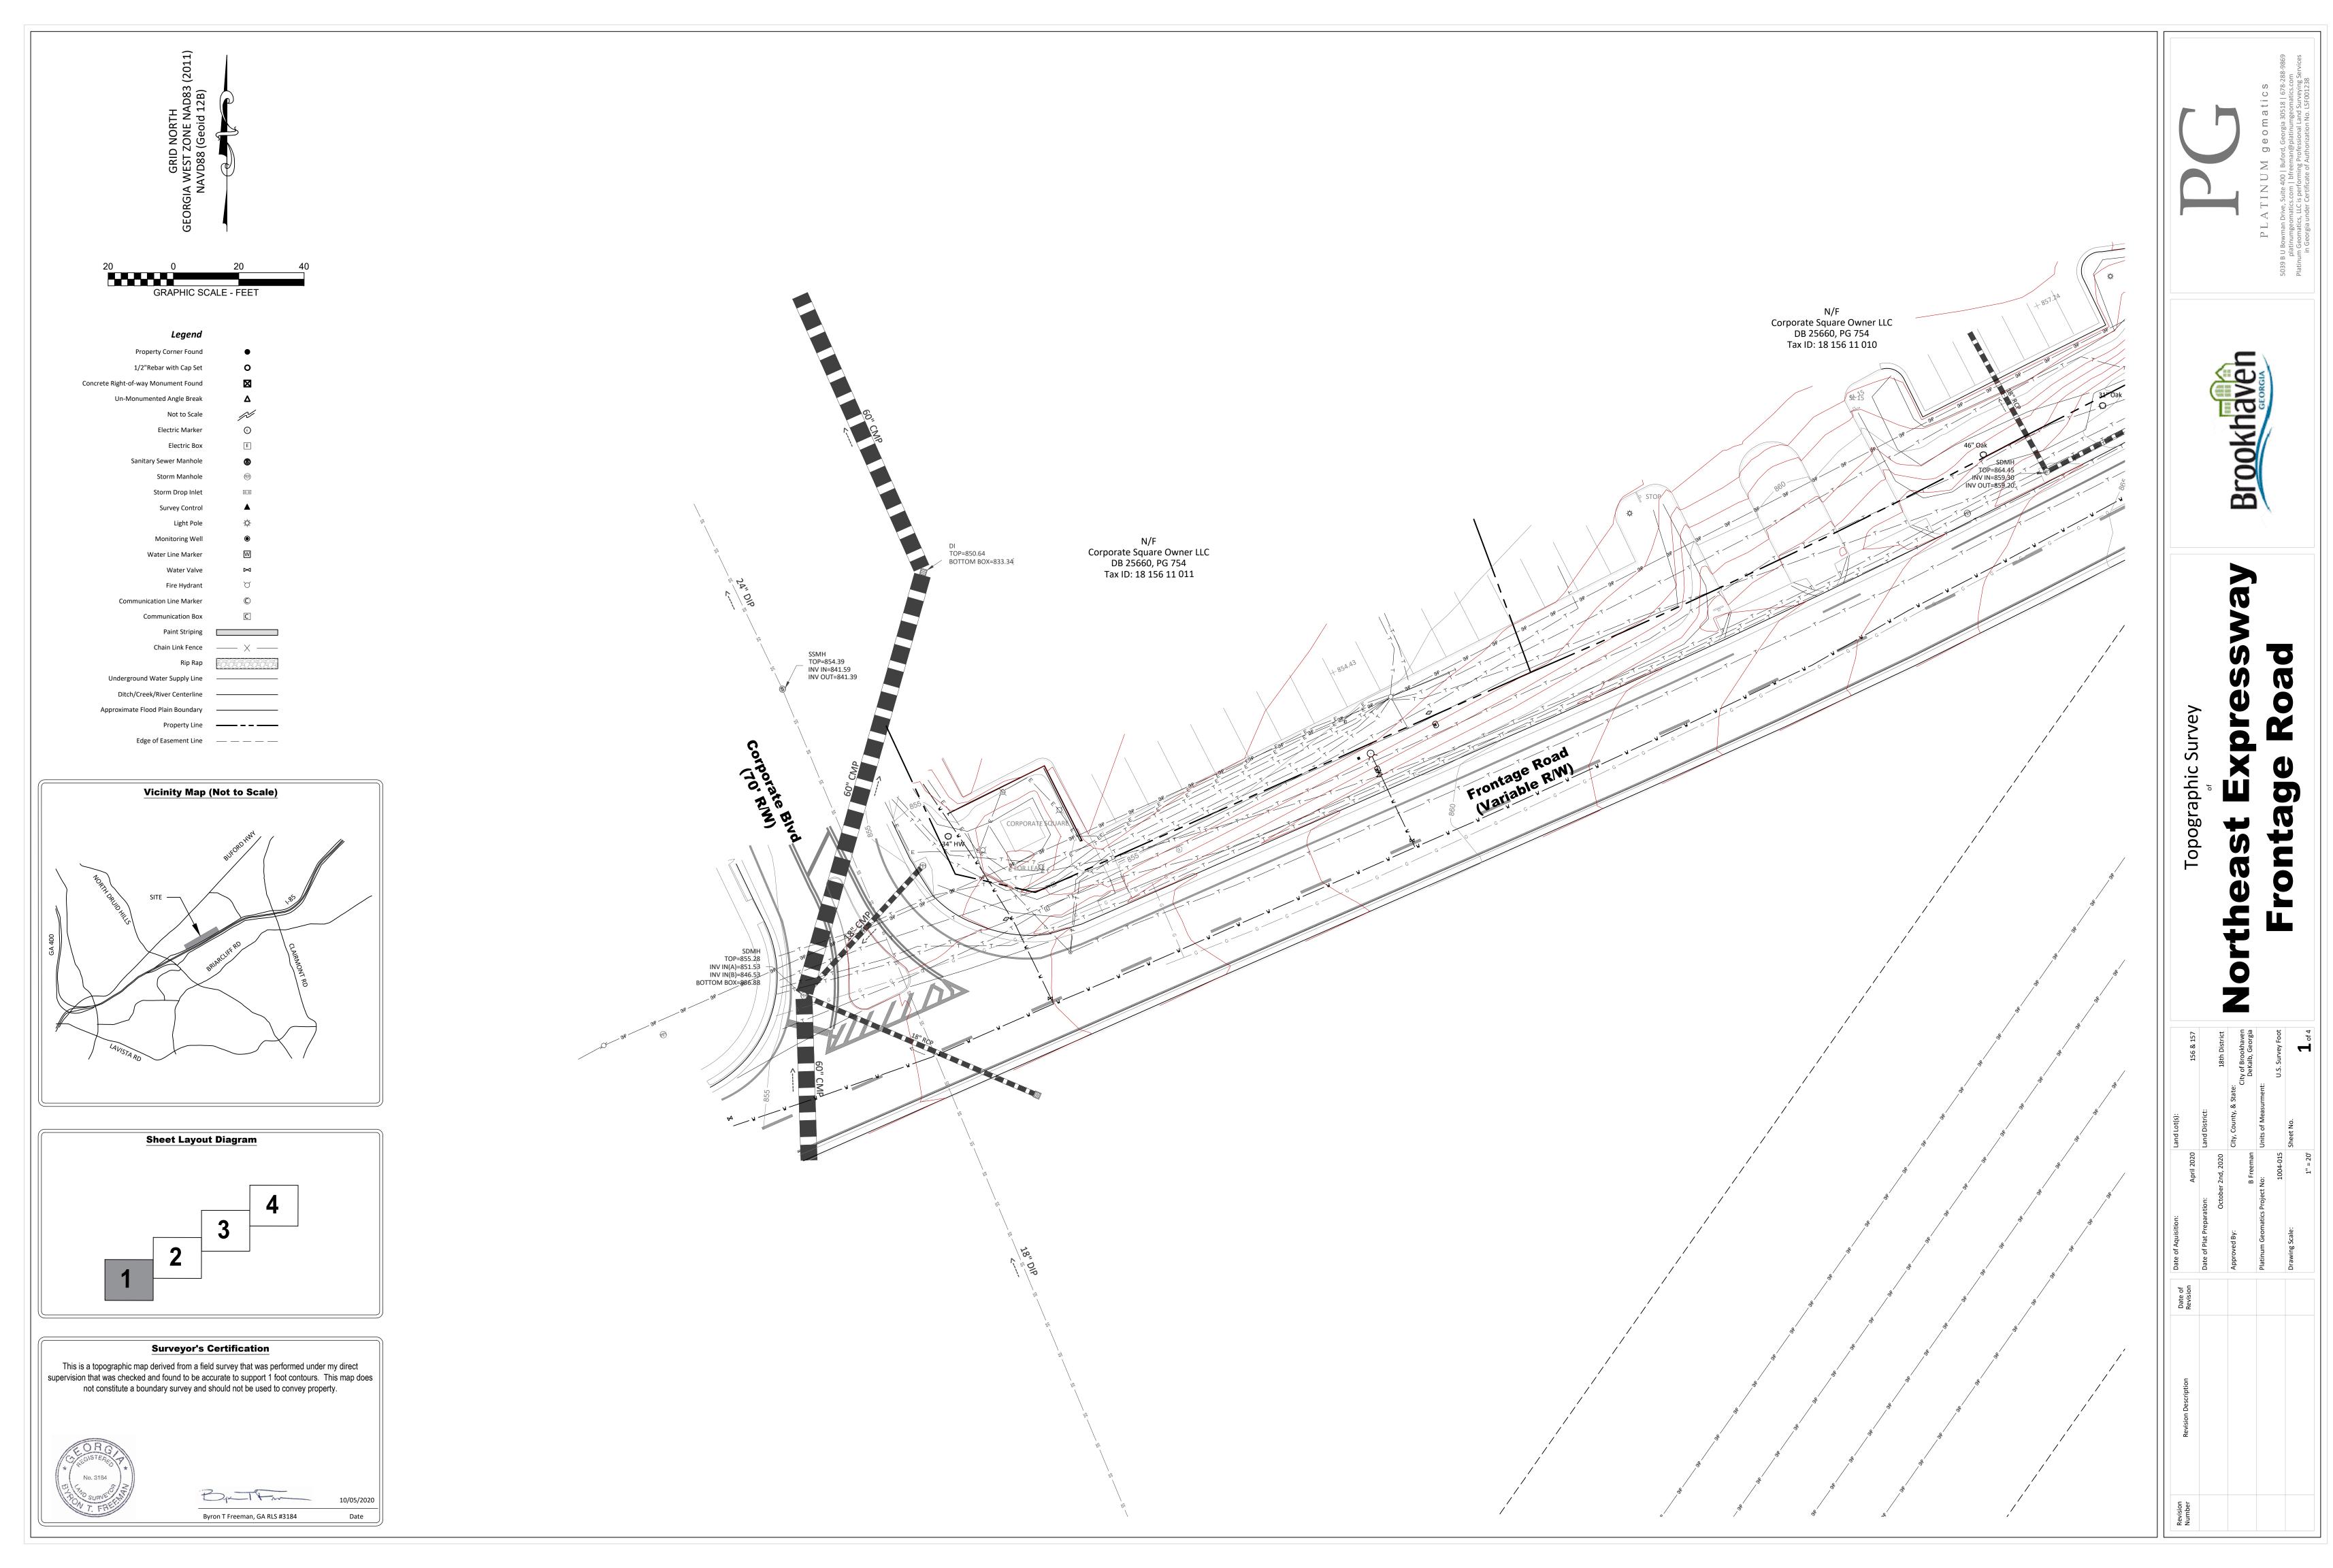

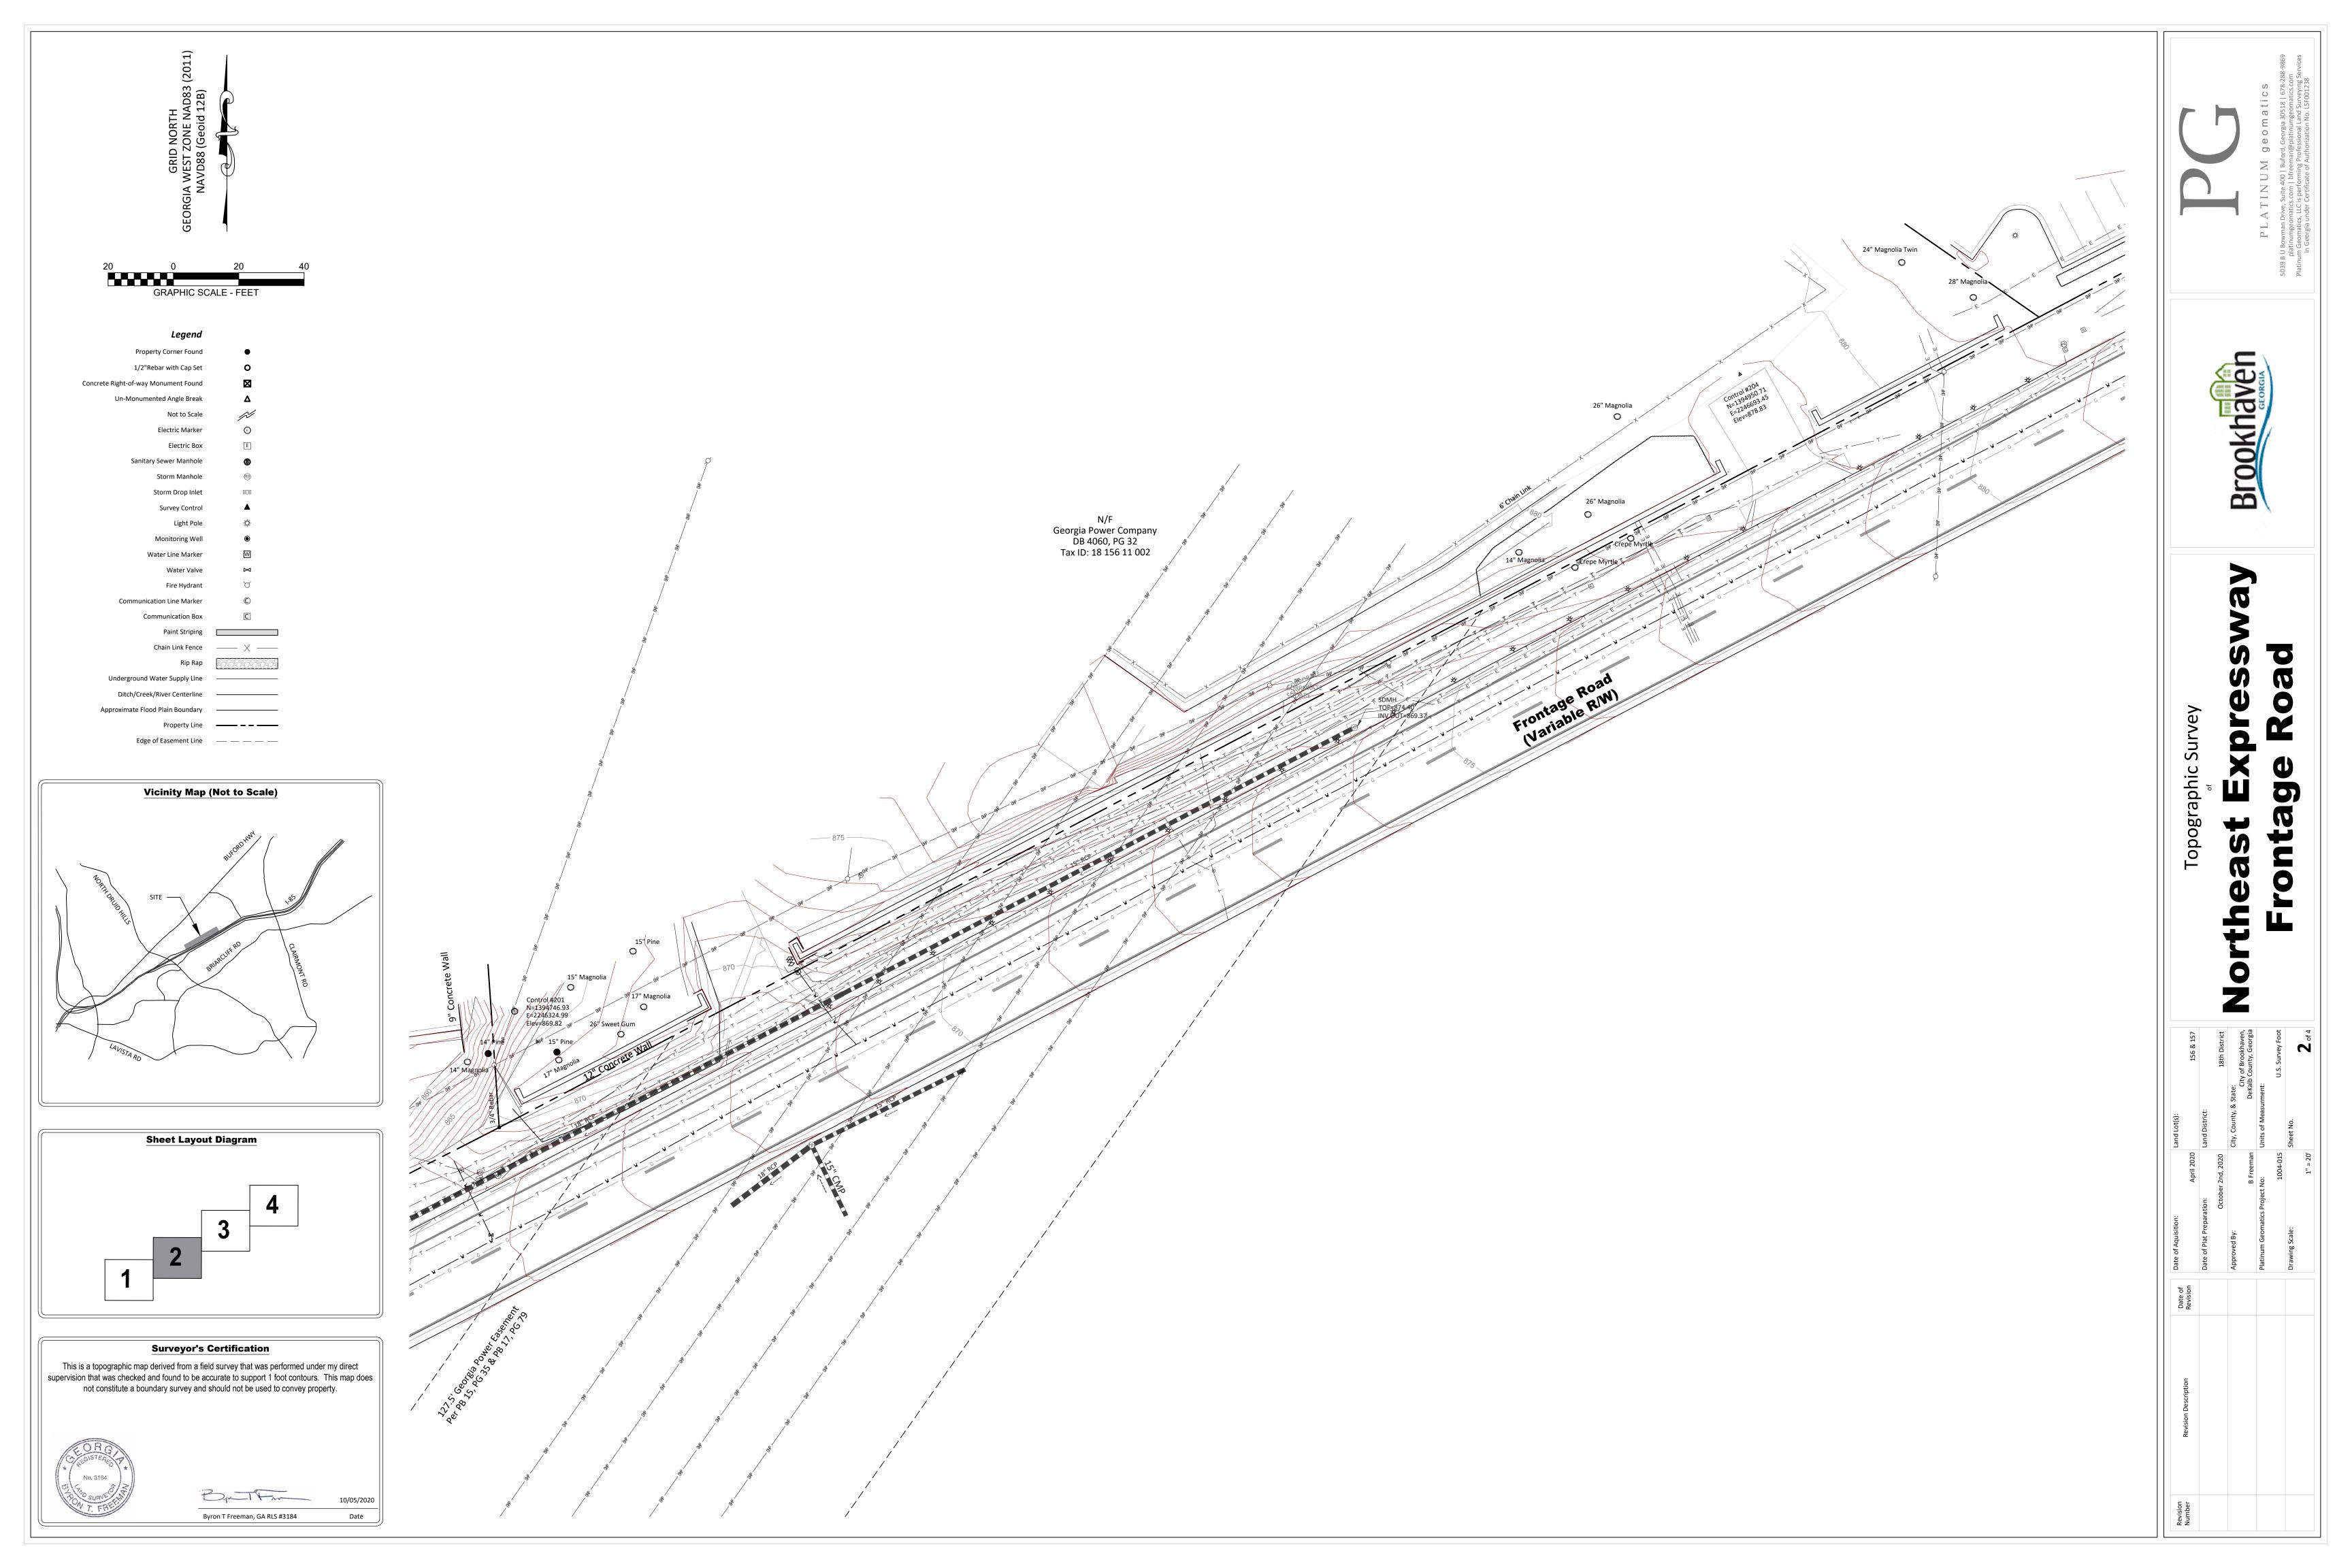

 $P \ L \ A \ T \ I \ N \ U \ M \ g \ e \ o \ m \ a \ ti \ c \ s$ U Bowman Drive, Suite 400 | Buford, Georgia 30518 | 678-288-platinumgeomatics.com



way Broo

theast Express

Land District:
Land District:

Land District:

City, County, & State:
City of Brookhaven,
Dekalb County, Georgia
Units of Measurment:

Units of Measurment:
Units of Measurment:
Sheet No.

 Kevision
 April 2020

 Date of Plat Preparation:
 Land District:


 October 2nd, 2020
 City, County, & Stanson


 Approved By:
 B Freeman

 Platinum Geomatics Project No:
 Units of Measurme


 Drawing Scale:
 Sheet No.

Mevision

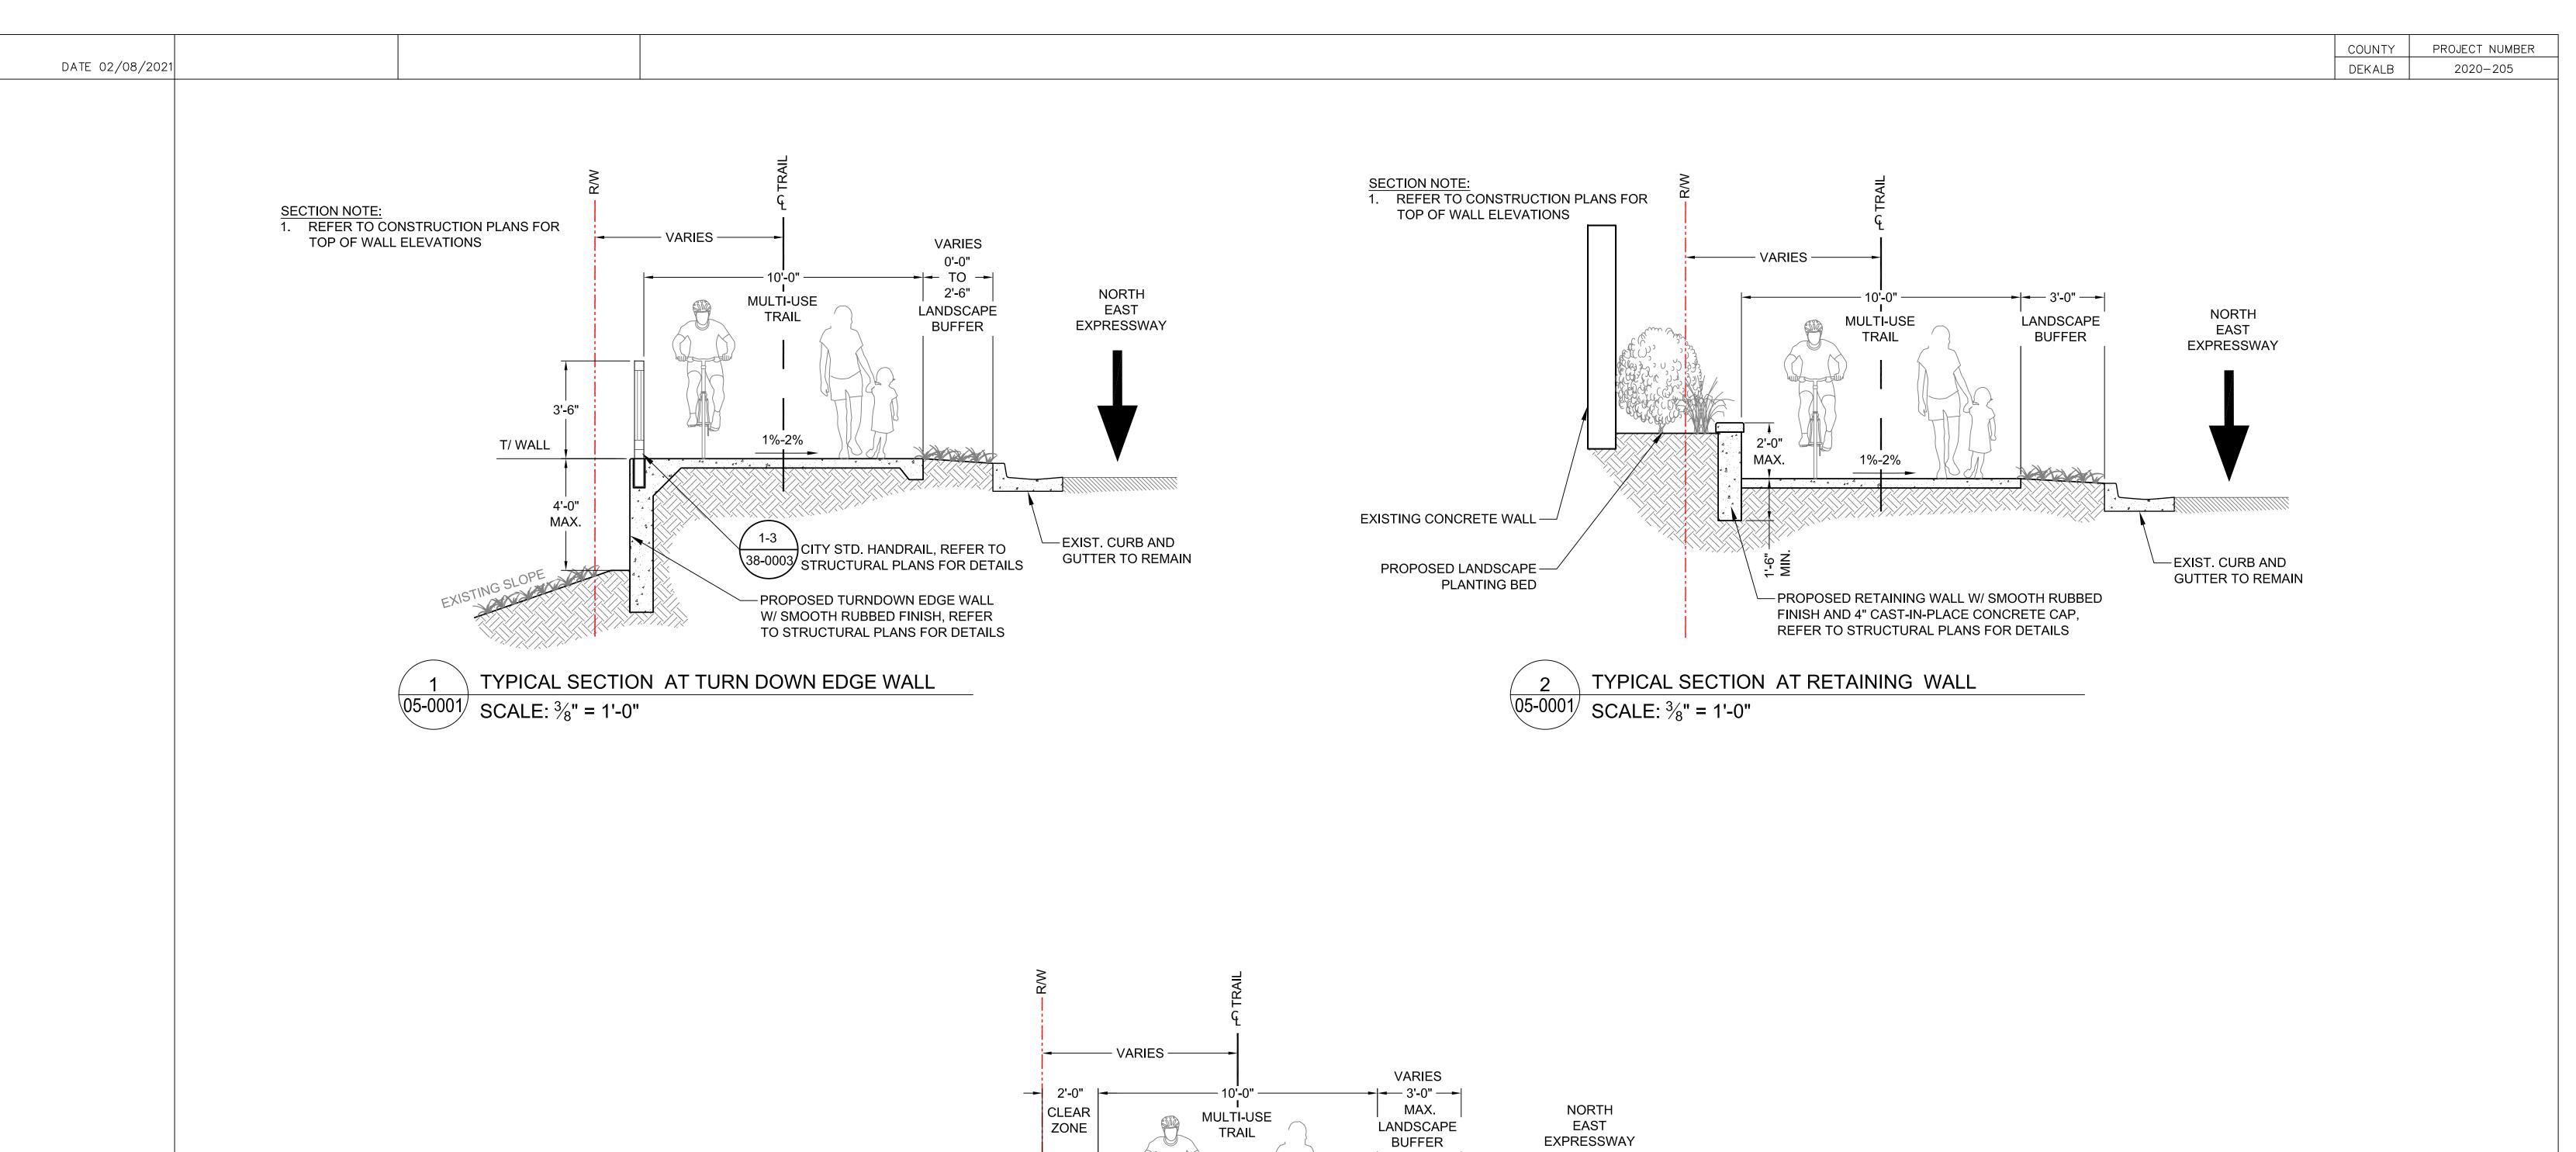

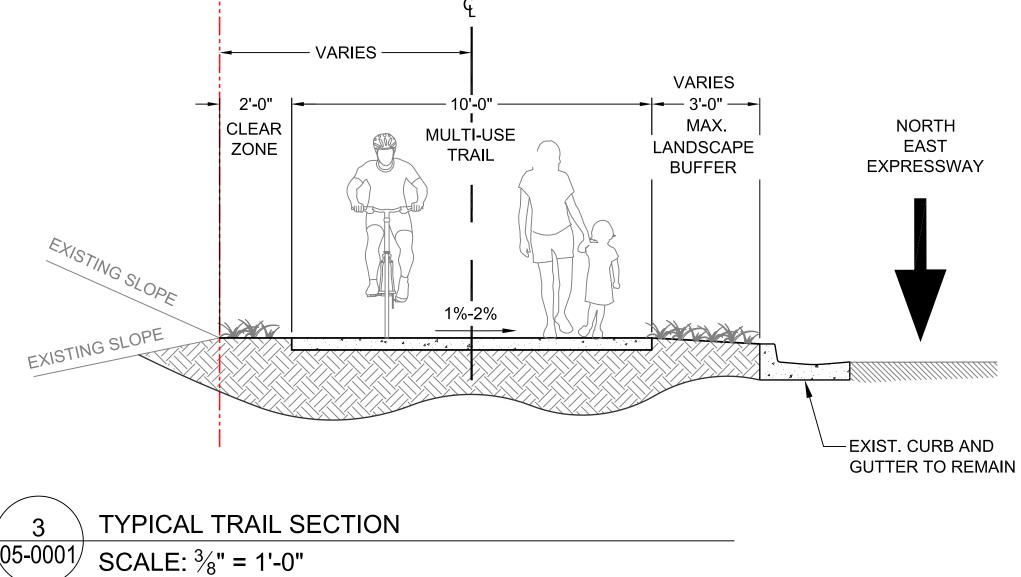



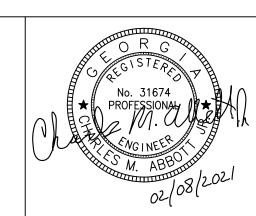

PLANS PREPARED BY: 2390 Main Street | Tucker, GA 30084 | 404.239.2521

T: 404-239-2521

CHARLES M. ABBOTT JR, P.E.
DESIGN ENGINEER LEVEL II CERTIFICATION GSWCC # 0000041686 EXPIRES: 04/13/2022 CHUCK.ABBOTT@KAIZENCOLLABORATIVE.COM

CITY OF BROOKHAVEN
DONALD SHERRILL - PUBLIC WORKS DEPUTY DIRECTOR 4362 PEACHTREE RD., BROOKHAVEN, GA 30319 E: DON.SHERRILL@BROOKHAVENGA.GOV O: 404-991-4763 C: 404-637-0682

100% ISSUE FOR PERMIT REV. 1 CITY COMMENTS REV. 2 AGENCY COMMENTS SCALE AS SHOWN

STATE OF GEORGIA DEPARTMENT OF TRANSPORTATION REVISION DATES 11/20/2020 OFFICE: DISTRICT 7 01/11/2021 02/08/2021 TYPICAL SECTIONS DRAWING No. N.E. EXPRESSWAY FRONTAGE ROAD

MUTI-USE PATH

05 - 0001

PROJECT NUMBER COUNTY DEKALB 2020-205

Item	Item Description	Units	Quantity
Number	Y & TRAIL CONSTRUCTION		- Quantity
432-0200	MILL EXISTING ASPHALT SURFACE, MILL DEPTH VARIES (NDC Health Corporate Driveway)	SY	57
310-5060	GR AGGR SUBBASE CRS, 6 IN, INCL MATL	SY	57
402-3910	1 1/2 IN RECYCLED ASPH CONC 9.5MM SUPERPAVE GP 2 ONLY, INCL BITUM MTL & H LIME	TN	4
	2 IN RECYCLED ASPH CONC 19MM SUPERPAVE GP 1 OR 2, INCL BITUM MTL & H LIME	TN	7
413-1000	BITUM TACK COAT	GL	13
441-0018	CONC. DRIVEWAY APRON, 8 IN (PER GDOT STD A1 & A2 & GA POWER REFERENCE DETAIL "TYP DRIVE")	SY	210
441-0105	10' CONCRETE TRAIL AND SIDEWALK, 3000PSI 4 IN THICK (INCL ADA RAMPS)	SY	2075
441-0706	CONCRETE MEDIAN, 6 IN	SY	2
441-5002	CONCRETE HEADER CURB, 6 IN, TP 2	LF	350
441-6022	CONC. CURB AND GUTTER, 6" x 30", TYPE 2 (PER GDOT STD 9032B)	LF	75
444-1000	SAWED JOINTS IN EXISTING PAVEMENTS (Space between joints to equal trail width)	LF	2000
500-3800	CLASS A CONCRETE, STAIRS, INCL. REINFORCING (STA. 16+22)	LS	1
999-5200	DETECTABLE WARNING SURFACE	SF	340
JTILITIE			1
611-8120	ADJUST UTILITY TO GRADE (WATER, GAS, ELECTRIC, MANHOLES, ETC.)	EA	20
611-8100	RELOCATE EXISTING LIGHT (STA: 16+30)	EA	1
	ADJUST MANHOLE TO GRADE	EA	7
	RELOCATE EXISTING FIRE HYDRANT, PER PLANS (STA: 1+98; 10+54)	EA	2
	REMOVE EXISTING ROAD STIPING PER SM PLANS	1.0	
652-0000		LS	710
652-5301 653-1704	THERMO SOLID TRAFFIC STRIPE, 8 IN WHITE, 12' WIDE (GDOT CROSSWALKS)	LF	719
SIGNAGE	THERMO SOLID TRAFFIC STRIPE, 24 IN, WHITE (STOP BARS)	LF	24
	RELOCATE EXISTING SIGNS (BUISNESS, DRIVEWAY, HIGHWAY, ETC. (STA: 3+10; 18+25; 20+35)	EA	3
636-1033	MUTCD HIGHWAY SIGNS MUTCD HIGHWAY SIGNS	SF	32
	MUTCD HIGHWAY SQUARE POST, BREAKAWAY 14 FT.	LF	60
030-3010	INIOTED HIGHWAT SQUARET 051, BREAKAWAT 1411.	LI	
	CECTION D. CTDUCTUDAL ITEMS		
T.	SECTION B: STRUCTURAL ITEMS		ı
Item Number	Item Description	Units	Quantity
RAILING			
515-1000	FALL PROTECTION FENCE FOR WALL #1, SPCL DESIGN (Per City of Brookhaven Details)	LF	236
WALLS			
445-1002	235 LF TURNDOWN EDGE WALL #1, 4' MAX HT. (Bid per structural design specs: STA 0+79 TO 3+15)	LS	1
445-1002	83 LF RETAINING WALL #2, 2' MAX HT. (Bid per structural design specs: STA 4+74 TO 5+57)	LS	1
445-1002	240 LF RETAINING WALL #3, 2' MAX HT. (Bid per structural design specs: STA 5+90 TO 8+30)	LS	1
	SECTION C: EROSION CONTROL/STORM DRAINAGE		_
Item Number	Item Description	Units	Quantity
163-0402	TEMPORARY CONC. WASHDOWN	EA	2
163-0300	CONSTRUCTION EXIT	EA	3
165-0101	MAINTENANCE OF CONSTRUCTION EXIT	EA	3
163-0529	CONSTRUCT AND REMOVE TEMPORARY SEDIMENT BARRIER, TYPE NS	LF	3382
165-0030	MAINTENANCE OF TEMPORARY SEDIMENT BARRIER, TYPE NS	LS	3382
163-0550	CONSTRUCT AND REMOVE INLET SEDIMENT TRAP, TYPE P	EA	6
165-0105	MAINTENANCE OF INLET SEDIMENT TRAP	LS	6
700-6900	TEMPORARY GRASS SEEDING	AC	0.025
	FERTILIZER MIX GRADE	AC	0.025
700-8000	BALES OF MULCH, LONG LEAF PINE	EA	44
700-8000 702-9025	Briebes of McBerr, Borro EBrit Tire		<u> </u>
	Bribbs of Mebert, Botto Berti Titte		
	SECTION D: LANDSCAPE		
702-9025 Item		Units	Quantity
702-9025 Item Number	SECTION D: LANDSCAPE Item Description		Quantity
702-9025 Item Number 700-9400	SECTION D: LANDSCAPE Item Description SHRUB, OCTOBER MAGIC BRIDE CAMELLIA, 5GAL.	EA	12
702-9025 Item Number 700-9400 700-9400	SECTION D: LANDSCAPE Item Description SHRUB, OCTOBER MAGIC BRIDE CAMELLIA, 5GAL. SHRUB, DALLAS BLUES SWITCH GRASS, 5GAL.	EA EA	12 24
Item Number 700-9400 700-9400	SECTION D: LANDSCAPE Item Description SHRUB, OCTOBER MAGIC BRIDE CAMELLIA, 5GAL.	EA	12


NOTE: CONTRACTOR IS RESPONSIBLE FOR VERIFYING QUANTITIES

2 ITEMS UPDATED ON 02/08/2021

702-9025 BALES OF MULCH, LONG LEAF PINE

700-9410 SOD, CONTRACTOR TO VERIFY AND MATCH EXISTING



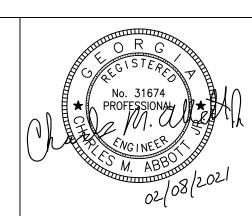



CHARLES M. ABBOTT JR, P.E.DESIGN ENGINEER LEVEL II CERTIFICATION GSWCC # 0000041686 EXPIRES: 04/13/2022 CHUCK.ABBOTT@KAIZENCOLLABORATIVE.COM T: 404-239-2521

CITY OF BROOKHAVEN DONALD SHERRILL - PUBLIC WORKS Brookhaven

DEPUTY DIRECTOR

4362 PEACHTREE RD., BROOKHAVEN, GA 30319
E: DON.SHERRILL@BROOKHAVENGA.GOV
O: 404-991-4763 C: 404-637-0682

REVISION DAT	ES	
100% ISSUE FOR PERMIT	11/20/2020	
1 REV. 1 CITY COMMENTS	01/11/2021	
REV. 2 AGENCY COMMENTS	02/08/2021	
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STATE OF GEORGIA DEPARTMENT OF TRANSPORTATION OFFICE: DISTRICT 7

DETAILED ESTIMATE

N.E. EXPRESSWAY FRONTAGE ROAD MUTI-USE PATH

PROJECT NUMBER DEKALB

2020-205

SHEET NOTES:

- 1. THIS DRAWING IS FOR GENERAL REFERENCE PURPOSES ONLY, CONTRACTOR TO PROVIDE A COMPREHENSIVE TRAFFIC CONTROL PLAN PRIOR TO ANY
- 2. ALL TEMPORARY TRAFFIC CONTROL MEASURE TO REMIAN IN PLACE UNTIL THE CONCLUSION OF ALL SIGNING AND STRIPING WORK.
- ALL TRAFFIC CONTROL MEASURE TO MEET GDOT AND MUTCD REGULATIONS, REFER TO GDOT STD TRAFFIC CONTROL DETAIL ON SHEET 10-0003 AND MUTCD LATEST EDITION


TRAFFIC CONTROL NOTES FOR I-85 FRONTAGE ROAD: CONSTRUCTION HOURS: 7:00AM - 7:00PM NO. OF LANES: 2

PROJECT DESCRIPTION: INSTALLATION OF A 10' WIDE MULTI-USE PATH WITHIN THE EXISTING LANDSCAPE BUFFER OF I-85 FRONTAGE ROAD, A 2 LANE ROAD. AS A RESULT WHEN A LANE IS CLOSED FOR WORK, ONLY 1 LANE IS AVAILABLE TO REMAIN OPEN.


- 1. LANE CLOSURE ONLY ALLOWED BETWEEN 9:00AM-4:00PM
- 2. ALL TRAFFIC CONTROL TO BE IN ACCORDANCE WITH BOTH MUTCD AND GDOT STANDARDS
- 3. ALL AREAS OF WORK AND STAGING TO BE BARRICADED WITH BARRELS AND/OR CONES AND DESIGNATED AS A 'WORK ZONE" W/ APPROX. 50' OF TAPERED AND 50' OF BUFFERED AREA EXTENDED BEYOND BOTH DIRECTION OF THE WORK ZONE
- 4. "MEN WORKING AHEAD", "LANE CLOSED AHEAD", AND 'FLAGGERS AHEAD SIGNS TO BE PLACE AHEAD OF WORK ZONES AT REQUIRED INCREMENTS PER MUTCD AND GDOT STANDARDS
- 5. FLAGGERS MUST BE ONSITE AND PRESENT WHEN LANE CLOSURE IS NEEDED.
- 6. BARRELS OR CONES TO BE USED AS NEEDED TO DEFINE TEMPORARY LANE WIDTHS
- 7. OVERALL PLAN SHOWS ENTIRE WORK AREA, HOWEVER IT IS ANTICIPATED THAT THE WORK WILL BE COMPLETED IN SMALLER SECTIONS DESIGNATED AS AFOREMENTIONED "WORK ZONES"
- 8. TRAFFIC CONTROL MEASURES TO MOVE WITH WORK, WITH THE INTENT TO MINIMIZED LANE CLOSURE IMPACT TO NO GREATER THAN 200' AT A TIME.

LEGEND TRAFFIC CONTROL AREA WORKSPACE STAGING AREA



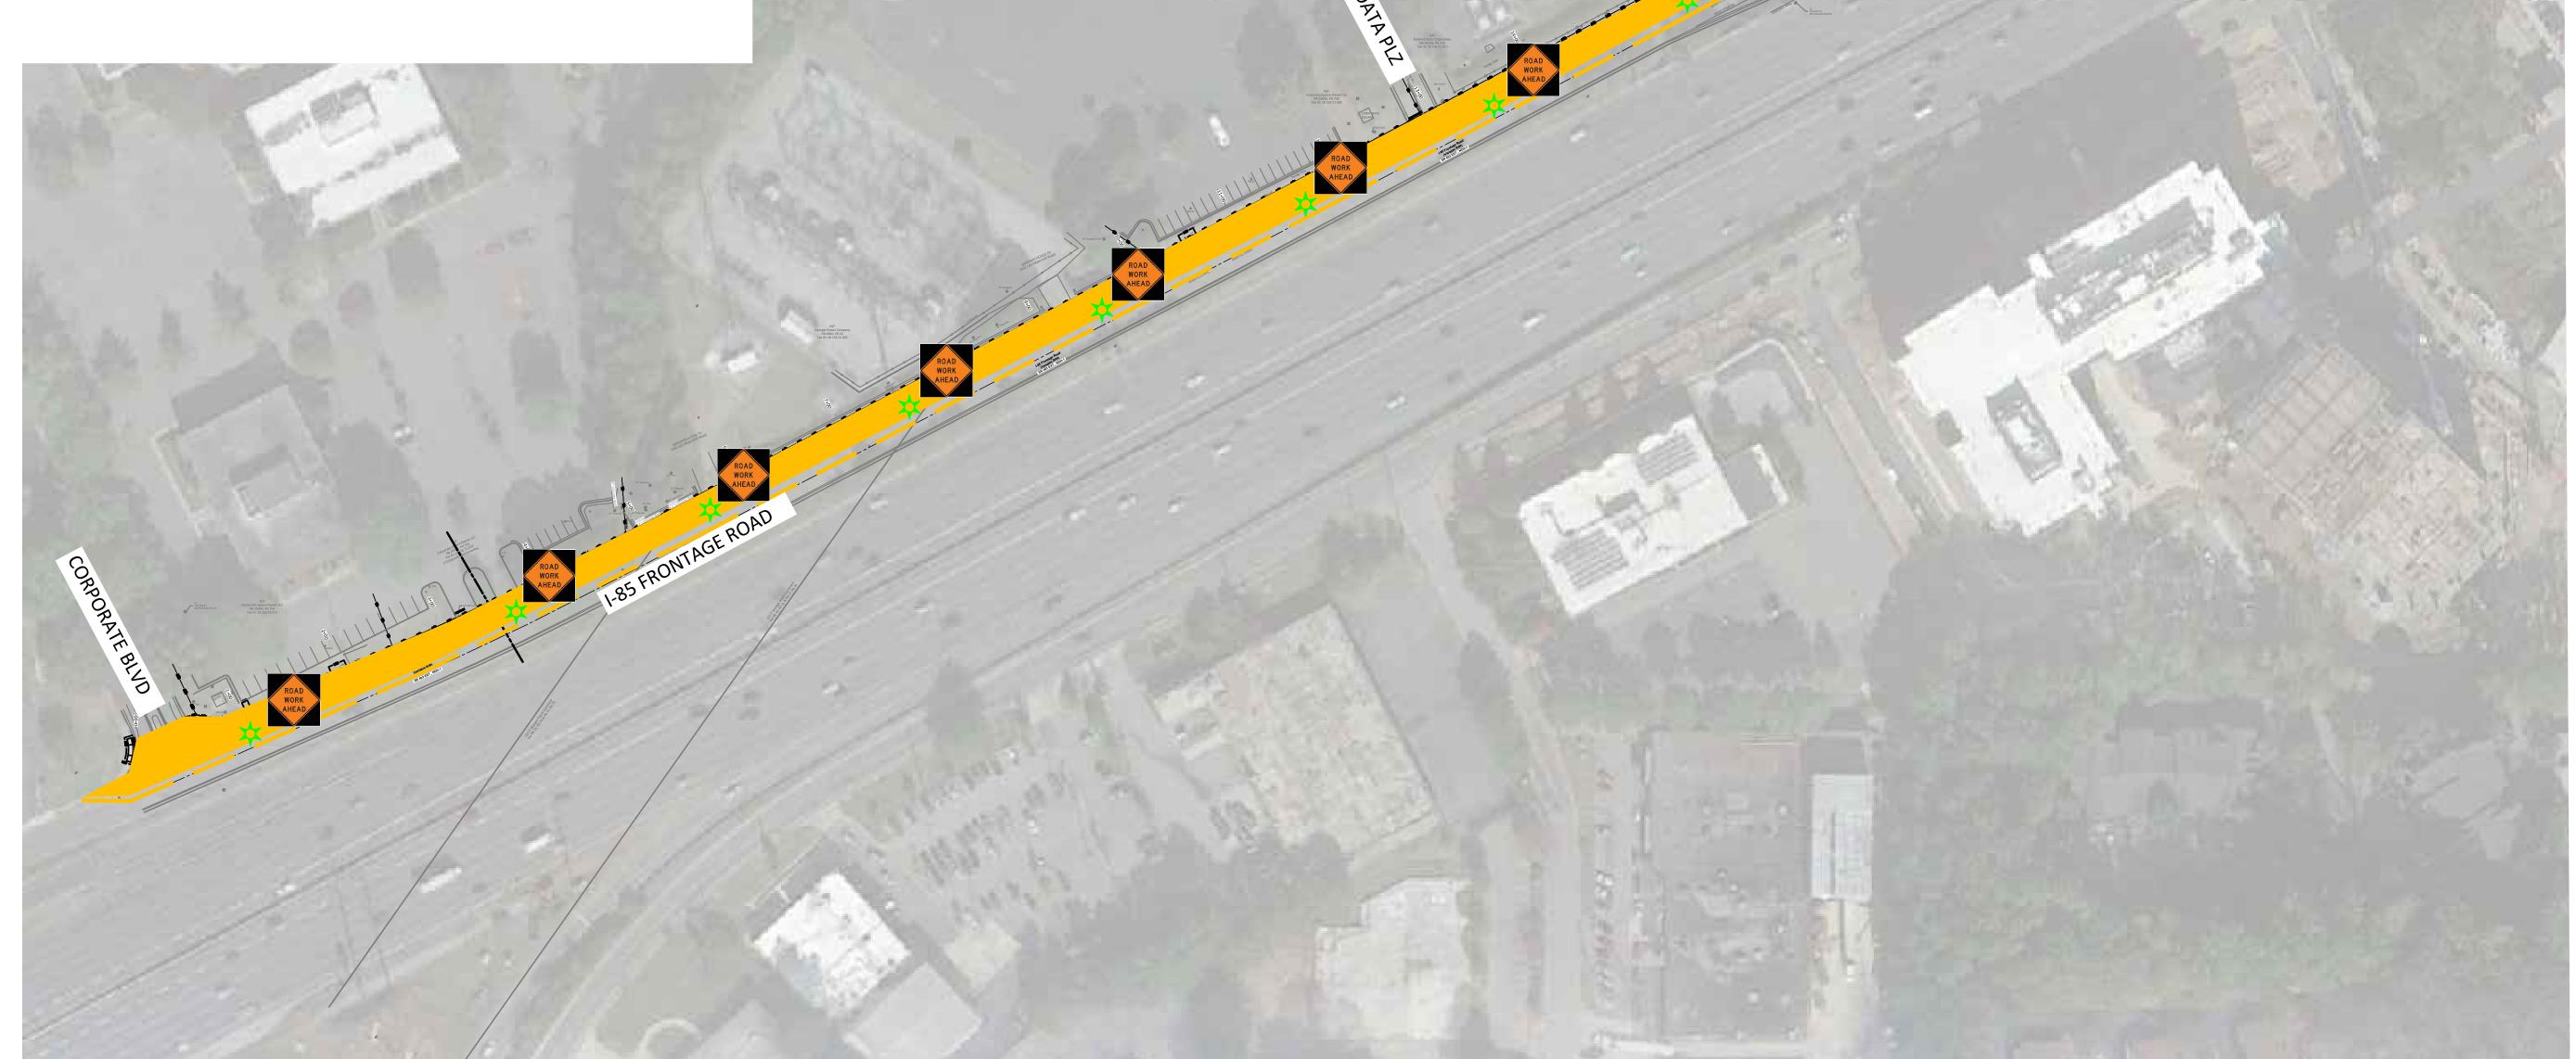



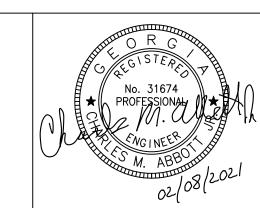


PLANS PREPARED BY: KAIZENCOLLABORATIVE 2390 Main Street | Tucker, GA 30084 | 404.239.2521

CHARLES M. ABBOTT JR, P.E.

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GSWCC # 0000041686 EXPIRES: 04/13/2022
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CITY OF BROOKHAVEN
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00% ISSUE FOR PERMIT	11/20/2020
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STATE OF GEORGIA

DEPARTMENT OF TRANSPORTATION

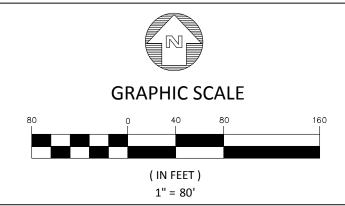
OFFICE: DISTRICT 7

TRAFFIC CONTROL PLAN


N.E. EXPRESSWAY FRONTAGE ROAD MUTI-USE PATH

PROJECT NUMBER COUNTY DEKALB

2020-205

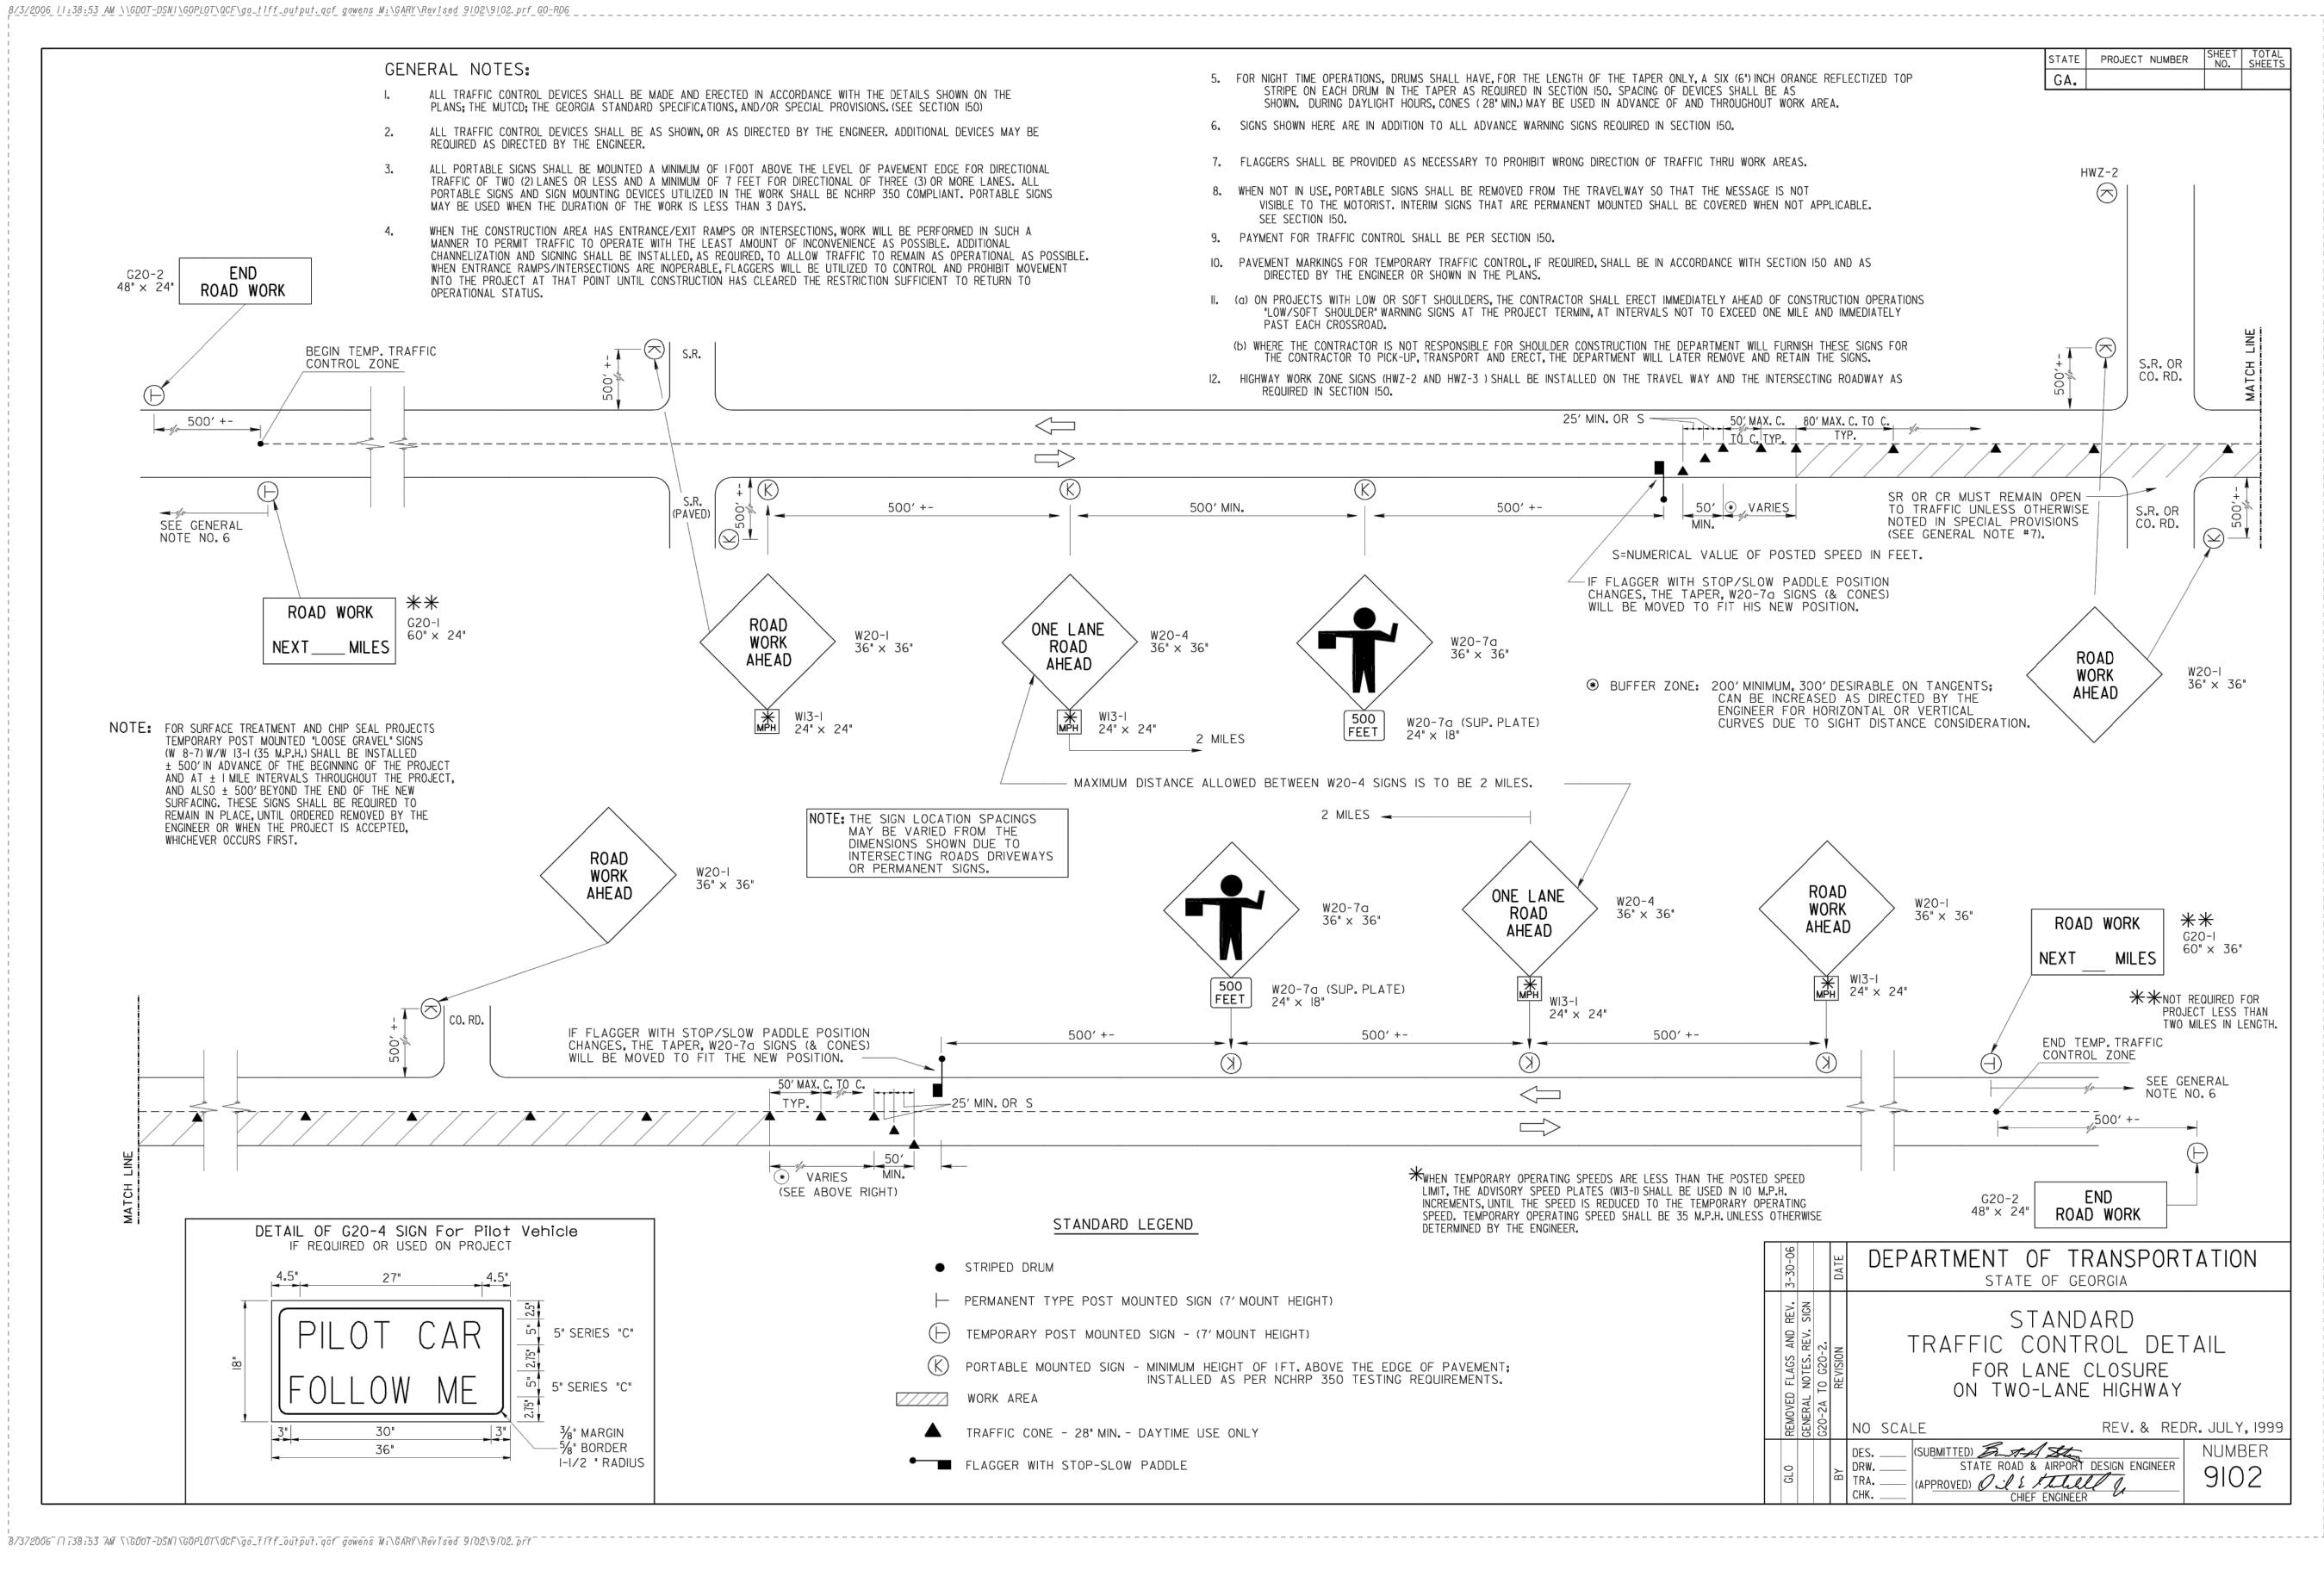




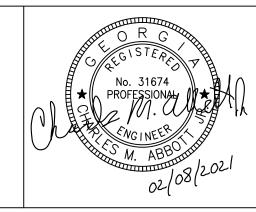

PLANS PREPARED BY: 2390 Main Street | Tucker, GA 30084 | 404.239.2521

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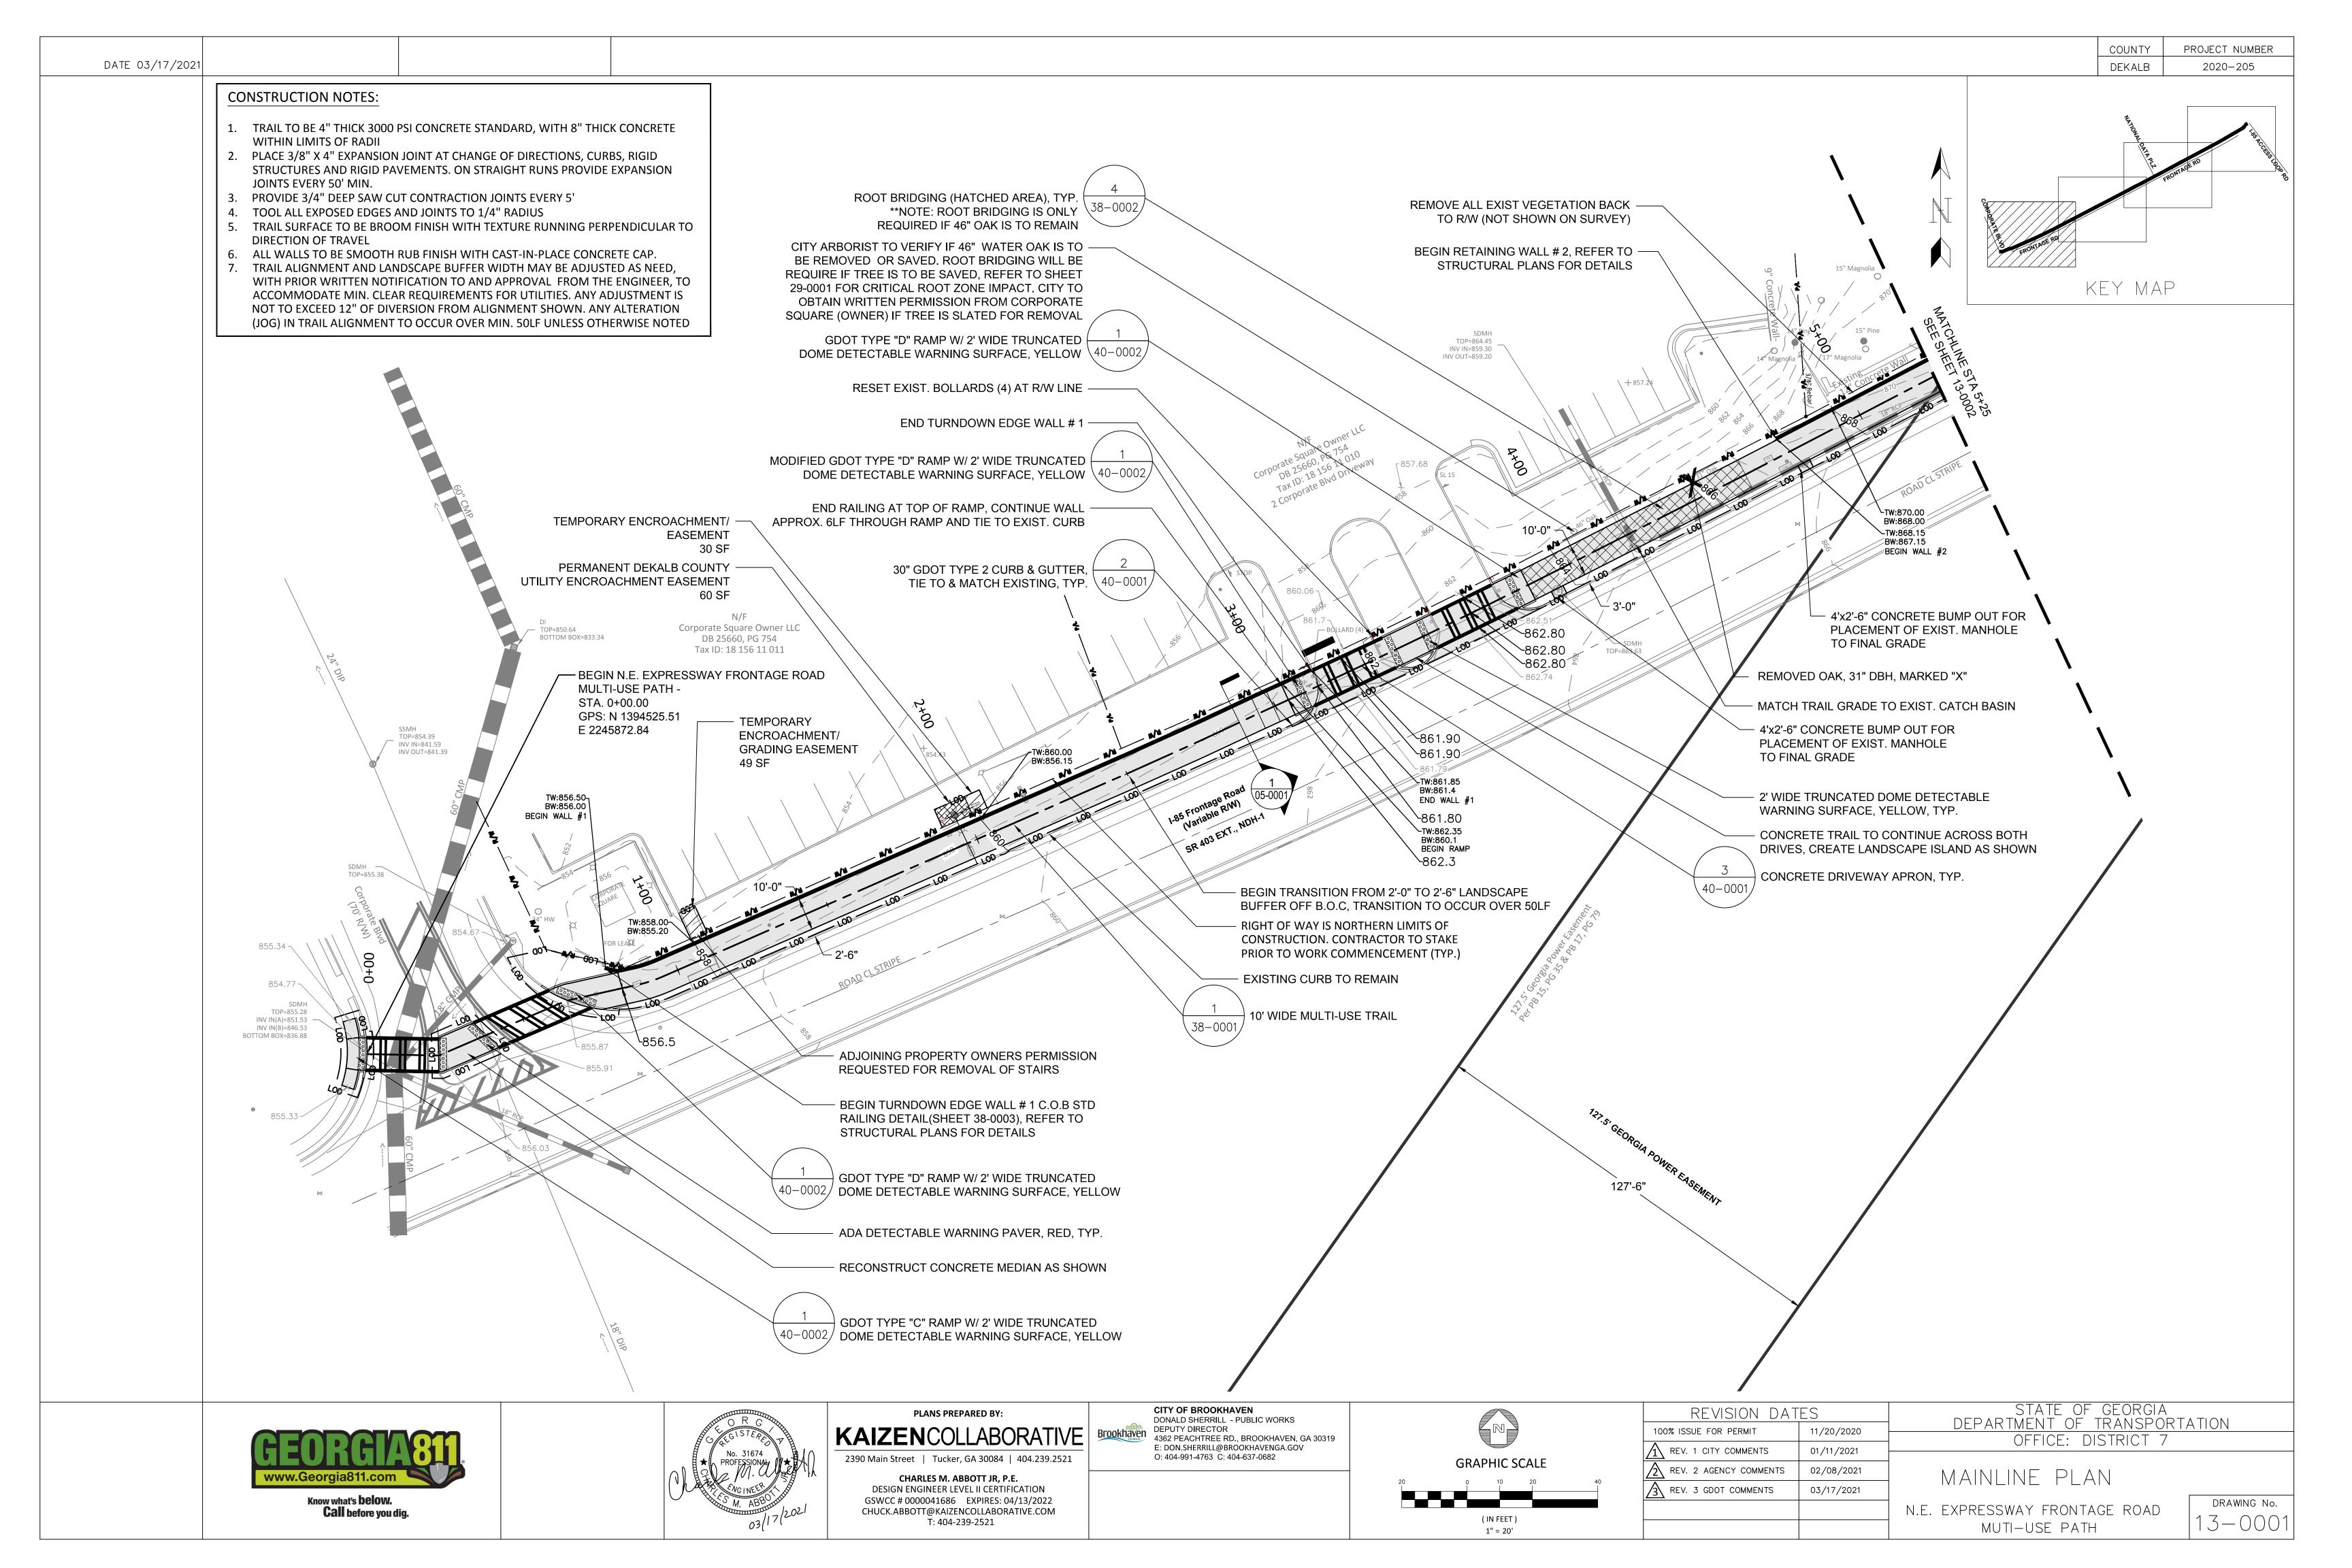
CITY OF BROOKHAVEN DONALD SHERRILL - PUBLIC WORKS DEPUTY DIRECTOR 4362 PEACHTREE RD., BROOKHAVEN, GA 30319 E: DON.SHERRILL@BROOKHAVENGA.GOV O: 404-991-4763 C: 404-637-0682

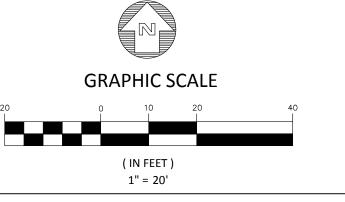



REVISION DATES		STATE OF GEORGIA			
100% ISSUE FOR PERMIT	11/20/2020	DEPARTMENT OF TRANSPORTATION			
^	, ,	OFFICE: DISTRICT 7			
REV. 1 CITY COMMENTS	01/11/2021				
REV. 2 AGENCY COMMENTS	02/08/2021	TRAFFIC CONTROL DETAIL			
		DRAV			


CONTROL DETAIL DRAWING No. N.E. EXPRESSWAY FRONTAGE ROAD


MUTI-USE PATH




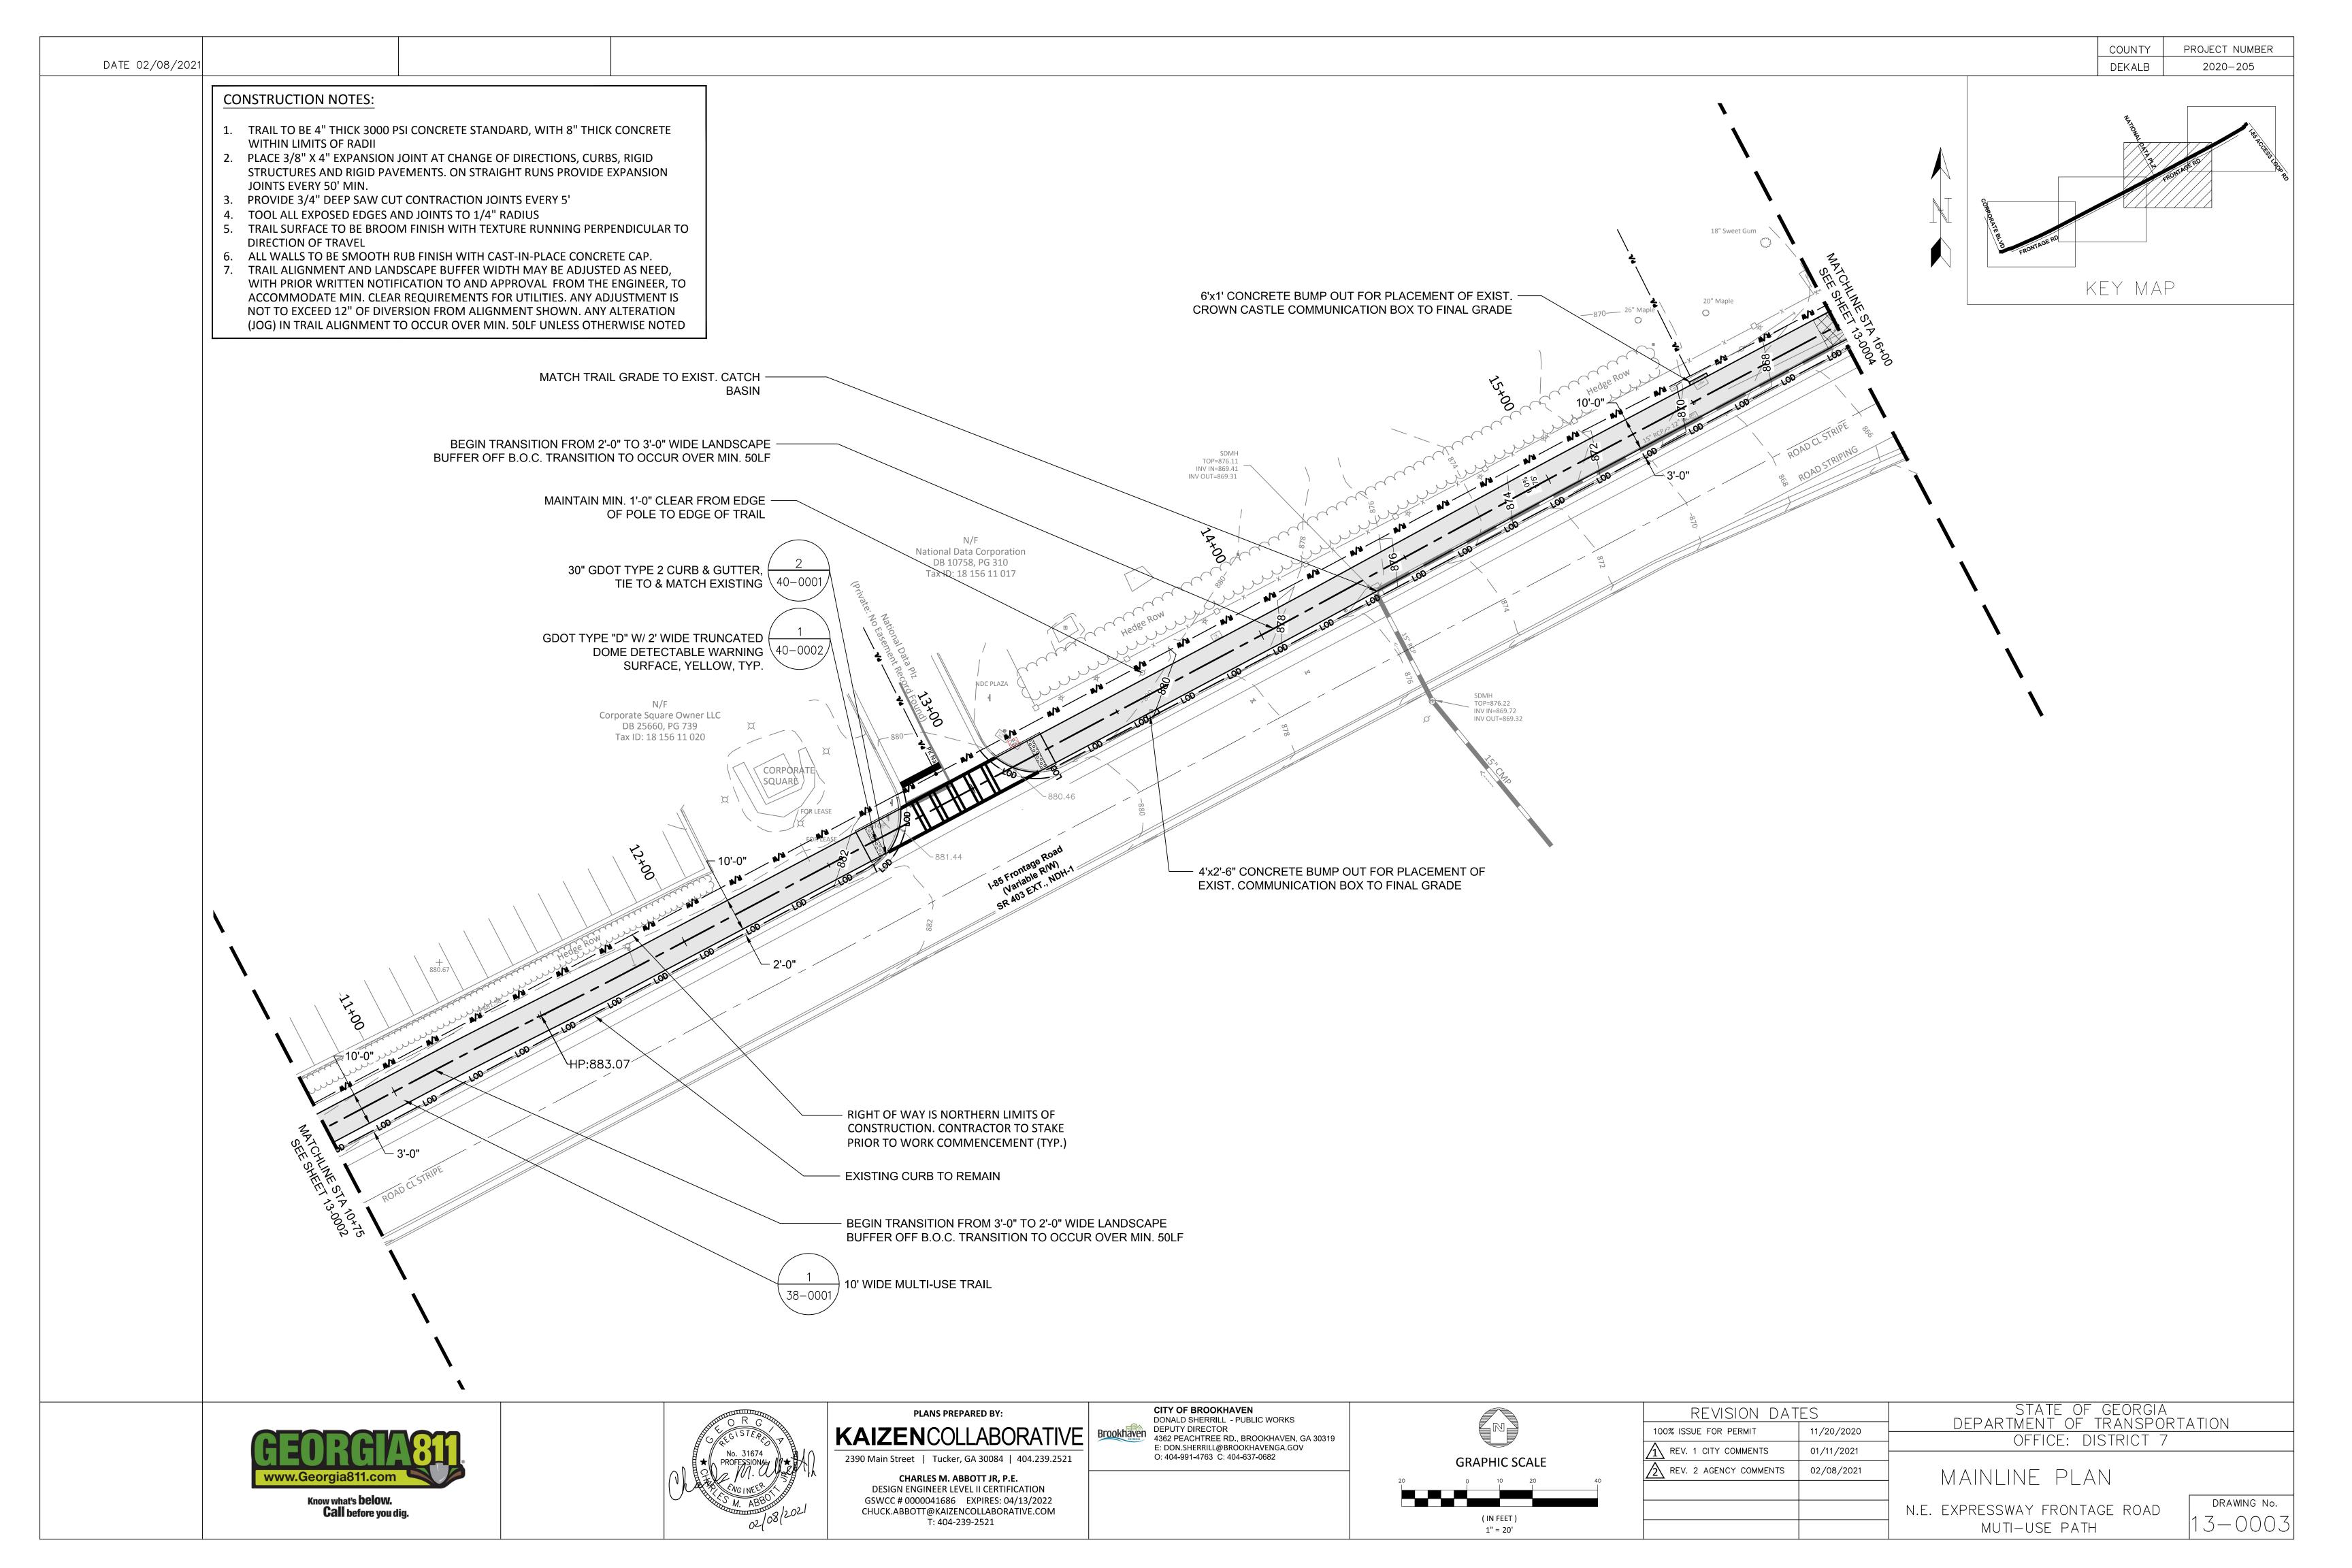

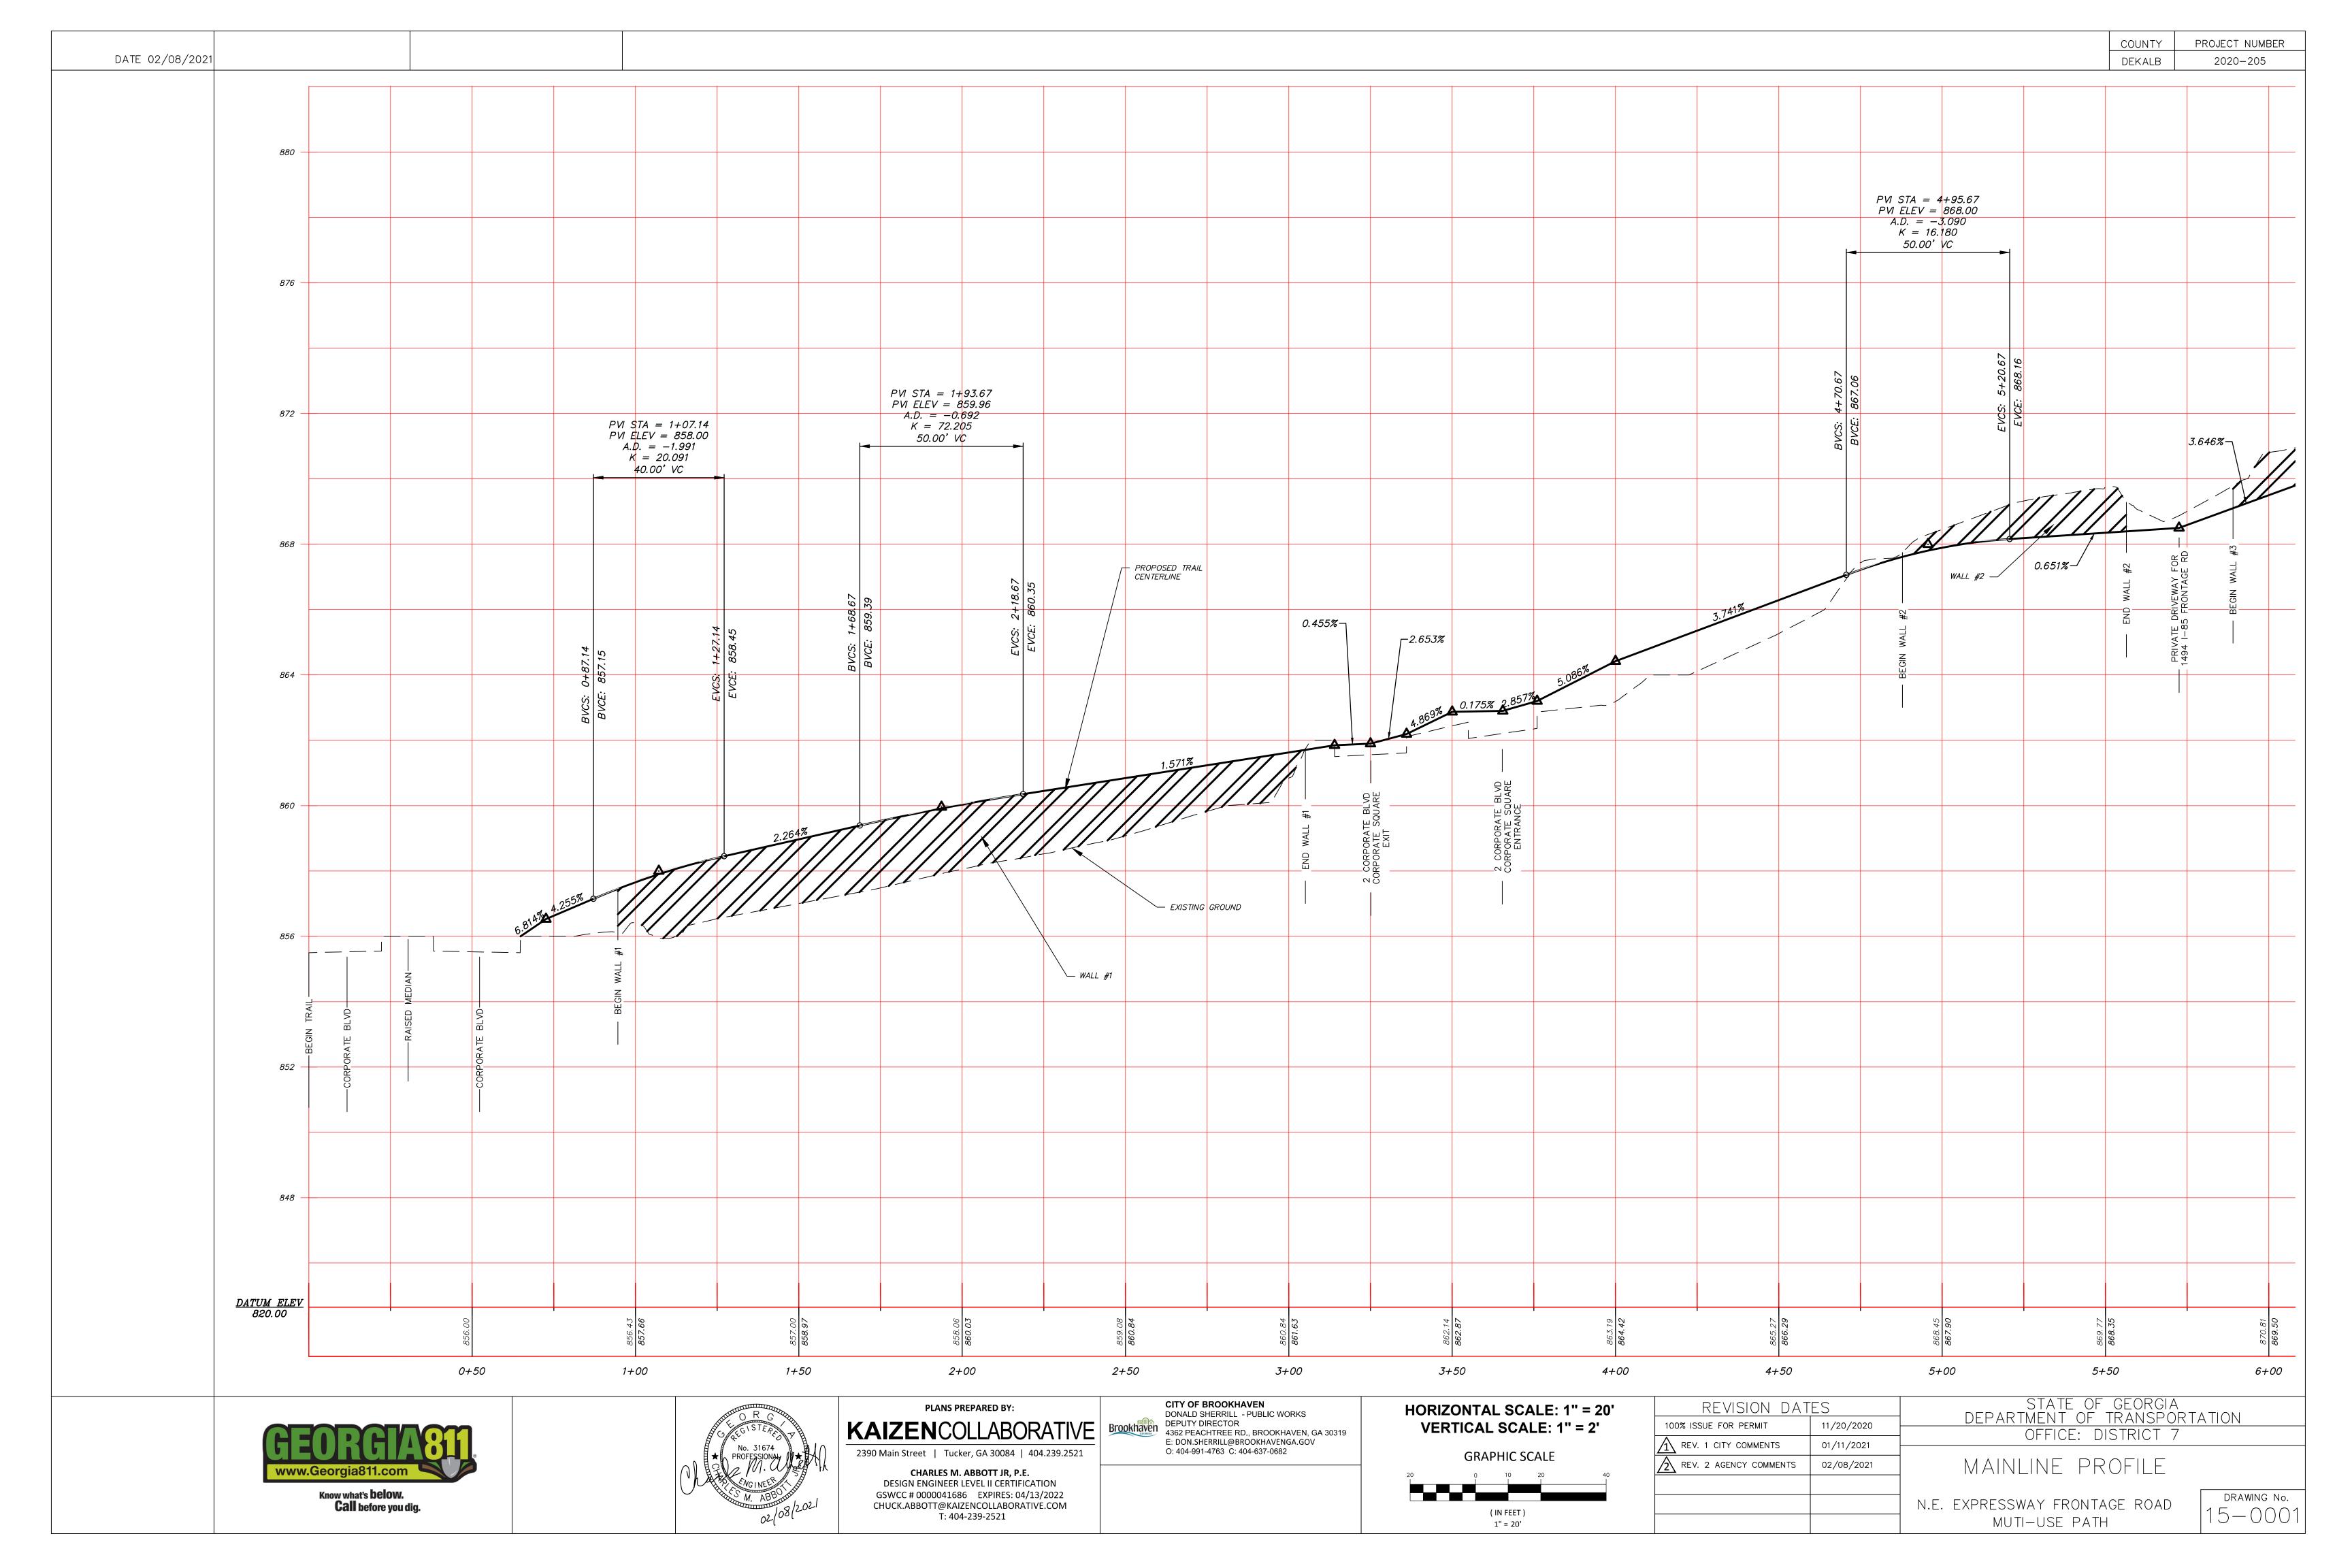

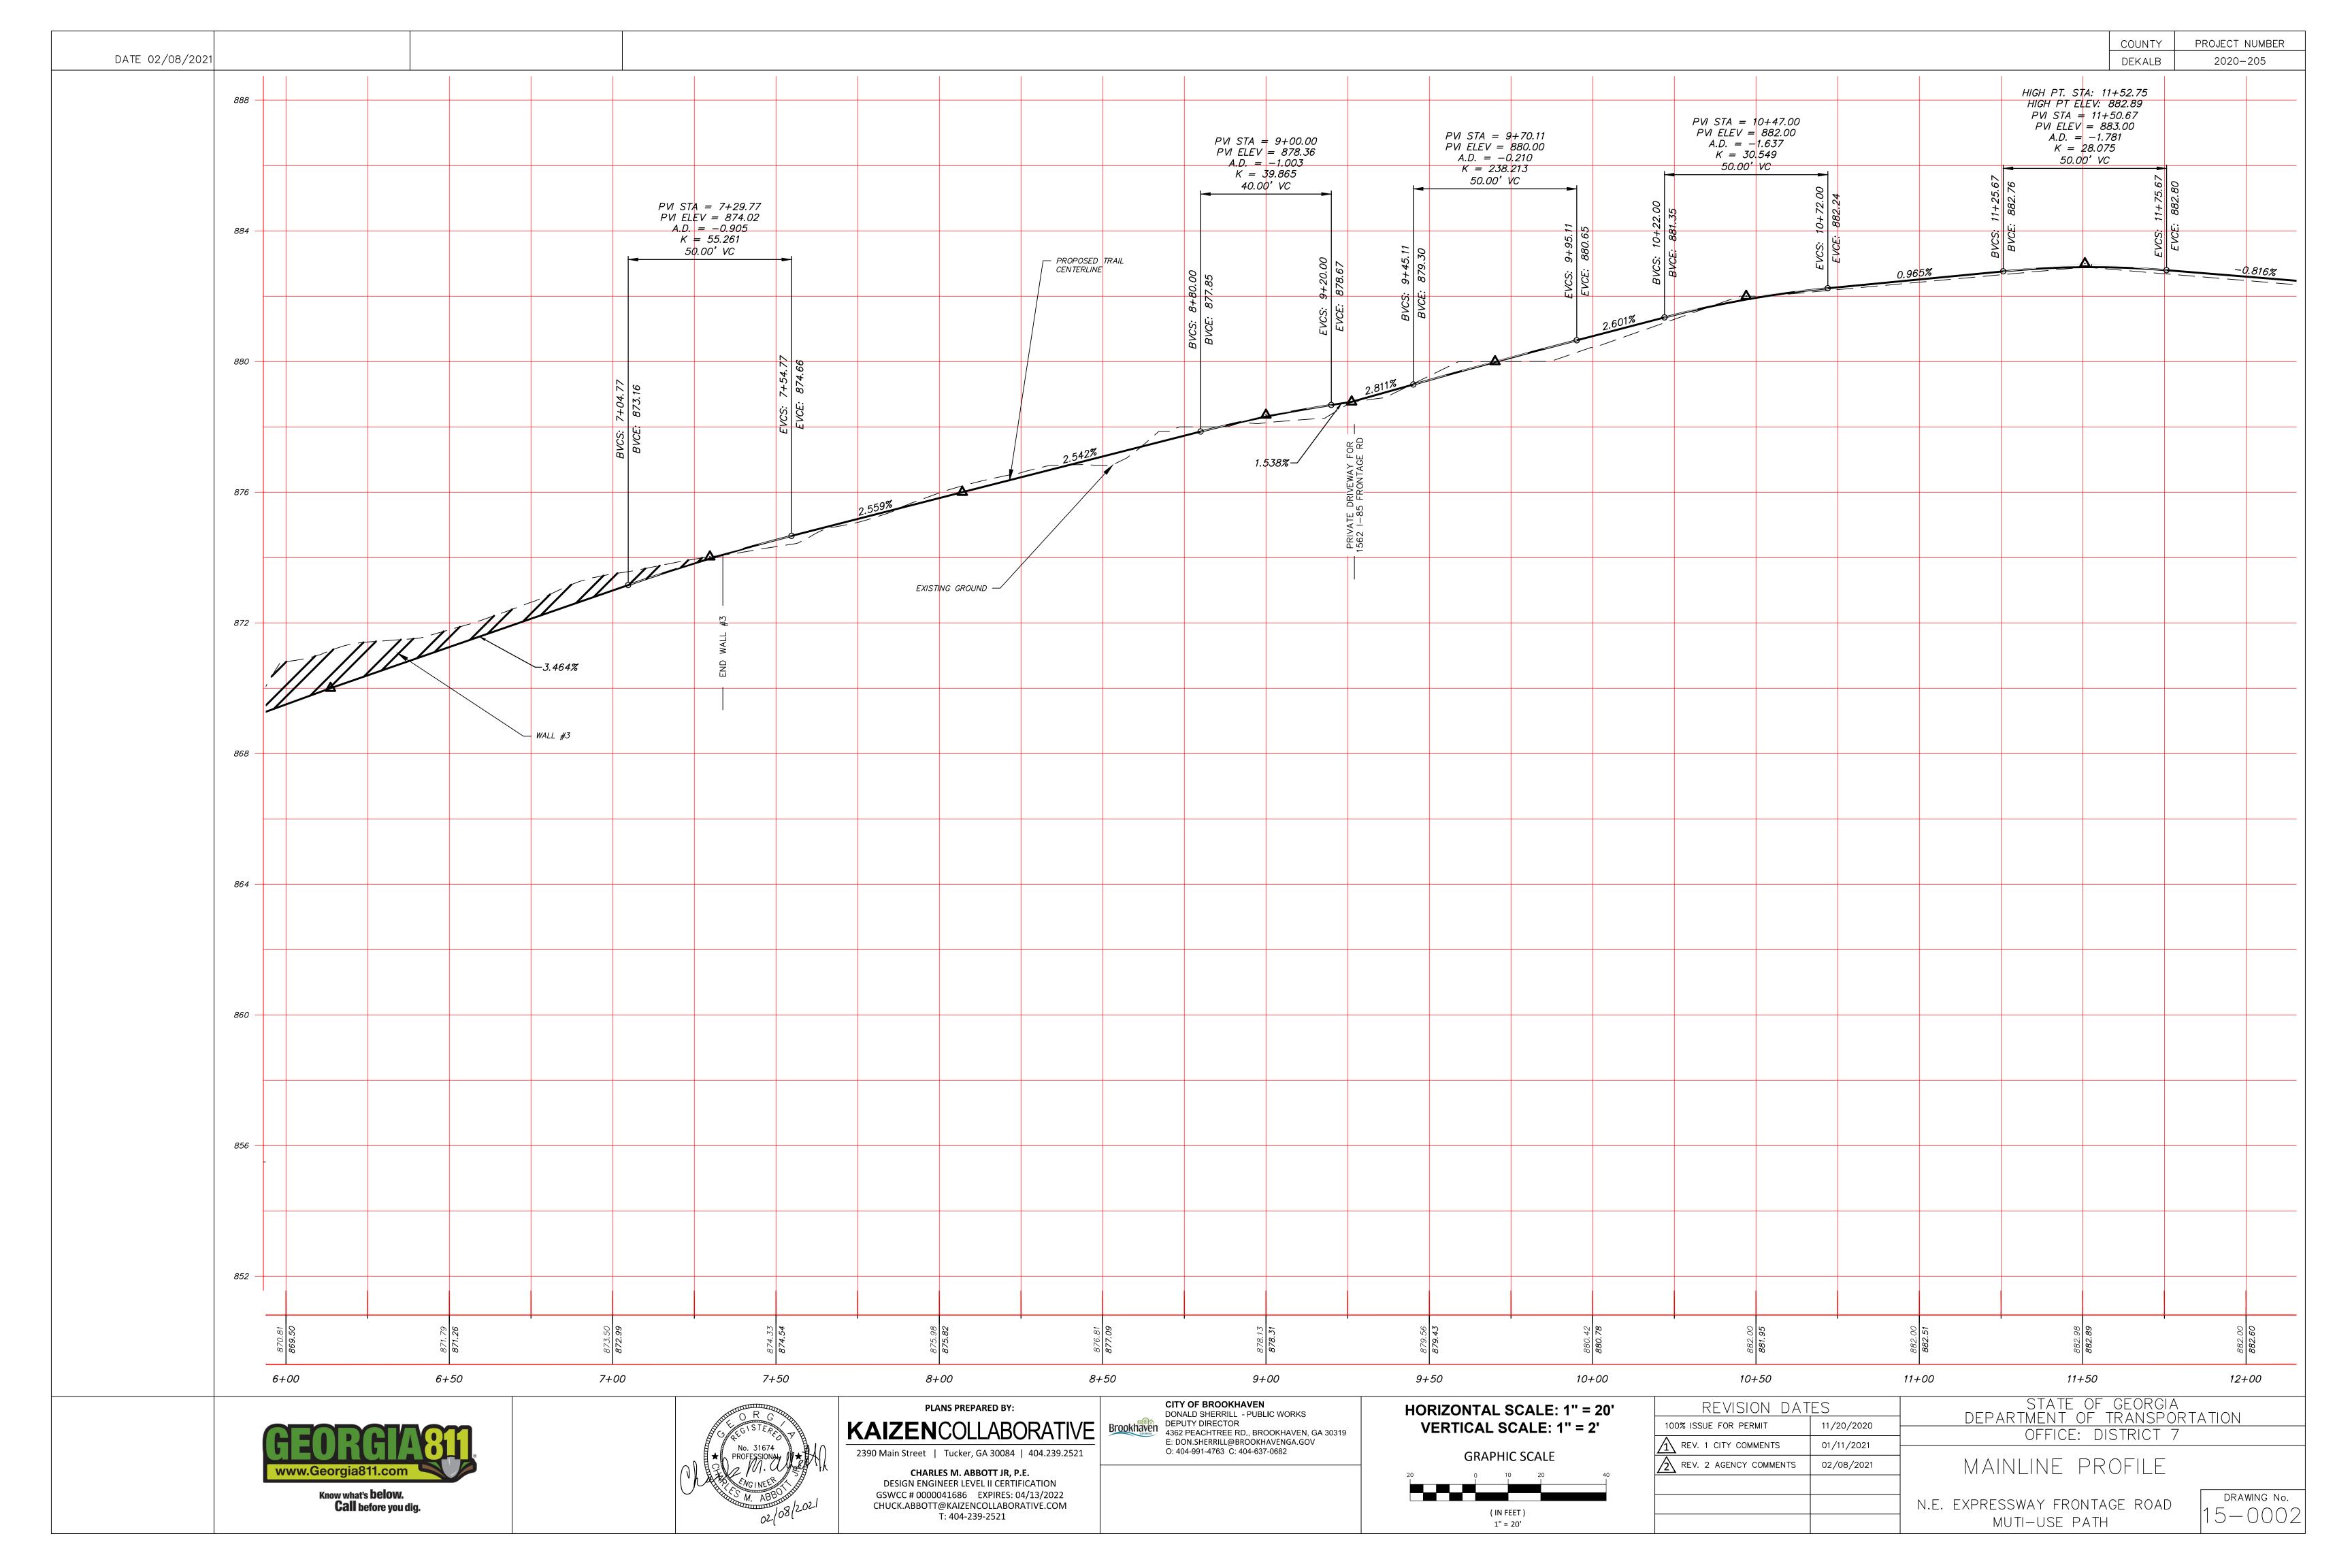

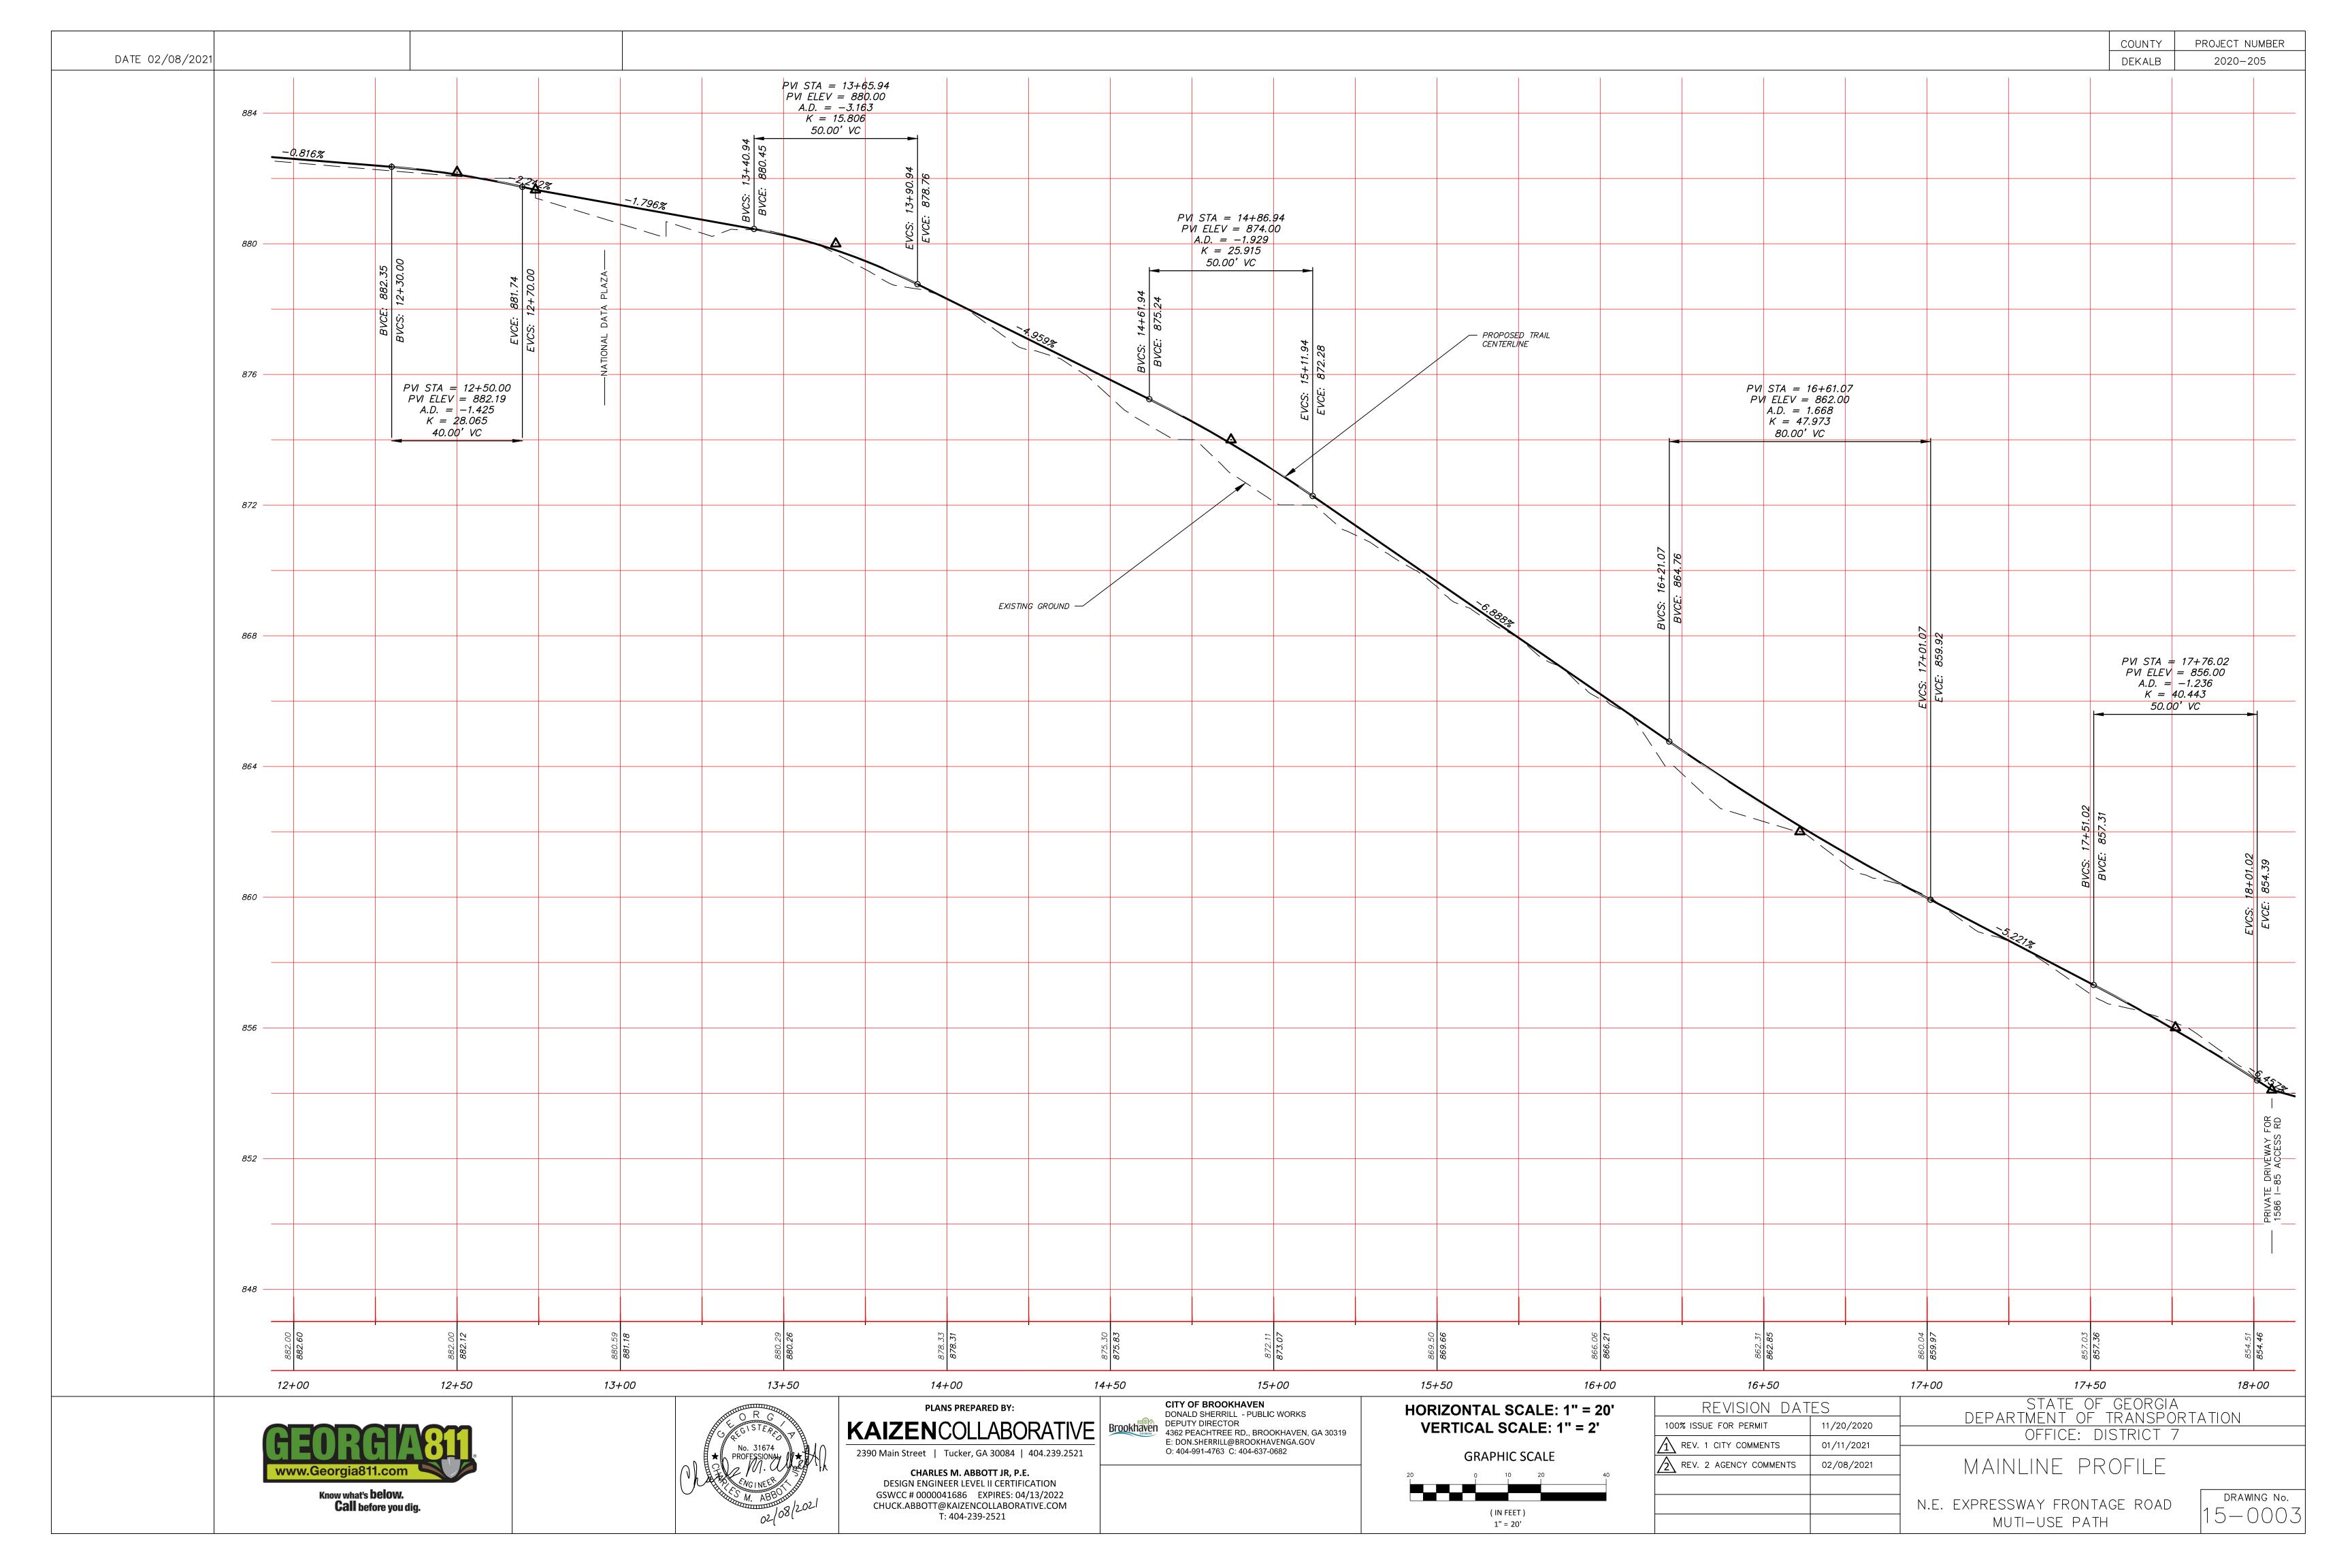

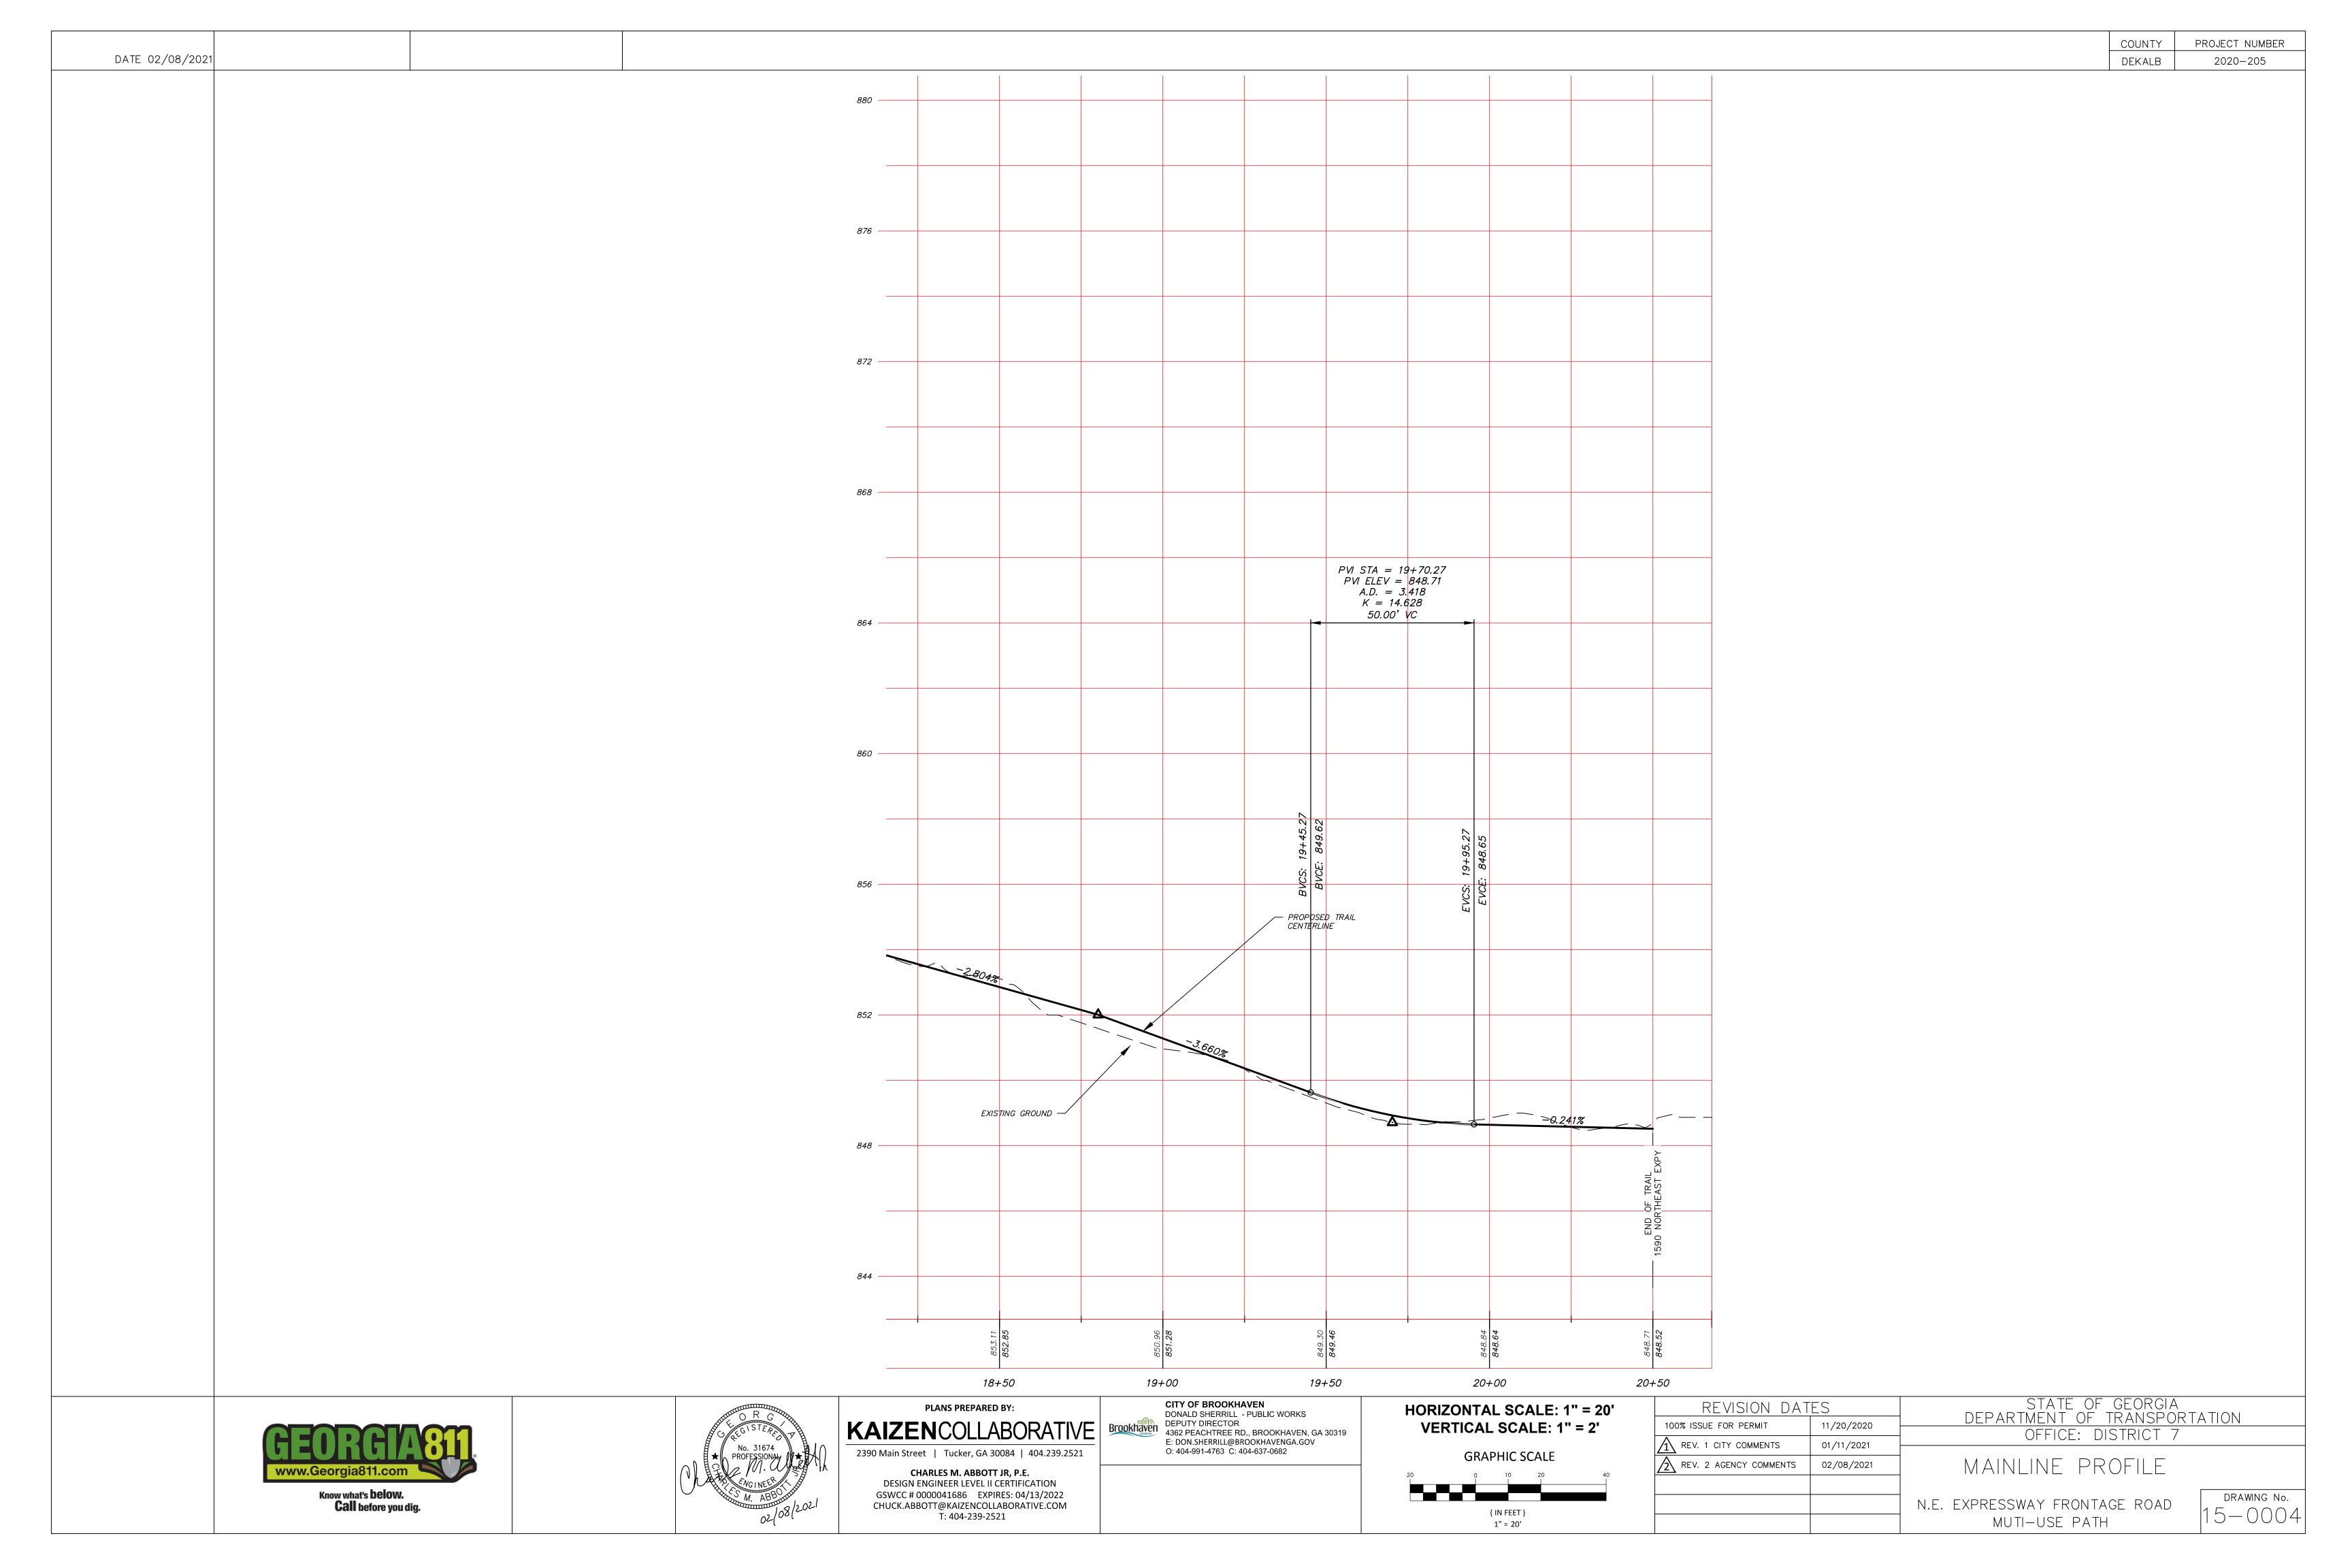

(IN FEET)

1" = 10'

DRAWING No.

N.E. EXPRESSWAY FRONTAGE ROAD

MUTI-USE PATH

CHARLES M. ABBOTT JR, P.E. DESIGN ENGINEER LEVEL II CERTIFICATION

GSWCC # 0000041686 EXPIRES: 04/13/2022


CHUCK.ABBOTT@KAIZENCOLLABORATIVE.COM


T: 404-239-2521


Know what's **below.**


Call before you dig.


DATE 02/08/2021

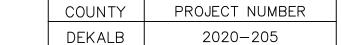


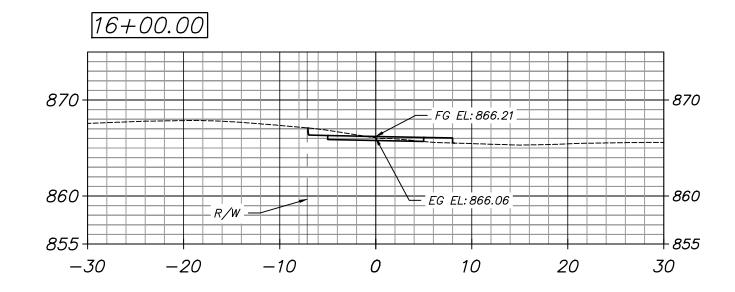


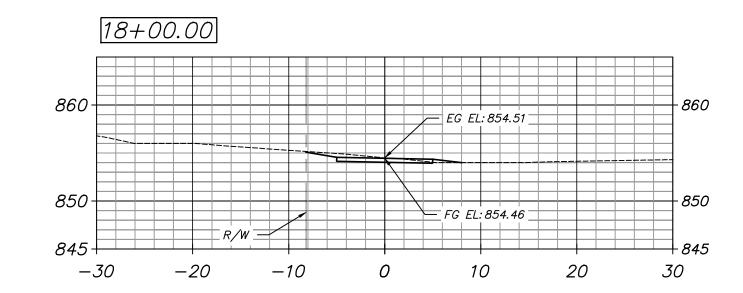


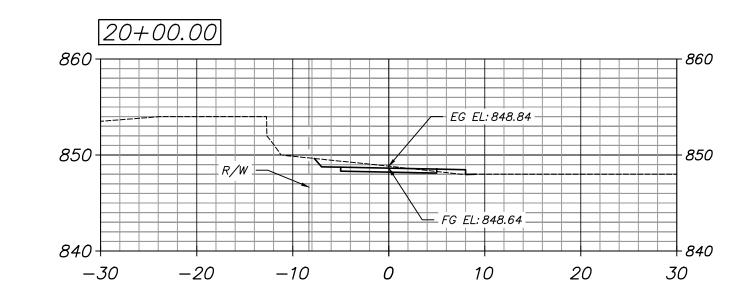


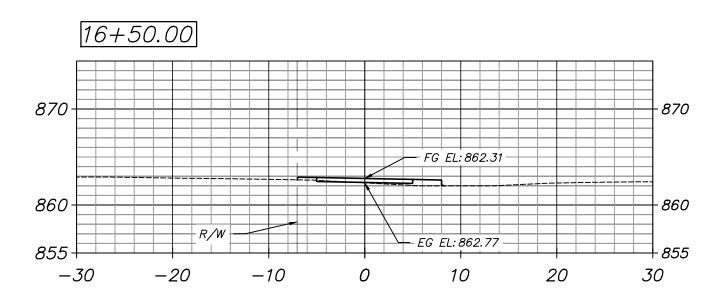


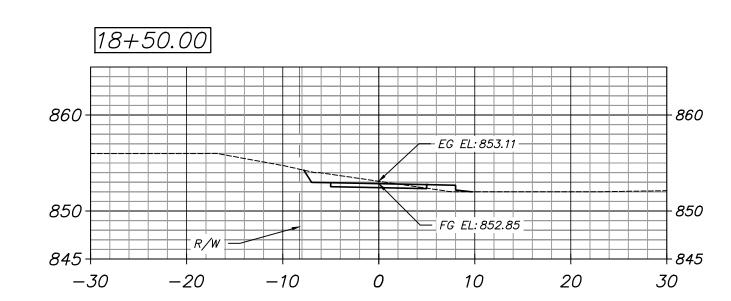


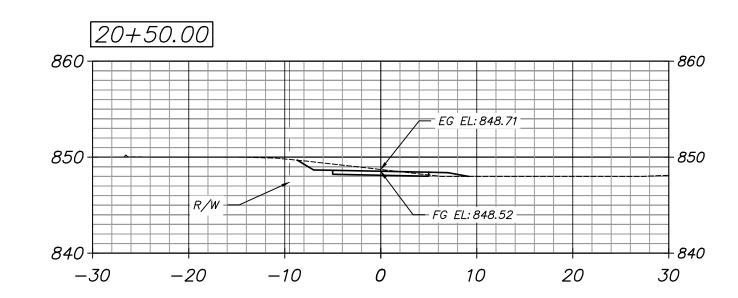

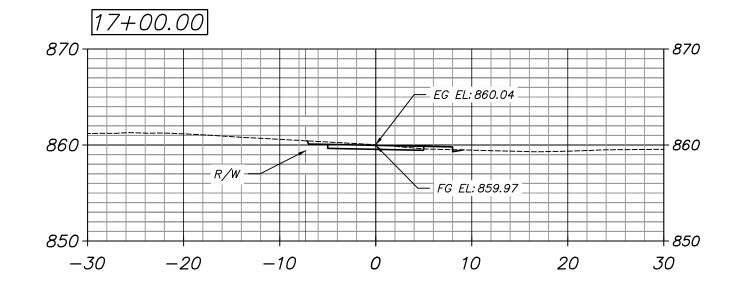


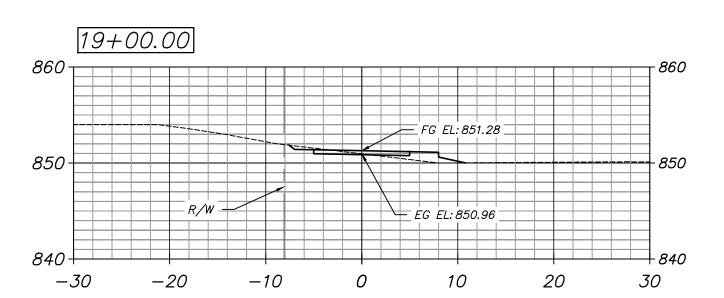

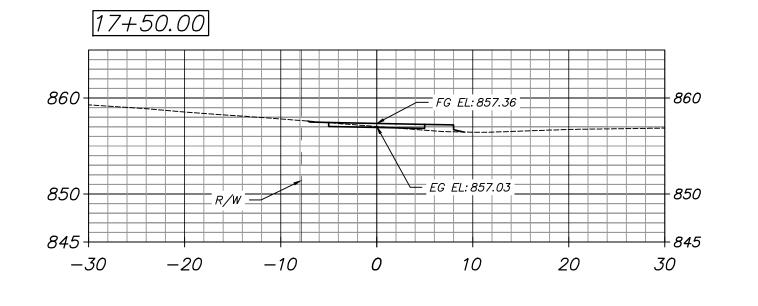

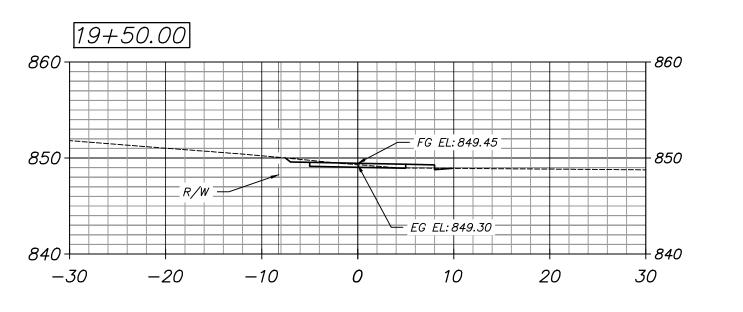



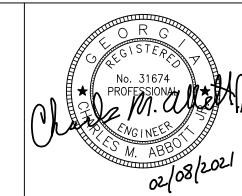

PLANS PREPARED BY: 2390 Main Street | Tucker, GA 30084 | 404.239.2521 CHARLES M. ABBOTT JR, P.E.

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VERTICAL SCALE: 1" = 10'					
	Gl	RAPH	IC SC	CALE	
10 L	(o I	5 	10 	20
(IN FEET) 1" = 10'					

HORIZONTAL SCALE: 1" = 10'

	REVISION DATES			
	100% ISSUE FOR PERMIT	11/20/2020		
\mathbb{Z}	1 REV. 1 CITY COMMENTS	01/11/2021		
Z	REV. 2 AGENCY COMMENTS	02/08/2021		

STATE OF GEORGIA DEPARTMENT OF TRANSPORTATION OFFICE: DISTRICT 7 CROSS-SECTIONS N.E. EXPRESSWAY FRONTAGE ROAD

MUTI-USE PATH

PROJECT NUMBER COUNTY DEKALB

2020-205

DRAWING No.

1. UTILITY LOCATIONS ARE APPROXIMATE AND ARE SHOWN FOR INFORMATIONAL PURPOSES ONLY, CONTRACTOR IS RESPONSIBLE FOR DETERMINING BOTH THE EXACT LOCATION OF ALL UTILITIES AND FOR THEIR PROTECTION DURING CONSTRUCTION. IT SHALL BE THE CONTRACTOR'S RESPONSIBILITY TO COORDINATE HIS OPERATIONS WITH ALL UTILITIES WHICH MAY BE EXISTING AND MAY BE IN CONFLICT WITH HIS WORK, THE CONTRACTOR IS TO PROTECT AND MAINTAIN SUCH UTILITIES.

2. THE CONTRACTOR IS REQUIRED TO RETAIN AN INDEPENDENT UTILITY LOCATING SERVICE TO LOCATE EXISTING UTILITIES ABOVE AND BELOW GRADE. THE CONTRACTOR SHALL CONTACT THE UTILITIES PROTECTION CENTER (800-282-7411) AS REQUIRED BY GEORGIA LAW, AND SHALL CONTACT ALL UTILITIES, AGENCIES OR DEPARTMENTS THAT OWN OR OPERATE UTILITIES IN THE VICINITY OF THE PROJECT SITE AT LEAST 48 BUSINESS HOURS (TWO BUSINESS DAYS) PRIOR TO EXCAVATION ACTIVITIES TO VERIFY THE LOCATIONS OF EXISTING UTILITIES.

3. CONTRACTOR SHALL EXERCISE FULL CARE AND SHALL USE APPROPRIATE METHODS AND EQUIPMENT DURING CONSTRUCTION ACTIVITIES AND PROVIDE PROTECTION OF UTILITIES, STRUCTURES, AND FACILITIES IN AND AROUND THE SITE. ALL EXISTING UTILITIES, IMPROVEMENTS, AND STRUCTURES WHICH ARE TO REMAIN, BUT ARE DAMAGED BY THE CONTRACTOR, SHALL BE REPAIRED OR REPLACED IN KIND BY THE CONTRACTOR AT HIS EXPENSE.

4. LOCATIONS, SIZES, AND MATERIALS OF EXISTING UTILITIES SHOWN ON THE PLANS ARE APPROXIMATE. UTILITIES SHOWN ON THESE DRAWINGS WERE COMPILED FROM INFORMATION FURNISHED BY THE UTILITY OWNERS AND BY SURVEYS PERFORMED BY STREET SMARTS AND AMEC. CONTRACTOR IS RESPONSIBLE FOR FIELD LOCATING ALL EXISTING UTILITIES SHOWN OR NOT SHOWN ON THE DRAWINGS PRIOR TO CONSTRUCTION.

5. THE WORK COVERED BY THESE DRAWINGS INCLUDES THE FURNISHING OF ALL LABOR, EQUIPMENT, MATERIALS, AND INSURANCE REQUIRED TO RELOCATE EXISTING UTILITIES AND CONSTRUCT AND INSTALL ALL NEW UTILITIES SHOWN ON THESE DRAWINGS OR AS DIRECTED BY THE OWNER'S REPRESENTATIVE OR UTILITY OWNER.

6. CONTRACTOR SHALL COORDINATE WORK WITH GEORGIA POWER, ATLANTA GAS LIGHT, DEKALB COUNTY WATER/SEWER DEPARTMENT, ALL TELECOMMUNICATION PROVIDERS, AND ANY OTHER UTILITY COMPANIES FOR UTILITY RELOCATION PRIOR TO CONSTRUCTION ACTIVITY.

7. CONTRACTOR SHALL INSTALL PIPE MATERIALS WITH BEDDING CLASS/TYPE AS SHOWN ON THE DRAWINGS, UNLESS OTHERWISE SPECIFIED.

8. ANY WORK PERTAINING TO UTILITY POLES SHALL COMPLY WITH THE REQUIREMENTS OF THE APPROPRIATE UTILITY.

9. SEPARATE SEARCH FOR EASEMENTS OF RECORD IS NOT TO BE I PLIED BY THESE DRAWINGS.

10. CONTRACTOR SHALL INSTALL STEEL COVER PLATES ON OPEN TRENCHES OR HOLES AT THE END OF EACH DAY'S WORK TO PROTECT THE PUBLIC. THE PLATES WILL BE PLACED IN DRIVEWAYS AS WELL AS ROADS.

11. CONTRACTOR SHALL PROVIDE PROPER SUPPORT FOR EXISTING UTILITIES DURING CONSTRUCTION TO PREVENT DAMAGE TO EXISTING UTILITIES. ANY DAMAGE DUE TO THE CONTRACTOR'S OPERATIONS SHALL BE REPAIRED BY THE RESPECTIVE UTILITY OWNER AND PAID FOR BY THE CONTRACTOR.

12. THE CONTRACTOR SHALL CONFIRM ALL EXISTING STORM INLETS, SEWER MANHOLES, AND INVERT ELEVATIONS PRIOR TO BEGINNING CONSTRUCTION.

13. BACKFILL OF ALL TRENCHES SHALL BE FREE OF DEBRIS. STUMPS. ROOTS. OR OTHER FOREIGN MATERIAL AND COMPACTED TO AT LEAST 95% OF THE MAXIMUM DRY DENSITY OF THE MATERIAL, AS DETERMINED BY THE STANDARD PROCTOR COMPACTION TEST METHOD (ASTM D698). WHERE TRENCHES ARE LOCATED IN PAVED AREAS THE UPPER TWO FEET OF BACKFILL SHALL BE COMPACTED TO 98% OF THE MAXIMUM DRY DENSITY OF THE MATERIAL. CORRECTIONS OF ANY TRENCH SETTLEMENT WITHIN ONE YEAR FROM THE DATE OF ACCEPTANCE BY THE OWNER SHALL BE RESPONSIBILITY OF THE CONTRACTOR.

14. WHERE CITY OF BROOKHAVEN AND/OR DEKLAB COUNTY PUBLIC WORKS REGULATIONS CONFLICT WITH THE ABOVE, CITY OR COUNTY REQUIREMENTS SHALL BE FOLLOWED.

15. DEKALB COUNTY GIS UTILITY DATA FOR APPROXIMATE LOCATIONS OF DEEP SANITARY AND STORM LINES. THESE UTILITIES ARE SCHEDULED TO REMAIN IN USE AND PROTECTED THROUGHOUT THE PROJECT DURATION.

LEGEND

AIF ANGLE IRON FOUND

AMF ALUM. MONUMENT FOUND

BC BACK OF CURB BSL BUILDING SETBACK LINE

CB CATCH BASIN ⟨¬¬⟩ CABLE BOX

C/L CENTERLINE

CMF CONC. MONUMENT FOUND

CLEANOUT CONC. CONCRETE

CTF CRIMPED TOP FOUND

DB DEED BOOK

DE DRAINAGE EASEMENT

■ DROP INLET EP EDGE OF PAVEMENT

ESMT EASEMENT

♠ FIRE HYDRANT

G GAS METER

GMD GEORGIA MILITIA DISTRICT HEADWALL

IPS 1/2" REBAR SET

 JUNCTION BOX LL LAND LOT

LLL LAND LOT LINE

☆ LIGHT POLE

MH) MANHOLE

MNS MAG NAIL SET N/F NOW OR FORMERLY

OHP OVERHEAD POWER

OTF OPEN TOP FOUND PB PLAT BOOK

POWER BOX

P/L PROPERTY LINE POB POINT OF BEGINNING

POWER POLE PS PLAT SLIDE

RBF REBAR FOUND

R/W RIGHT OF WAY

S/D SUBDIVISION

☐ SERVICE POLE

UTILITY MANHOLE

WATER METER **WATER VALVE**

(a) YARD INLET

UTILITY CONTACTS IN PROJECT AREA, BUT NOT LIMITED TO:

GEORGIA POWER ELECTRICAL:

GAS: ATLANTA GAS LIGHT

DEKALB COUNTY SEWER:

WATER: DEKALB COUNTY TELECOM: COMCAST, AT&T

AT&T, CROWN CASTLE FIBER OPTICS:

COMCAST, AT&T CABLE TV:

LINETYPE LEGEND

-0- FENCE

-G- GAS LINE

OVERHEAD POWER SEWER LINE

—UT— UNDERGROUND COMMUNICATION


—UP— UNDERGROUND POWER LINE

—W— WATER LINE

-900- CONTOUR LINE

P/L EXISTING PROPERTY LINE **─R/W** EXISTING RIGHT-OF-WAY


www.Georgia811.com Know what's **below**. **Call** before you dig.

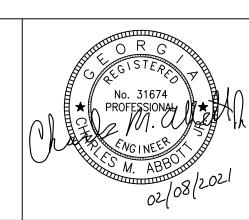




CHARLES M. ABBOTT JR, P.E. **DESIGN ENGINEER LEVEL II CERTIFICATION** GSWCC # 0000041686 EXPIRES: 04/13/2022 CHUCK.ABBOTT@KAIZENCOLLABORATIVE.COM T: 404-239-2521



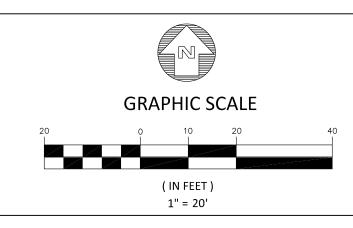

REVISION DATES		STATE OF GEORGIA		
100% ISSUE FOR PERMIT	11/20/2020	DEPARTMENT OF TRANSPORTATION OFFICE: DISTRICT 7		
REV. 1 CITY COMMENTS	01/11/2021	OTTICE: DISTRICT /		
2 REV. 2 AGENCY COMMENTS	02/08/2021	UTILITY NOTES AND LEGEND		
		DRAV		
		N.E. EXPRESSWAY FRONTAGE ROAD MUTI-USE PATH 24-		

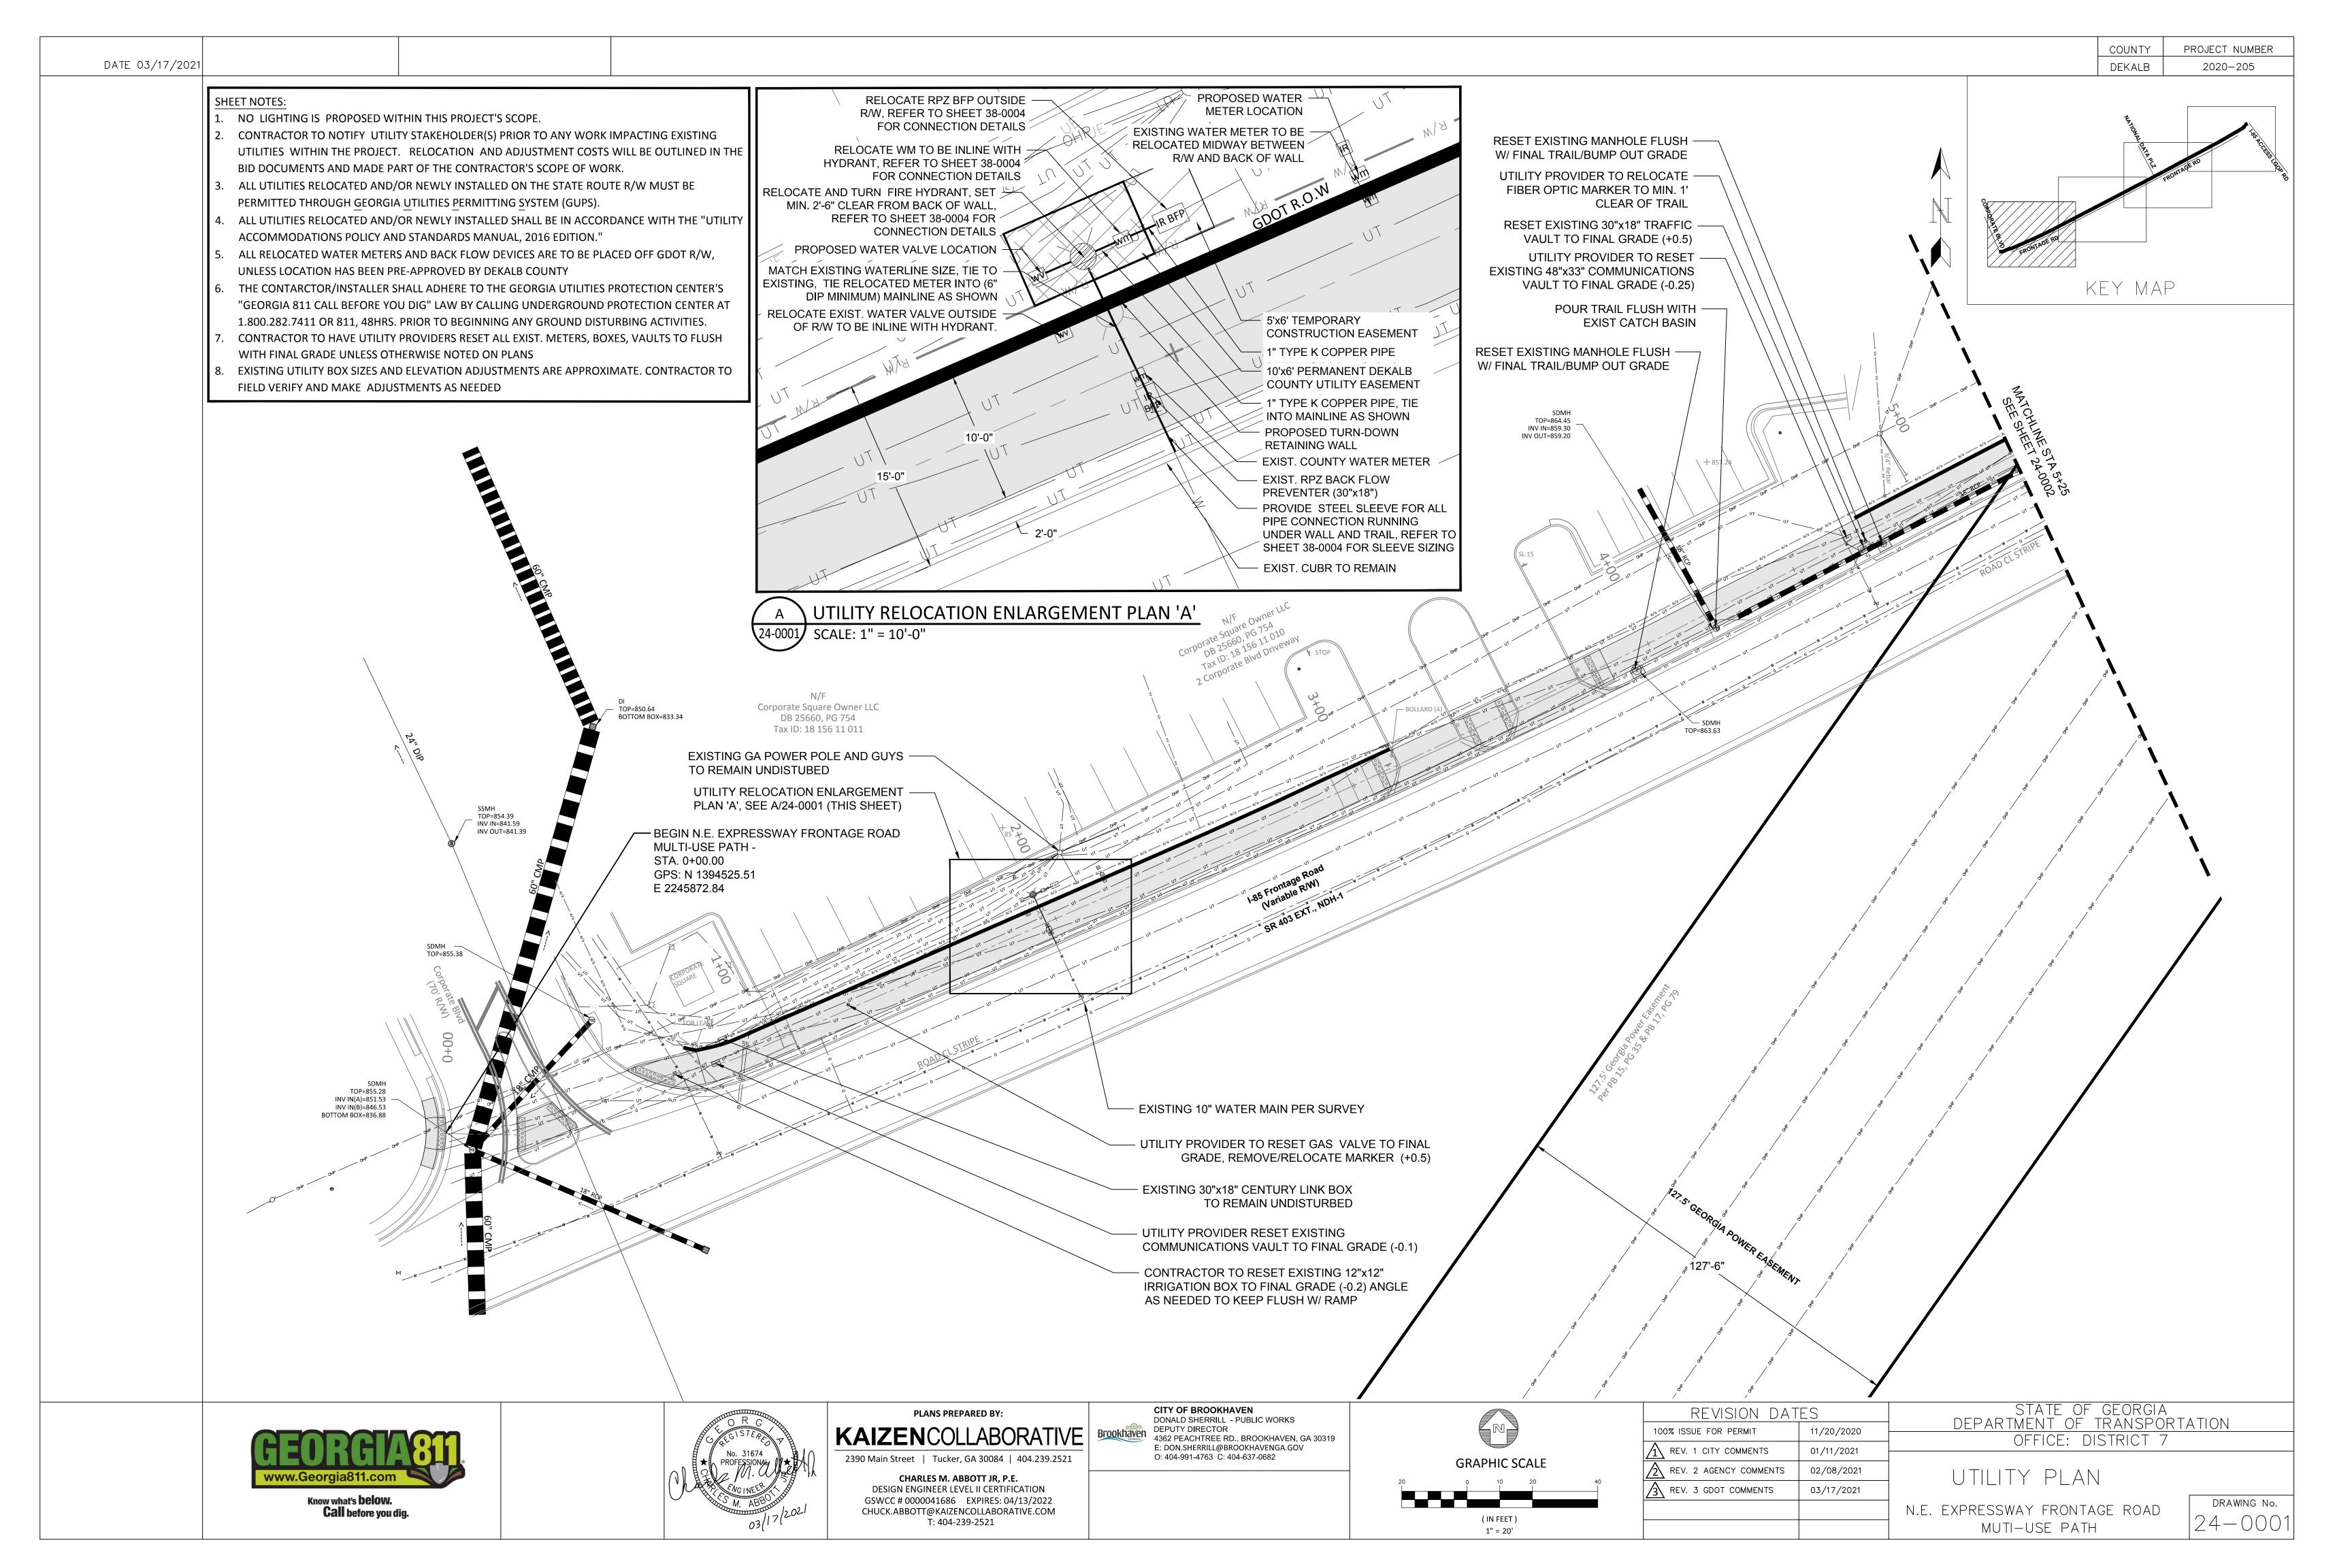

1" = 20'

MUTI-USE PATH

(IN FEET)

1" = 20'

MUTI-USE PATH

CHUCK.ABBOTT@KAIZENCOLLABORATIVE.COM

T: 404-239-2521


PROJECT NUMBER COUNTY DEKALB

2020-205

GENERAL NOTES - STANDARD SIGNS

- 1. ALL STANDARD HIGHWAY SIGNS SHALL BE FABRICATED AN ERECTED IN ACCORDANCE WITH THE DETAILS SHOWN IN THE PLANS. THE MANUAL ON UNIFORM TRAFFIC CONTROL DEVICES, CURRENT EDITION, AND THE GEORGIA SPECIFICATIONS. SUPPLEMENTAL SPECIFICATIONS AND/OR SPECIAL PROVISIONS.
- 2. SIGN FRECTION STATIONS ARE APPROXIMATE AND MAY BE ADJUSTED TO MEET FIELD CONDITIONS WHERE NECESSARY. BUT SHALL BE WITHIN THE LIMITATIONS SET FROTHING THE MANUAL ON UNIFORM TRAFFIC CONTROL DEVICES. CURRENT EDITION. NIO SIGN LOCATION SHALL BE CHANGED BY THE CONTRACTOR OR BY THE PROJECT ENGINEER WITHOUT PRIOR APPROVAL FROM THE OFFICE OF TRAFFIC SAFETY AND DESIGN.
- 3. ALL STANDARD HIGHWAY SIGNS SHALL BE ERECTED AT A HEIGHT OF 7 FEET ABOVE THE NORMAL EDGE OF PAVEMENT TO THE BUTTON OF THE SIGN OR ASSEMBLY.
- 4a. HORIZONTAL CLEARANCE FOR STANDARD HIGHWAY SIGNS ON INTERSTATE HIGHWAYS SHALL BE 32 FEET FROM THE NORMAL EDGE OF PAVEMENT TO THE NEARER EDGE OF THE SIGN(S), UNLESS SPECIFIED OTHERWISE IN THE PLANS. HORIZONTAL CLEARANCE FOR STANDARD HIGHWAY SIGNS ON RAMPS SHALL BE 2 FEET FROM THE NORMAL EDGE OF PAVED SHOULDER, OR EDGE OF GRADED SHOULDER WHEN PRESENT.
- 4b. HORIZONTAL CLEARANCE FOR STANDARD HIGHWAY SIGNS ON ALL OTHER ROADWAYS SHALL BE 6 FEET FROM THE EDGE OF THE PAVED SHOULDER OR 12 FEET FROM THE NORMAL EDGE OF PAVEMENT TO THE NEARER EDGE OF THE SIGN(S), WHICHEVER IS GREATER. THE HORIZONTAL CLEARANCE IN NON-MOUNTABLE CURB SECTIONS SHALL BE AT LEAST 2 FEET FROM THE CURB FACE TO THE NEARER EDGE OF THE SIGN(S).
- 4c. HORIZONTAL CLEARANCE FOR STANDARD HIGHWAY SIGNS MOUNTED BEHIND GUARD RAIL SHALL BE 6 FEET FROM THE FACE OF THE GUARD RAIL TO THE NEARER EDGE OF THE SIGN(S).
- 5. SINGLE PLATE, HORIZONTAL RECTANGULAR SIGNS OVER 48 INCHES IN WIDTH SHALL BE MOUNTED ON TWO POSTS WITH 2 EACH 2 INCH X 1/2 INCH X (WIDTH OF SIGN) ALUMINUM OR GALVANIZED STEEL STRAPS. THE STRAPS SHALL BE FLUSH WITH THE BACK OF THE SIGN WITH ONE EACH ACROSS THE TOP AND BOTTOM OF THE SIGN. THE CENTERLINE OF EACH POST SHALL BE INSET 1/6TH OF THE SIGN WIDTH FROM THE EDGE OF THE SIGN. SIGN PLATE BOLT HOLES SHALL BE 3/8 INCH DIAMETER, DRILLED OR PUNCHED. AS SHOWN ON THE SIGN PLATE DETAILS.
- 6. EACH 42 OR 48 INCH WIDE X 18 OR 24 INCH HIGH SIGN REQUIRES ONE 2 INCH X 1/2 INCH X (WIDTH OF SIGN) ALUMINUM OR GALVANIZED STEEL STRAP LOCATED IN THE CENTER OF THE SIGN AND FLUSH WITH THE BACK OF THE SIGN.
- 7. SIGN ASSEMBLIES SHALL BE MOUNTED ON ALUMINUM OR GALVANIZED STEEL STRAP FRAMES. FOR DETAILS AND STRAP SPECIFICATIONS REFER TO SIGN ASSEMBLY TYPICAL FRAMING DETAILS.
- 8. TYPE 3 (HIGH INTENSITY) REFLECTIVE SHEETING SHALL BE USED FOR ALL STANDARD HIGHWAY SIGNS REQUIRING REFECTORIES BACKGROUNDS EXCEPT AS SPECIFIED BELOW OR SPECIFIED OTHERWISE IN THE PLANS. EITHER CLASS 1 OR CLASS 2 ADHESIVE BACKING IS PERMISSIBLE.
- 9. TYPE 9 (VERY HIGH INTENSITY) REFLECTIVE SHEETING SHALL BE USED FOR ALL RED SERIES SIGNS (R1-1, R1-2, R1-3P, R5-1, R5-1A, R5-1B).
- 10. TYPE 9 (VERY HIGH INTENSITY) FLUORESCENT YELLOW GREEN REFLECTIVE SHEETING SHALL BE USED FOR SCHOOL ZONE (S1-1, S2-1, S3-1, S4-3, AND THE TOP PORTION OF THE S5-1) SIGNS. BICYCLE CROSSING (W11-1) SIGNS. AND PEDESTRIAN CROSSING (W11-2 AND W11A-2) SIGNS. SIGNS WITHIN THE SAME ASSEMBLY AS THE SCHOOL ZONE SIGNS SPECIFICALLY LISTED ABOVE AND ALL REGULATORY SIGNS PLACED AS PART OF THE SCHOOL ZONE SIGNING SHALL HAVE TYPE IX (VERY HIGH INTENSITY) REFLECTIVE SHEETING BACKGROUNDS OF THE APPROPRIATE COLOR.
- 11. TYPE 9 (VERY HIGH INTENSITY) FLUORESCENT YELLOW REFLECTIVE SHEETING SHALL BE USED FOR ALL WARNING SIGNS.
- 12. A 1/2 INCH MINIMUM AIR SPACE SHALL BE REQUIRED BETWEEN ALL SIGN PLATES WITHIN AN ASSEMBLY.
- 13. WHERE SIGNS WITHIN AN ASSEMBLY EXTEND BELOW THE STANDARD MOUNTING HOLES ON THE POST(S). ADDITIONAL 3/8 INCH DIAMETER HOLE(S). DRILLED OR PUNCHED. SHALL BE REQUIRED TO PROPERLY MOUNT THE ASSEMBLY.
- 14. INTERSTATE SHIELDS SHALL CONTAIN THE WORD GEORGIA. ALL INTERSTATE. U.S., AND GEORGIA SHIELD REQUIRING ALT, BUS, COMM, LOOP. OR SPUR SHALL USE 4 INCH SERIES "D" LETTERS. REFER TO THE MANUAL ON UNIFORM TRAFFIC CONTROL DEVICES. CURRENT EDITION FOR DETAILS.
- 15. FOR DETAILS OF SPECIAL DESIGN HIGHWAY SIGNS, SEE DETAILS OF MISCELLANEOUS
- 16. REFER TO PLAN SHEETS FOR LOCATION OF THE DISTRICT ENGINEERS OFFICE TO BE SHOWN ON ALL R552-1 (LIMITED ACCESS) SIGNS IN THIS PROJECT. IF ANY.
- 17. THE CONTRACTOR WILL. AS REQUESTED BY THE DISTRICT TRAFFIC OPERATIONS ENGINEER. BE REQUIRED TO REMOVE ANY EXISTING SIGNS THAT ARE DUPLICATED OR ARE CONTRARY TO THESE SIGN PLANS.




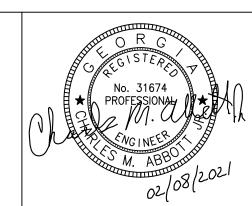

PLANS PREPARED BY: KAIZENCOLLABORATIVE Brookhaven 2390 Main Street | Tucker, GA 30084 | 404.239.2521

CHARLES M. ABBOTT JR, P.E. DESIGN ENGINEER LEVEL II CERTIFICATION GSWCC # 0000041686 EXPIRES: 04/13/2022 CHUCK.ABBOTT@KAIZENCOLLABORATIVE.COM T: 404-239-2521


CITY OF BROOKHAVEN DONALD SHERRILL - PUBLIC WORKS DEPUTY DIRECTOR 4362 PEACHTREE RD., BROOKHAVEN, GA 30319 E: DON.SHERRILL@BROOKHAVENGA.GOV O: 404-991-4763 C: 404-637-0682

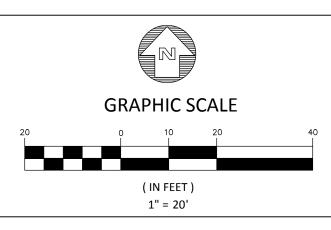



REVISION DAT	ES	
100% ISSUE FOR PERMIT	11/20/2020	
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REV. 2 AGENCY COMMENTS	02/08/2021] 51
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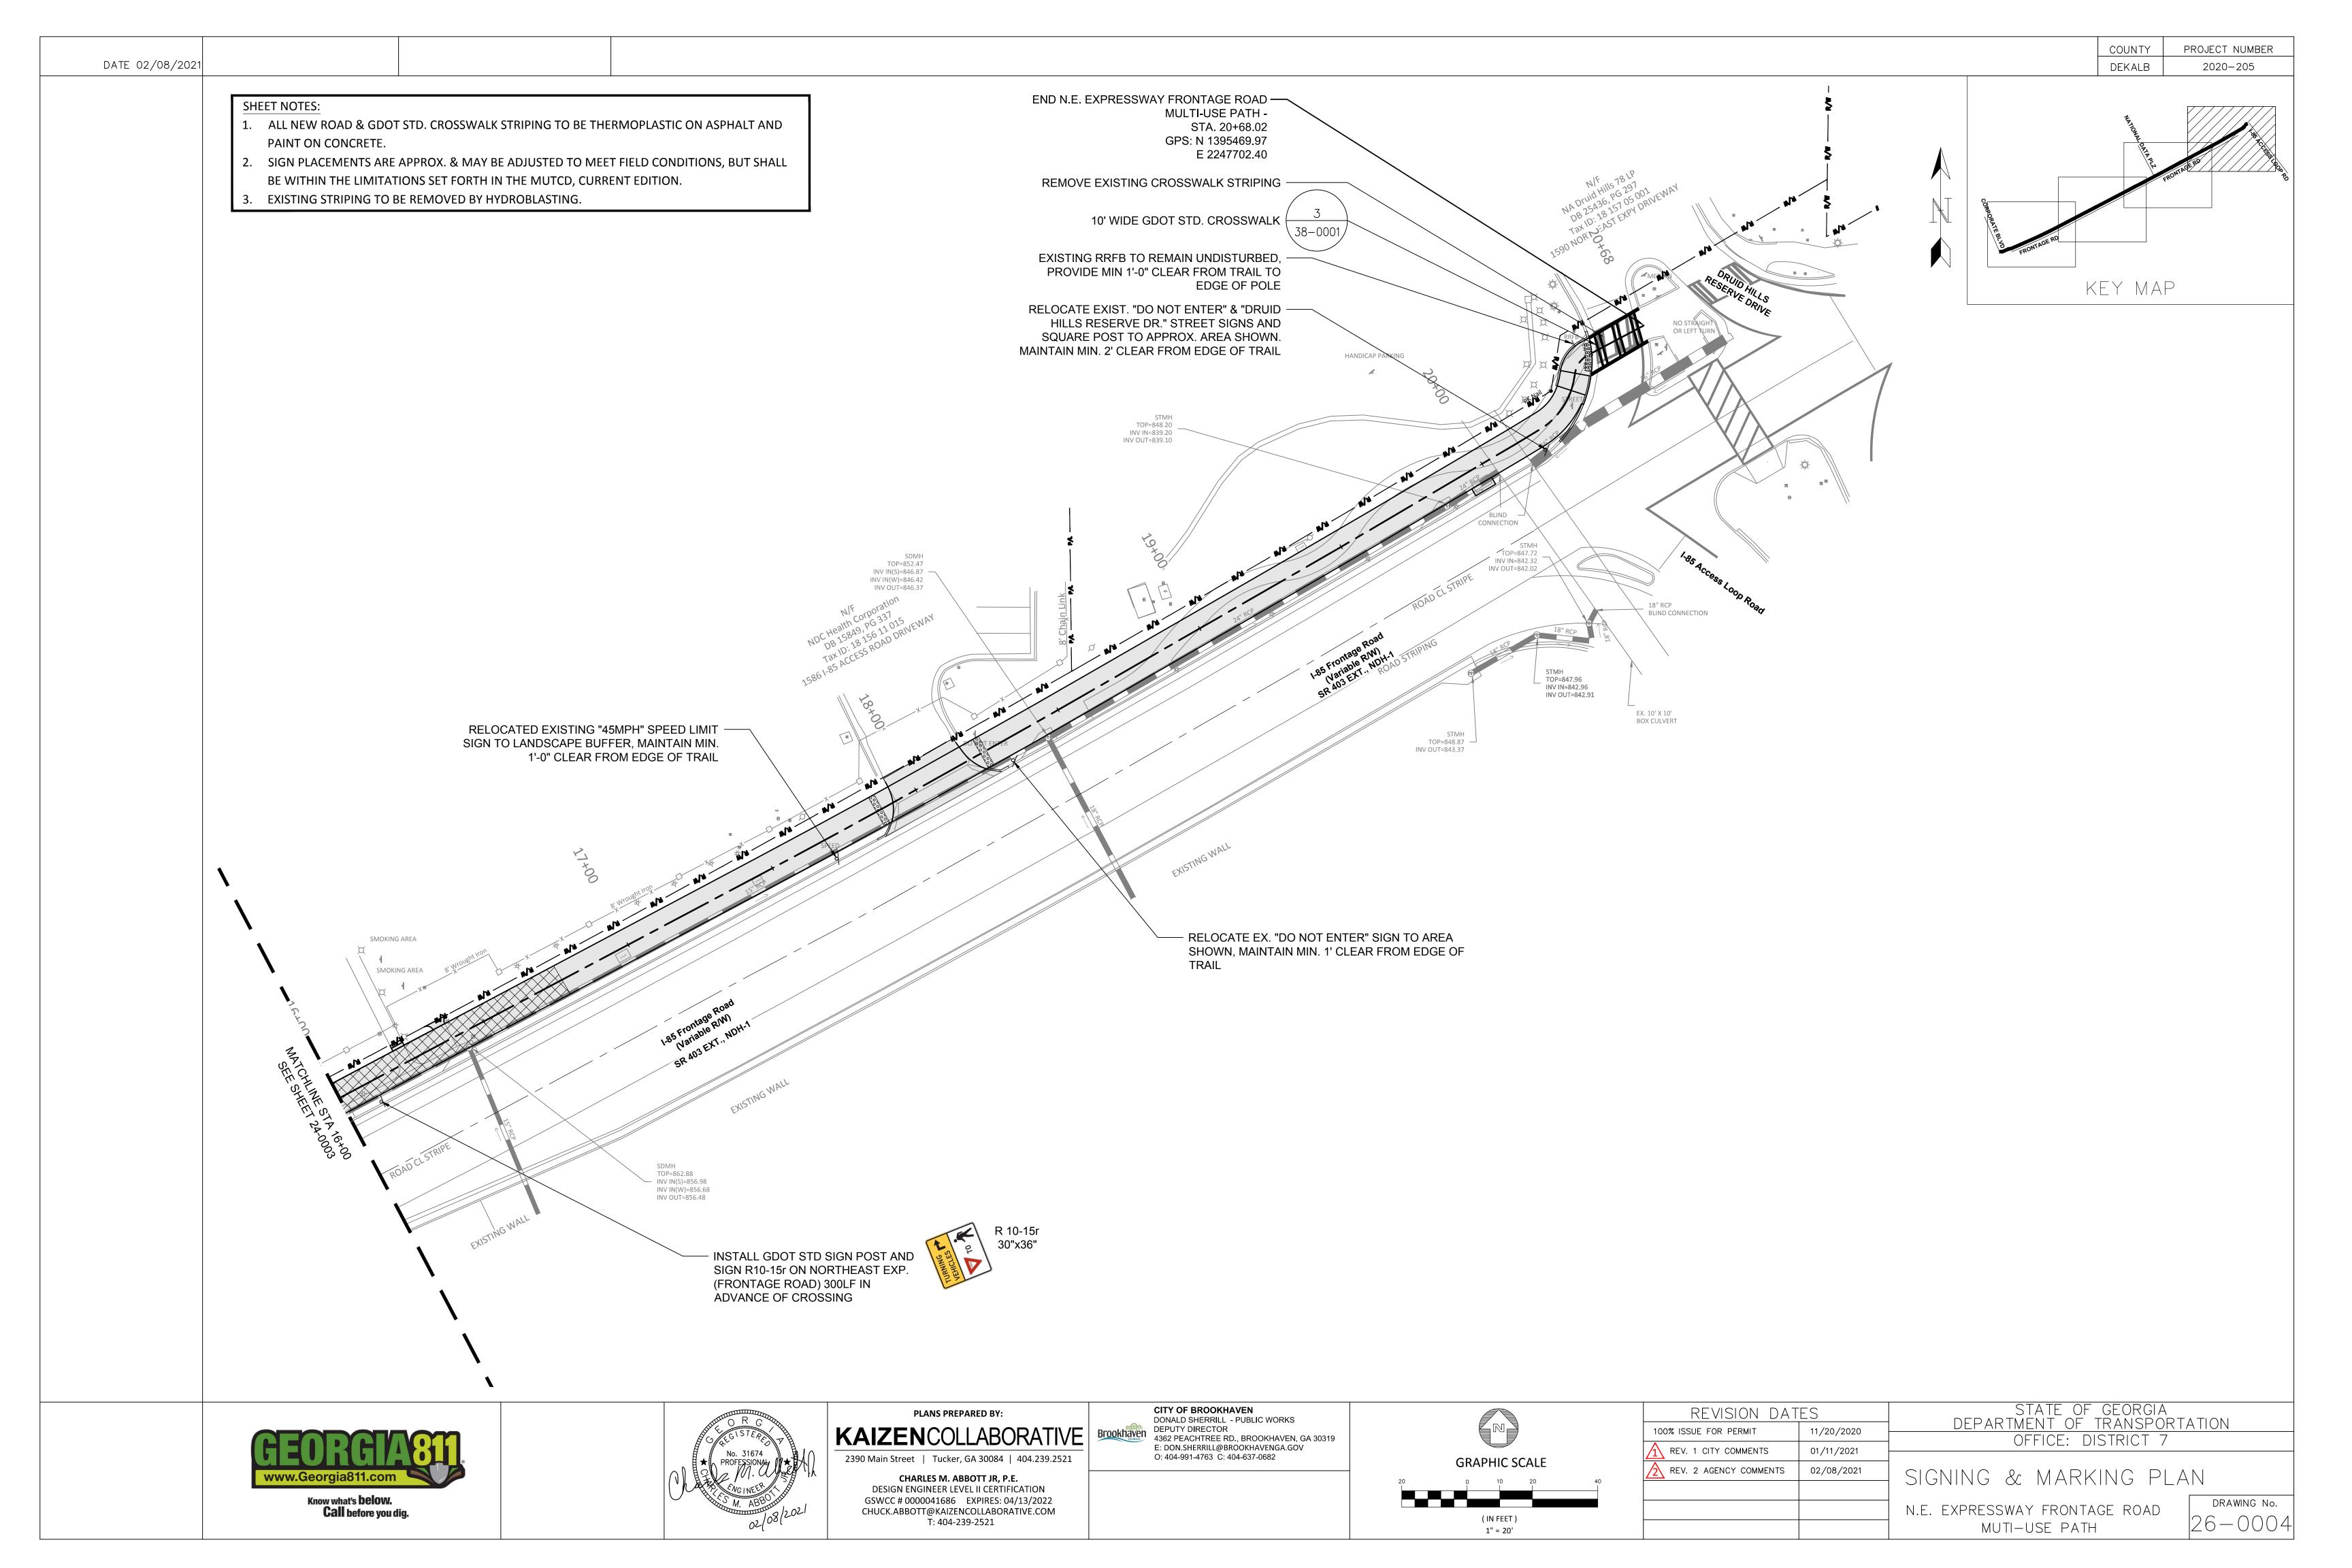
STATE OF GEORGIA DEPARTMENT OF TRANSPORTATION OFFICE: DISTRICT 7 IGNING AND MARKING

NOTES AND DETAILS E. EXPRESSWAY FRONTAGE ROAD MUTI-USE PATH



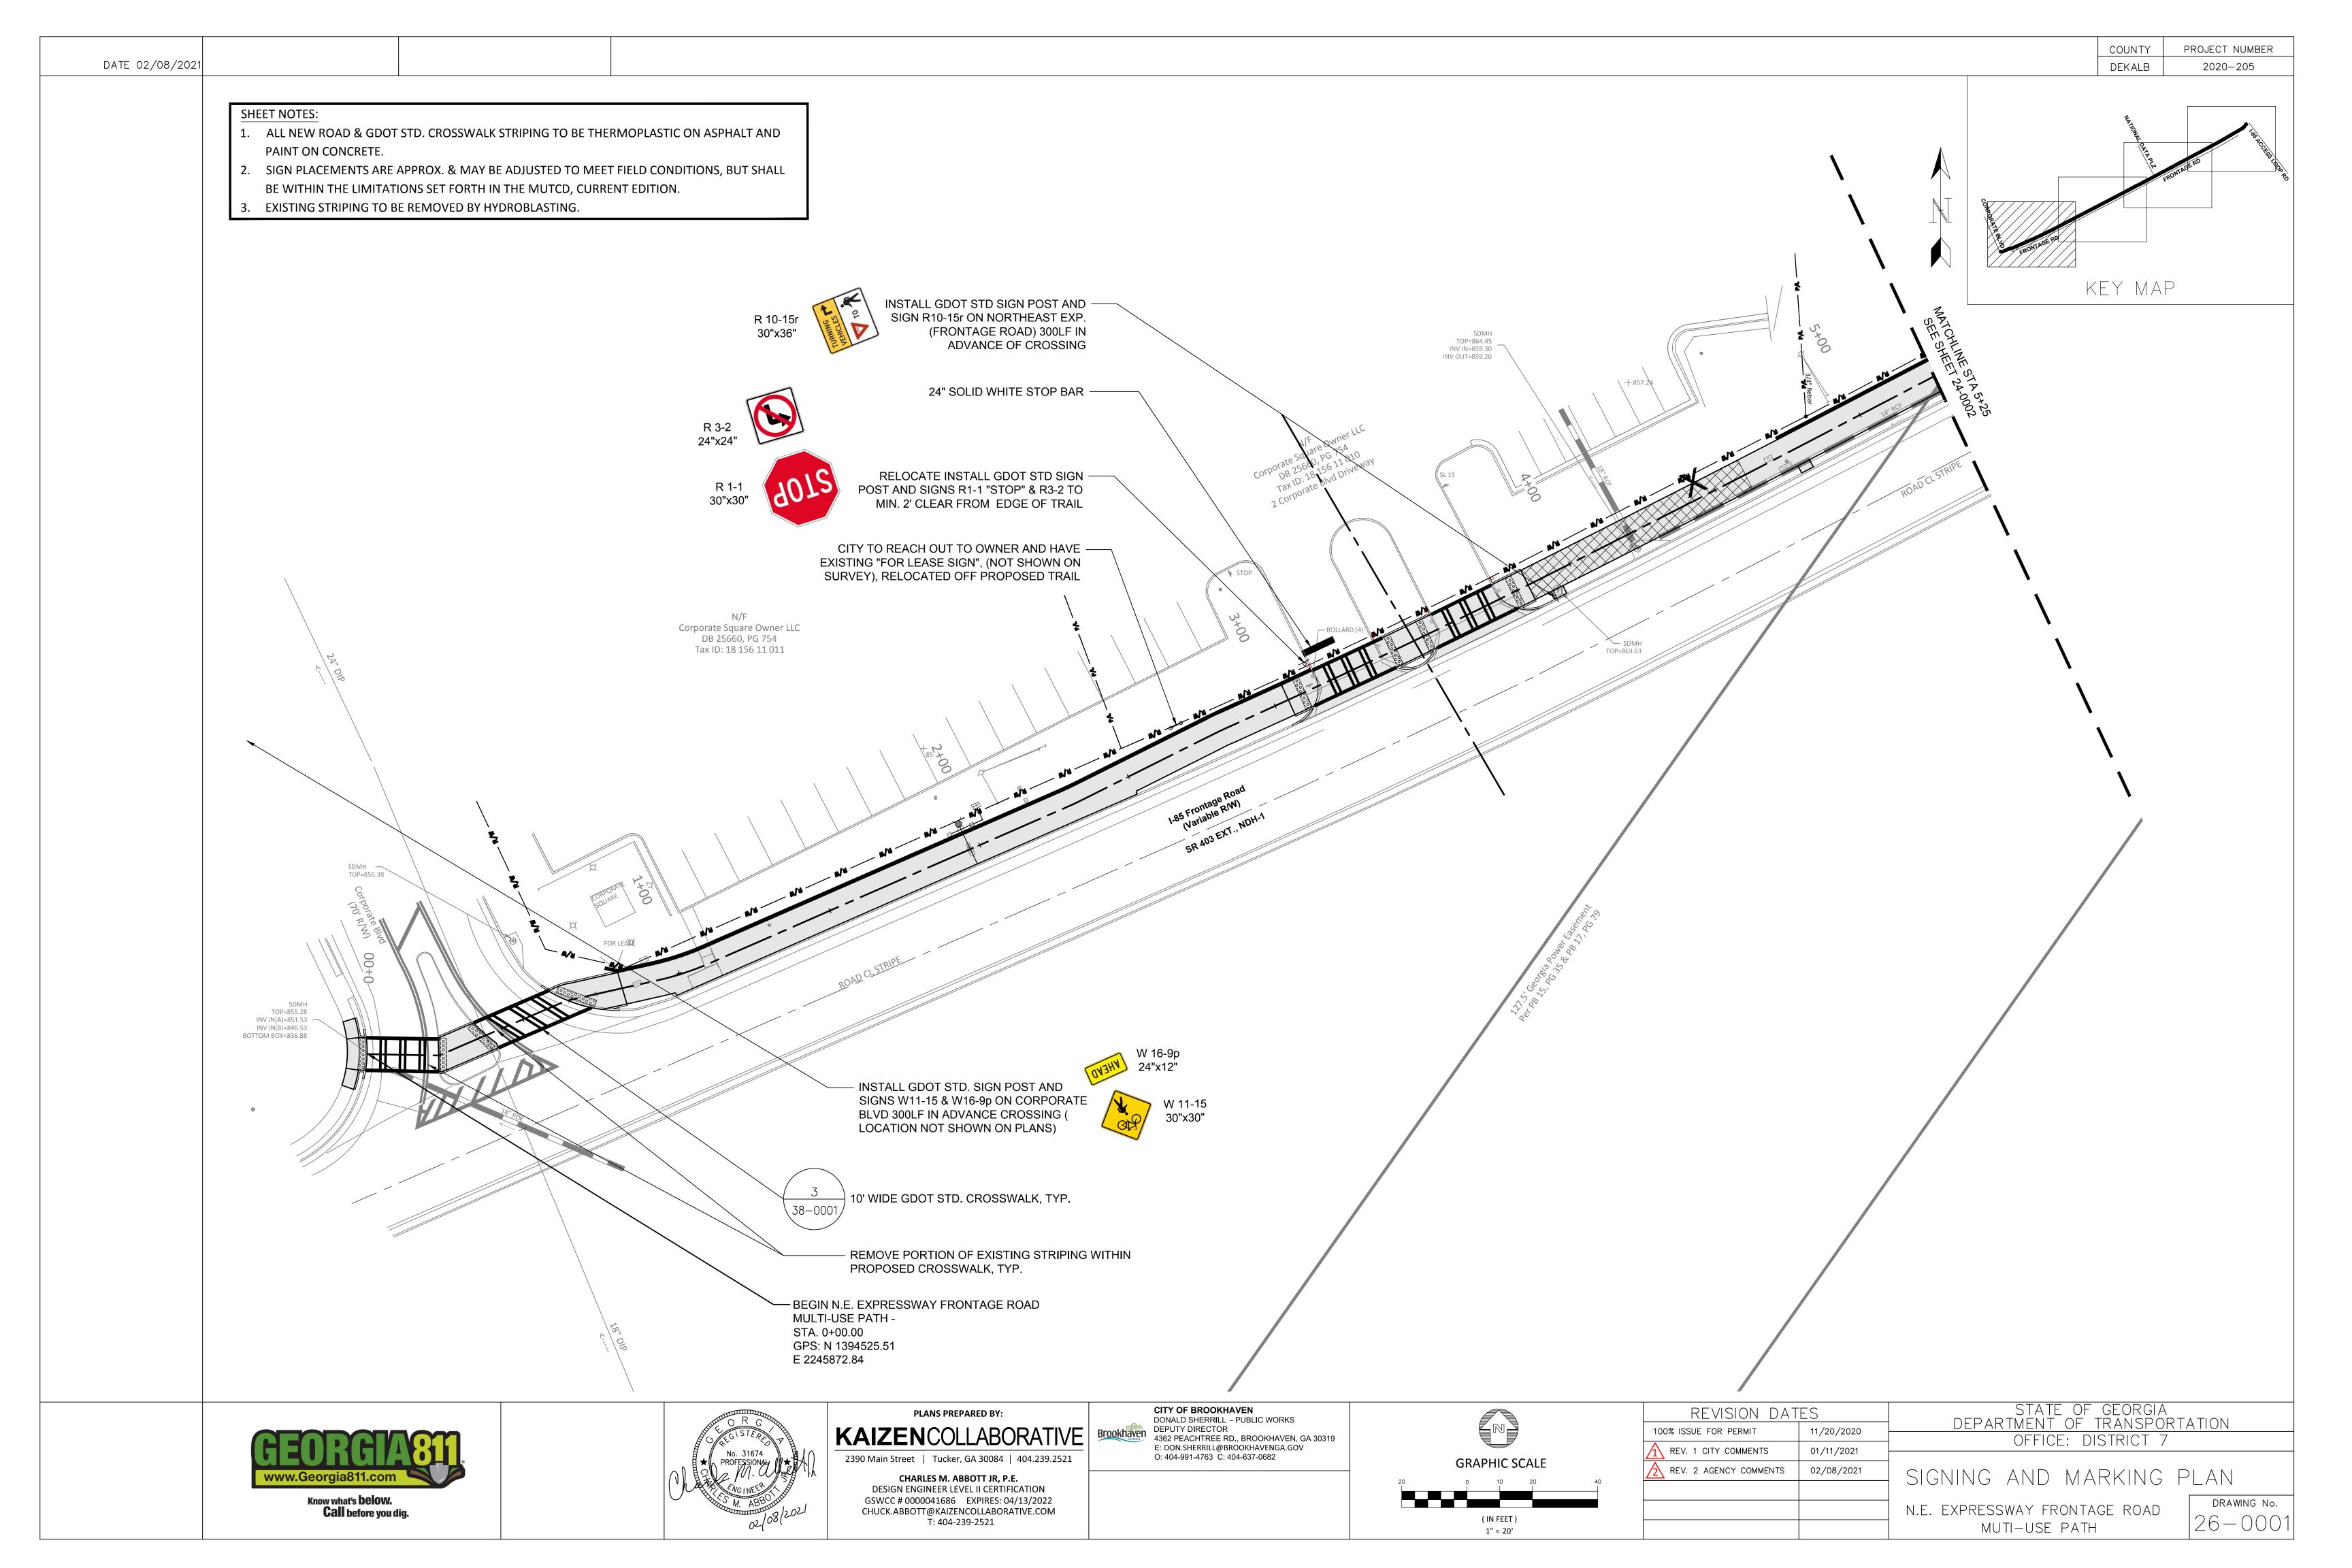

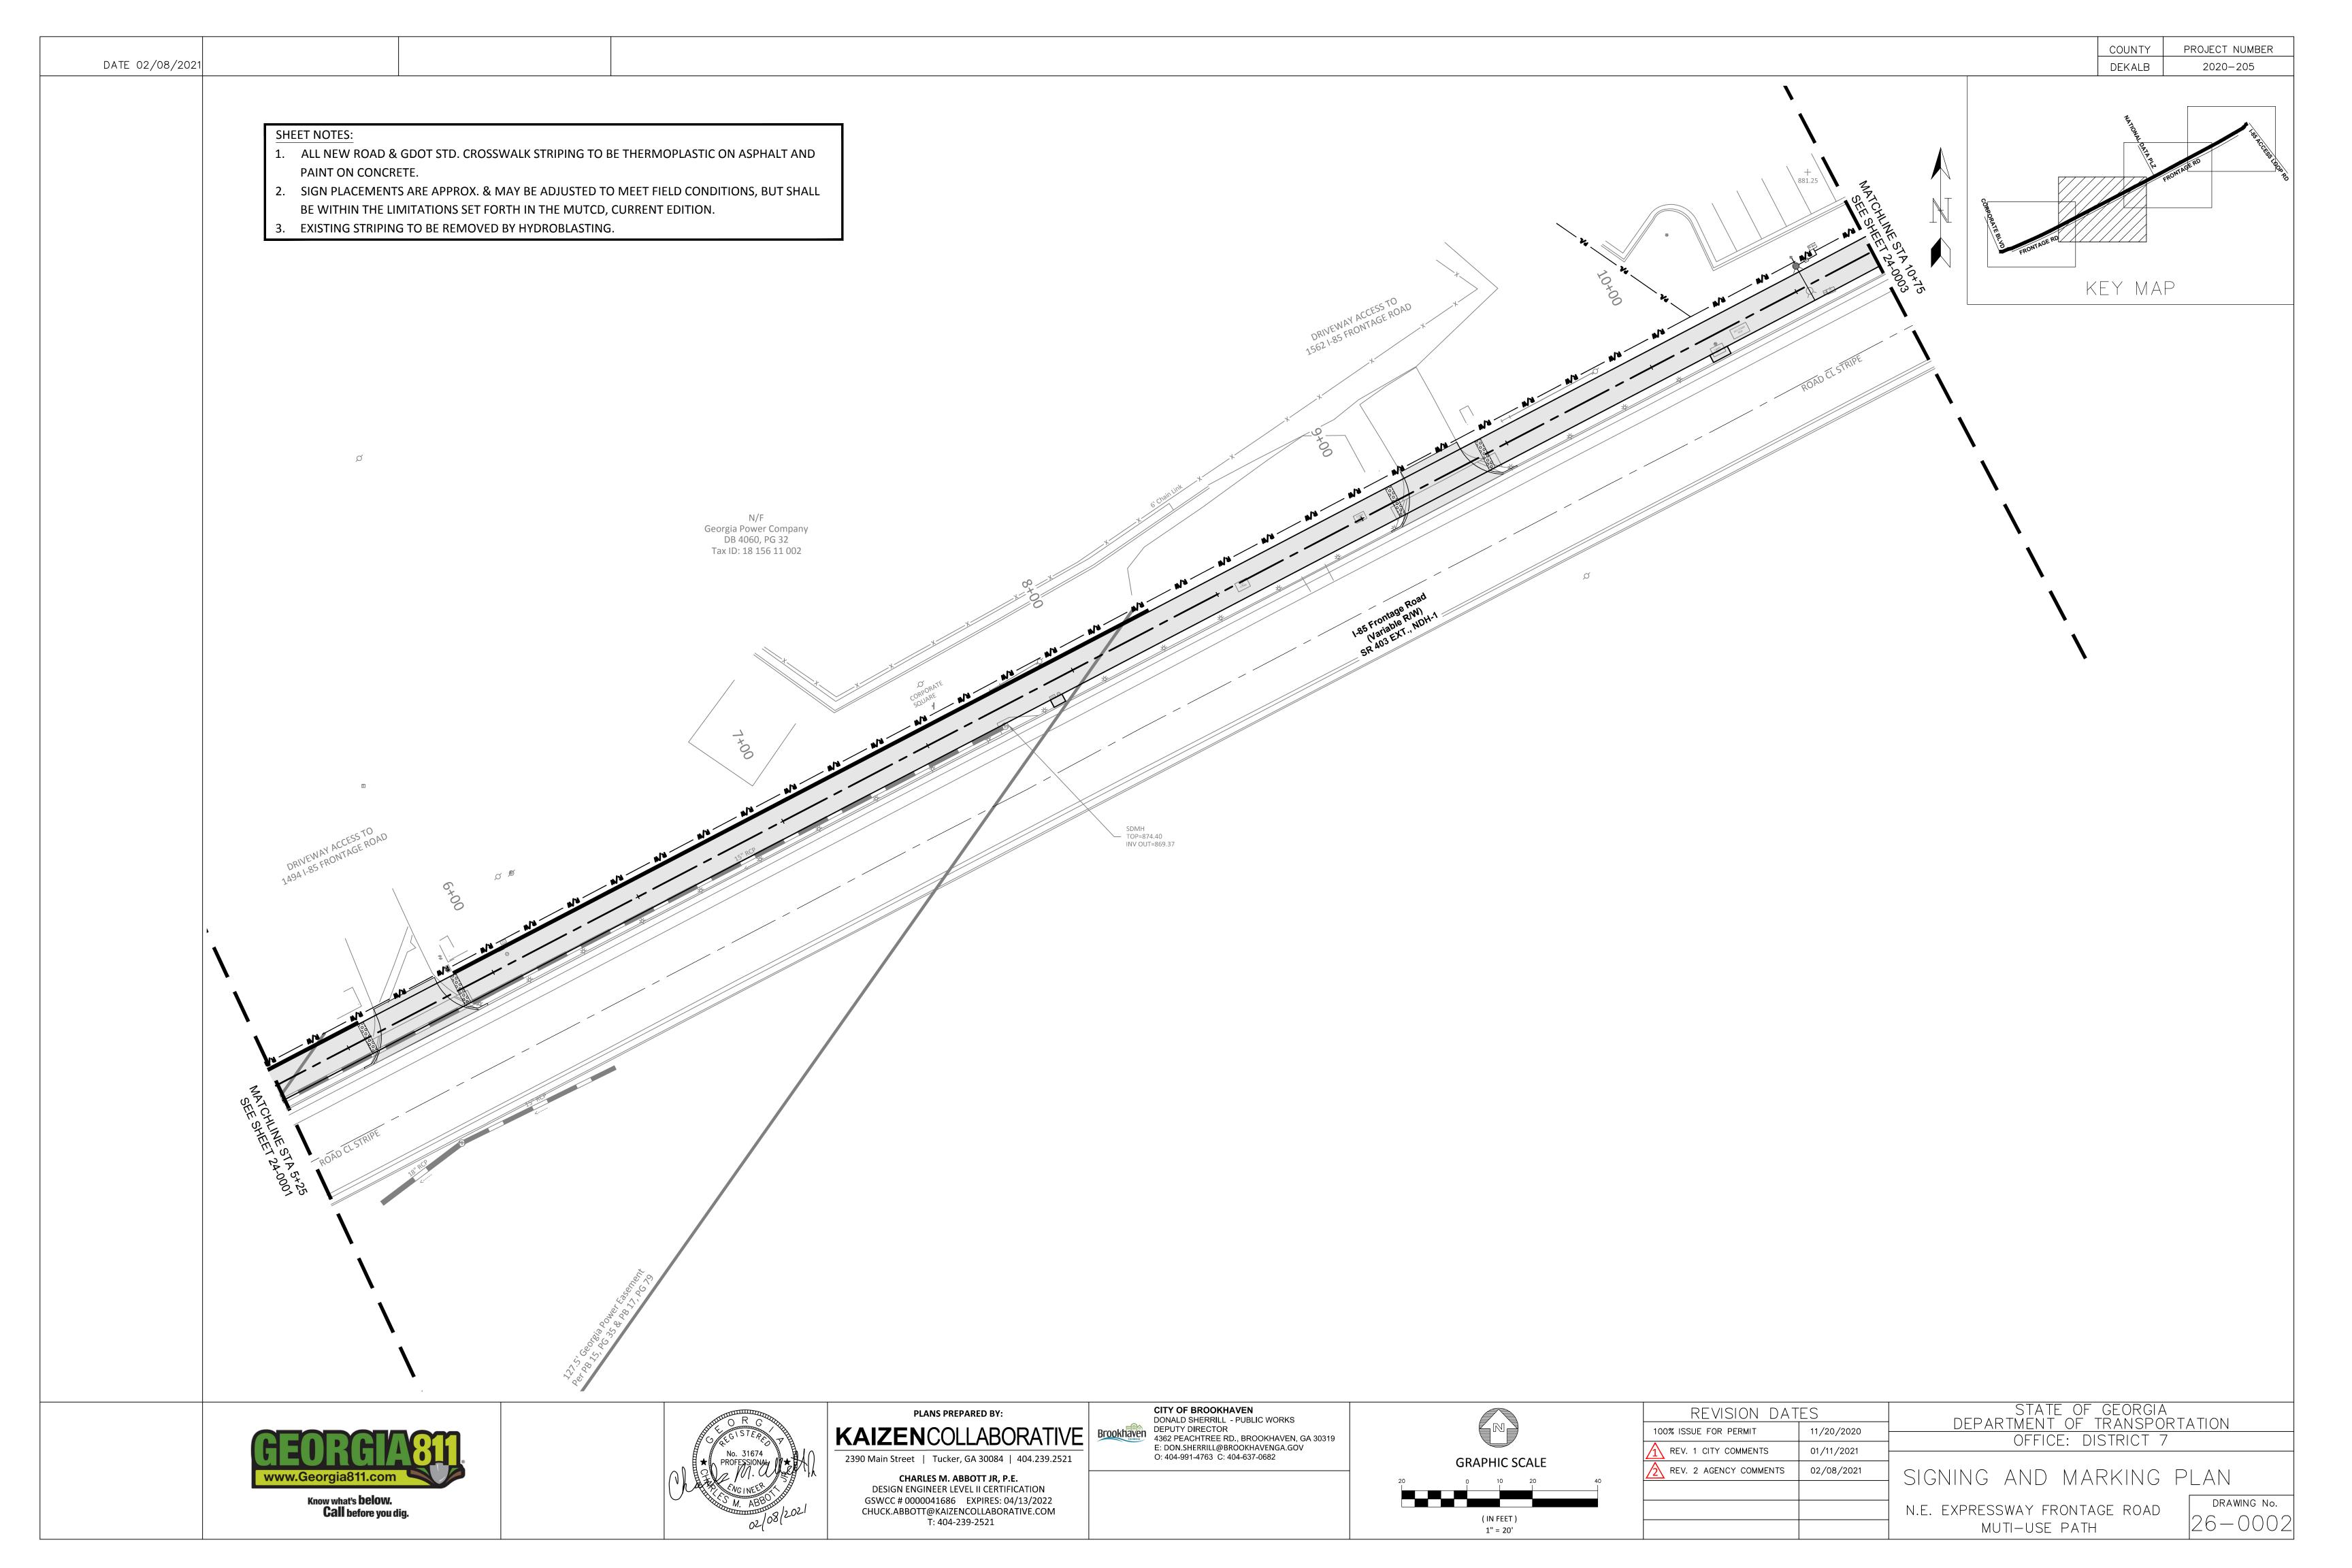

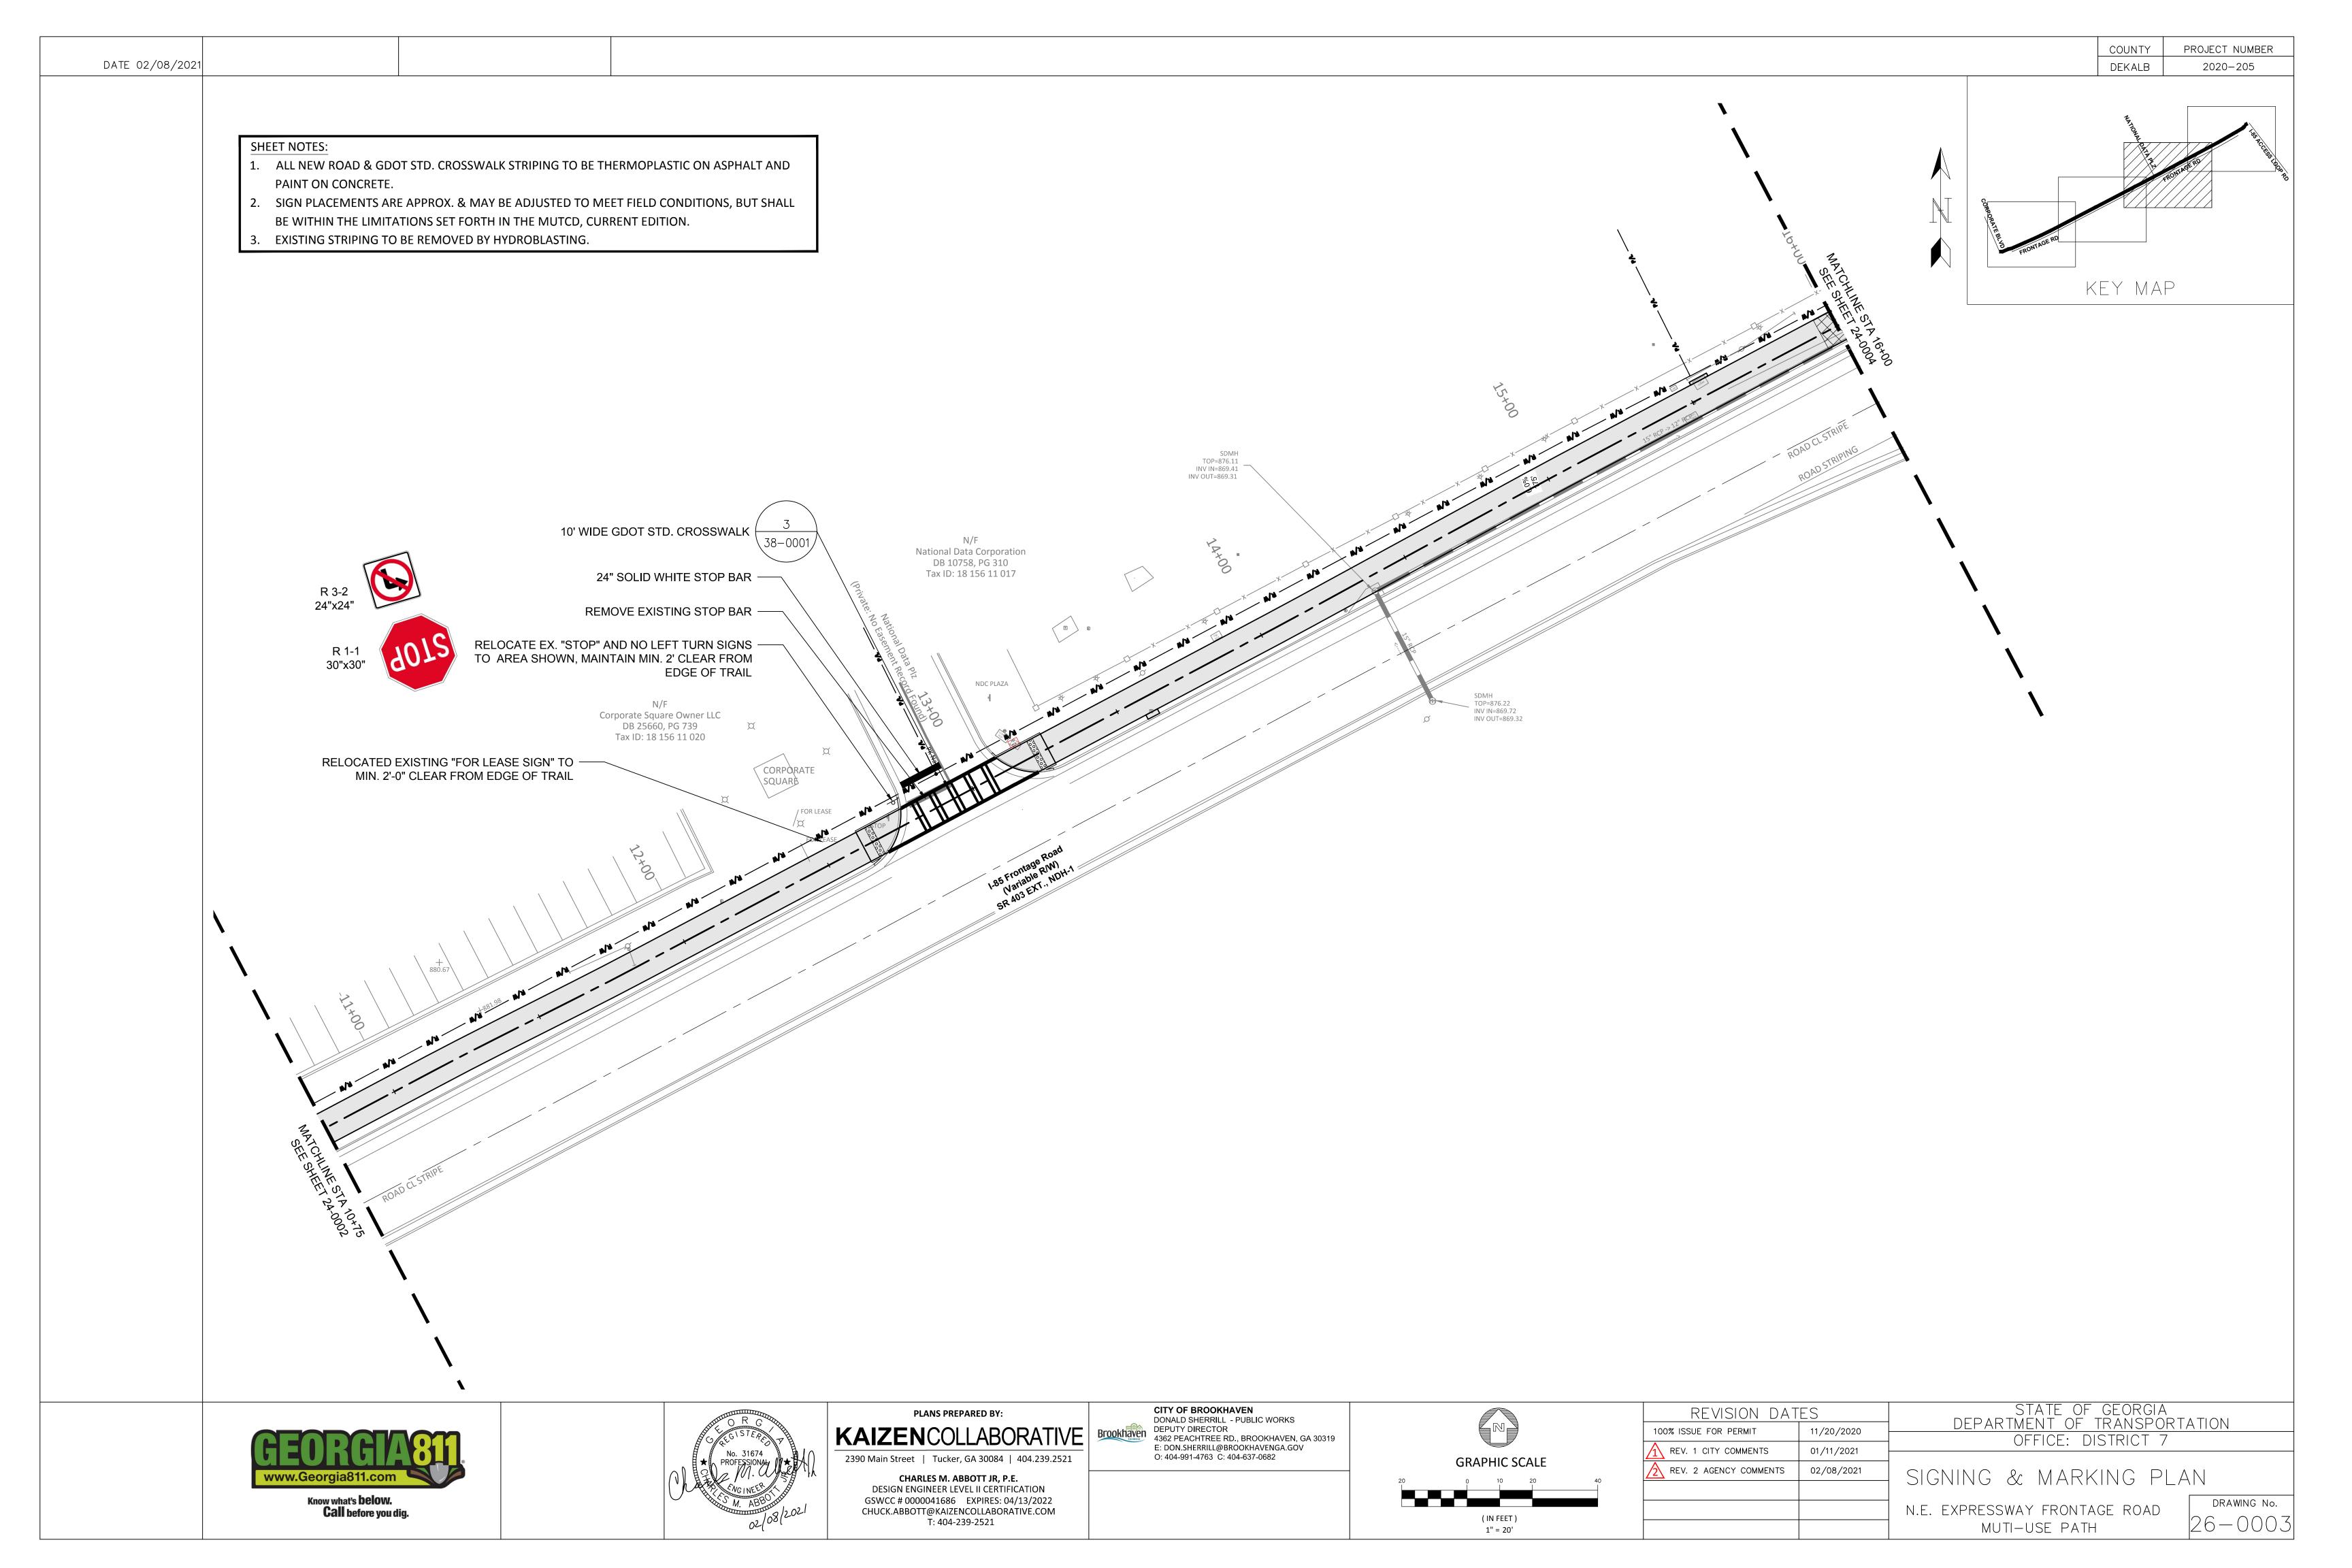

PROJECT NUMBER DEKALB

2020-205

GENERAL PLANTING NOTES

- 1. ALL PLANTS MUST BE HEALTHY, VIGOROUS MATERIAL, FREE OF PESTS & DISEASES.
- 2. ALL PLANTS MUST BE CONTAINER-GROWN, BALLED & BURLAPPED (B&B), OR OTHERWISE AS INDICATED IN THE PLANT LIST.
- 3. ALL TREES MUST BE STRAIGHT TRUNKED. FULL-HEADED & MEET ALL REQUIREMENTS SPECIFIED.
- 4. ALL PLANTS ARE SUBJECT TO THE APPROVAL OF THE LANDSCAPE ARCHITECT & THE OWNER BEFORE, DURING & AFTER INSTALLATION UNTIL THE DATE OF FINAL ACCEPTANCE.
- 5. ALL TREES OVER 8' HT MUST BE GUYED OR STAKED, UNLESS DETERMINED OTHERWISE BY OWNER. ARBORTIE, ARBORGUY, OR APPROVED EQUAL BLACK GUYING (POLYPROPYLENE MATERIAL) AND STAKING SYSTEM INSTALLED PER MANUFACTURER SPECIFICATIONS.
- 6. ALL PLANTS & PLANTING AREAS MUST BE COMPLETELY MULCHED AS PER SPECIFICATIONS. ALL PROPOSED TREES TO HAVE MINIMUM 6' DIAMETER MULCHED RING. ALL MULCH TO BE 3" SETTLED DEPTH OF CLEAN PINESTRAW, UNLESS INDICATED OTHERWISE.
- 7. PRIOR TO CONSTRUCTION, THE LANDSCAPE CONTRACTOR SHALL BE RESPONSIBLE FOR LOCATING ALL UNDERGROUND UTILITIES & SHALL AVOID DAMAGE TO ALL UTILITIES DURING THE COURSE OF THE WORK. THE LANDSCAPE CONTRACTOR IS RESPONSIBLE FOR REPAIRING ANY & ALL DAMAGE TO UTILITIES, STRUCTURES, SITE APPURTENANCES, ETC. WHICH OCCURS AS A RESULT OF THE LANDSCAPE CONSTRUCTION.
- 8. THE LANDSCAPE CONTRACTOR IS RESPONSIBLE FOR VERIFYING ALL QUANTITIES SHOWN ON THESE PLANS BEFORE PRICING THE WORK. PLANT SYMBOLS ON THE LANDSCAPE PLAN SUPERCEDE QUANTITIES SHOWN IN THE PLANT LIST. IN SIZE GRADING B&B TREES, CALIPER SHALL TAKE PRECEDENT OVER HEIGHT. IN SIZE GRADING MULTI-STEM TREES. HEIGHT SHALL TAKE PRECEDENCE OVER CALIPER. THE LANDSCAPE CONTRACTOR MUST CONTACT THE LANDSCAPE ARCHITECT IF THEY ENCOUNTER ON SITE, EXISTING CONDITIONS SIGNIFICANTLY DIFFERENT FROM THE PLAN.
- 9. THE LANDSCAPE CONTRACTOR IS RESPONSIBLE FOR MAINTAINING ALL PLANTING (INCLUDING, BUT NOT LIMITED TO: WATERING, SPRAYING, MULCHING, FERTILIZING, ETC.) OF PLANTING AREAS & LAWNS UNTIL THE WORK IS ACCEPTED IN TOTAL BY THE LANDSCAPE ARCHITECT & THE OWNER.
- 10. ANY PLANT MATERIAL WHICH DIES, TURNS BROWN OR DEFOLIATES (PRIOR TO FINAL ACCEPTANCE OF THE WORK) SHALL BE PROMPTLY REMOVED FROM THE SITE & REPLACED WITH MATERIAL OF THE SAME SPECIES, QUANTITY, SIZE AND MEETING ALL PLANT LIST SPECIFICATIONS.
- 11. THE LANDSCAPE CONTRACTOR SHALL COMPLETELY GUARANTEE ALL PLANT MATERIAL FOR A PERIOD OF ONE (1) YEAR BEGINNING AT THE DATE OF FINAL ACCEPTANCE. THE LANDSCAPE CONTRACTOR SHALL PROMPTLY MAKE ALL REPLACEMENTS BEFORE OR AT THE END OF THE GUARANTEE PERIOD (AS PER DIRECTION OF THE OWNER).
- 12. THE LANDSCAPE CONTRACTOR AGREES TO PERFORM ALL LANDSCAPE MAINTENANCE (INCLUDING WATERING) THROUGHOUT THE ONE YEAR GUARANTEE PERIOD UNLESS OTHERWISE DETERMINED.
- 13. AFTER BEING DUG AT THE NURSERY SOURCE, ALL TREES IN LEAF SHALL BE ACCLIMATED FOR TWO (2) WEEKS UNDER A MIST SYSTEM PRIOR TO INSTALLATION.
- 14. STANDARDS SET FORTH IN 'AMERICAN STANDARDS FOR NURSERY STOCK' REPRESENT GUIDELINE SPECIFICATIONS ONLY AND CONSTITUTE MINIMUM QUALITY REQUIREMENTS FOR PLANT MATERIAL. ALL PLANT MATERIAL SHALL BE GRADE 'A' OR BETTER.
- 15. ALL DISTURBED AREAS TO BE SODDED WITH BERMUDA UNLESS OTHERWISE NOTED. TEMPORARY GRASS TO BE A COMBINATION OF ANNUAL RYE AND FESCUE SEED. ALL SOD AREAS ARE TO BE FERTILIZED AND OVERSEEDED AT TIME OF INSTALLATION. ALL AREAS DESIGNATED FOR SOD MUST BE FINE GRADED. LEVEL ANY UNDULATIONS OR IRREGULARITIES, WHILE MAINTAINING POSITIVE DRAINAGE. HANDRAKE AND SMOOTH, REMOVING ALL ROCKS LARGER THAN 1" FROM THE SURFACE. USE METAL SCREEN OR WOODEN DRAG ON LARGER SURFACES. CONTACT THE LANDSCAPE ARCHITECT FOR AN INSPECTION OF THE FINE GRADED SURFACE, PRIOR TO ANY SOD INSTALLATION.
- 16. ALL BERMS ARE TO BE CONSTRUCTED OF CLEAN, FRIABLE, WELL DRAINED, TOPSOIL.
- 17. FOR ALL PROPOSED PLANTING AREA, LANDSCAPE CONTRACTOR TO REMOVE EXISTING VEGETATION, TILL AND ADD TOPSOIL AND FERTILIZER PRIOR TO INSTALLATION. CONTRACTOR SHALL REMOVE ALL PAVEMENT, GRAVEL SUB-BASE AND CONSTRUCTION DEBRIS. REMOVE COMPACTED SOIL. AND ADD 24" OF TOPSOIL: OR AMEND THE TOP 24" OF EXISTING SOIL TO MEET SPECIFICATIONS, UNLESS NOTED OTHERWISE.
- 18. THE CONTRACTOR SHALL BE RESPONSIBLE FOR THE COMPLETE REMOVAL OF ALL BINDING CORDS AND ROPES/STRAPPING FROM THE TRUNKS OF ALL SHADE AND ORNAMENTAL TREES IMMEDIATELY AFTER PLANTING. IDENTIFICATION TAGS AND RIBBONS SHALL BE REMOVED FROM ALL PLANT MATERIAL AT THE TIME OF PLANTING. TREE BASKETS SHALL BE CUT FROM THE TOP 1/4 OF THE ROOT BALL PRIOR TO PLANTING.
- 19. ALL AREAS DISTURBED BY CONSTRUCTION ARE TO BE RE-SET TO FINAL GRADE AND VEGETATED PER CONSTRUCTION PLANS.
- 20. UNLESS OTHERWISE NOTED BY THE LANDSCAPE ARCHITECT, MEDIUM SPREADING SHRUBS SHALL BE PLANTED NO CLOSER THAN 30" TO ANY ADJOINING WALL OR PAVED AREA. LARGE SPREADING SHRUBS SHALL BE PLANTED NO CLOSER THAN 36" TO ANY ADJOINING WALL OR PAVED AREA.
- 21. THE PLANTING SOIL FOR SHRUBS WILL CONSIST OF 33% GROUND PINE BARK HUMUS, WELL-MIXED WITH 67% OF IMPROVED SOIL; WHICH IS, EXCAVATED SOIL WITH ROCKS, CLUMPS, AND DEBRIS GREATER THAN 2" IN DIAMETER REMOVED. NO ADDITIONAL SOIL AMMENDMENTS ARE REQUIRED FOR TREES. GROUNDCOVER AND PERENNIAL BEDS SHALL BE PREPARED AND AMENDED ACCORDING TO SPECIFICATIONS.
- 22. MINIMUM (9) SQ. FT. PLANTING AREA PROVIDED FOR EACH TREE.
- 23. SEEDING RATE FOR BERMUDA SEED ON DISTURBED AREAS IS 1.5 LBS PER 1000 SQUARE FEET.
- 24. ALL PARKING ISLANDS AND LANDSCAPE BEDS ARE REQUIRED TO HAVE A GRANULAR PRE-EMERGENT HERBICIDE APPLIED TO AID WITH WEED CONTROL.

BUILDERS NOTES:

BY THIS AGREEMENT WITH THE OWNER, THE LANDSCAPE ARCHITECT HAS UNDERTAKEN A LIMITED SCOPE OF PROFESSIONAL SERVICES. THE CONSTRUCTION DOCUMENTS PROVIDED BY THE LIMITED SERVICES SHALL BE TERMED "BUILDERS PLANS" IN RECOGNITION OF THE SOPHISTICATION OF THE LANDSCAPE CONTRACTOR. CONSTRUCTION WILL REQUIRE THAT THE LANDSCAPE CONTRATOR ADAPT THE "BUILDER'S PLANS" TO THE FIELD CONDITIONS ENCOUNTERED AND MAKE LOGICAL ADJUSTMENTS IN FIT, FORM, DIMENSIONS AND QUANTITY THAT ARE TREATED ONLY GENERALLY BY THE "BUILDERS PLANS." IN THE EVENT THAT CLARIFICATION IS NEEDED FOR ANY DRAWING CONTAINED IN THIS SET, IT SHALL BE RESPONSIBILITY OF THE LANDSCAPE CONTRACTOR TO BRING IT TO THE ATTENTION OF THE LANDSCAPE ARCHITECT. THE GENERAL CONTRACTOR AND HIS/HER SUBCONTRACTORS SHALL CONSTRUCT THIS PROJECT IN COMPLIANCE WITH ANY AND ALL APPLICABLE CODES.

PLANT SCHEDULE:

KEY	QTY	BOTANICAL NAME	COMMON NAME	SIZE	SPACING	REMARKS
		SHRUBS & GROUNDCOVERS				
Csg	12	Camellia Sasanqua 'Green 99-006'	October Magic Bride Camellia	5 gal.	As shown	Full, vigorous.
Pvd	24	Panicum Virgatum 'Dallas Blues'	Dallas Blues Switch Grass	5 gal.	As shown	Full, vigorous.
Тос	60	Thuja occidentalis 'Congabe'	Dwarf Arborvitae 'Fire Chief'	3 gal.	As shown	Full, vigorous.
SOD	9350 sf.	Sod *see note				Weed free sod as indicated & seed all other disturbed areas

GDOT TREE REPLACEMENT NOTES PER POLICY 6755-9:

Note: Contractor to coordinate with City of Brookhaven on sod variety prior to installation

8.2 - REQUIREMENTS

- MITIGATION IS NOT REQUIRED FOR:
 - 1. REMOVAL OF INVASIVE PLANT SPECIES
 - 2. VINES, SHRUBS, & COLONIZING SEEDLING TREES REMOVED WITHIN (2) FEET OF LIMITED ACCESS FENCE
 - 3. TREES REMOVED FROM THE CLEAR ZONE
 - 4. DRIVEWAY CONSTRUCTION THAT DOES NOT RESULT IN REMOVAL OF ANY TREES (4) INCHES IN DIAMETER OR GREATER

8.3 - RESTRICTIONS

NO TREE REMOVAL, PRUNING, OR GROUND DISTURBANCE SHALL TAKE PLACE WITHIN ANY STREAM BUFFER


8.5 - REPLACEMENT PLANTING REQUIREMENTS FOR MITIGATION

WHEN LANDSCAPE ENHANCEMENT REPLACEMENT PLANTS ARE REQUIRED:

- 1. PROVIDE A LANDSCAPE DESIGN PROPOSAL FOR REPLACEMENT PLANTS AT A RATIO OF ONE-HALF (1/2) OF THE TOTAL CALIPER INCHES OF TREES REMOVED AND ONE-FOURTH (1/4) OF THE TOTAL SQUARE FEET OF EXISTING NATIVE UNDERSTORY **VEGETATION REMOVED.**
- 2. THIRTY PERCENT (30%) OF THE REPLACEMENT SHRUBS AND SEVENTY-FIVE PERCENT (75%) OF REPLACEMENT TREES SHALL BE NATIVE SPECIES OR CULTIVARS OF NATIVE SPECIES.
- 3. SEVENTY-FIVE PERCENT (75%) OF ALL PROPOSED TREES SHALL BE LARGE CANOPY, HARDWOOD SHADE TREES. 4. GRASS ALL DISTURBED AREAS NOT PLANTED IN TREES AND SHRUBS ACCORDING TO GDOT SPECIFICATIONS.
- IF THE DEPARTMENT DETERMINES THAT LANDSCAPE MITIGATION CANNOT BE REASONABLY ACCOMMODATED, THEN THE
- REMAINDER OF THE MITIGATION SHALL BE FEES ACCORDING TO SECTION 16-2 EXCESS CLEARING FEES.

16.2 - EXCESS CLEARING FEES

A CONTRIBUTORY VALUE FEE IS ASSESSED TO COMPENSATE FOR ANY REMAINING REPLACEMENT PLANTS TO COMPLETE THE MITIGATION FOR ADDITIONAL GRADING OR CLEARING ACTIVITIES BEYOND WHAT IS NECESSARY FOR DRIVEWAY ACCESS CONSTRUCTION WHERE THE DEPARTMENT DETERMINES THAT THE REQUIRED LANDSCAPE REPLACEMENT PLANTS CANNOT REASONABLY BE INSTALLED TO COMPENSATE FOR THE TOTAL AMOUNT OF LOST VEGETATION. THE CORRESPONDING CONTRIBUTORY VALUE FEES IN THIS CASE CAN BE CALCULATED MY MULTIPLYING THE REMAINING CALIPER INCHES THAT CANNOT BE REPLACED ON THE SITE BY SEVEN DOLLARS (\$7.00).

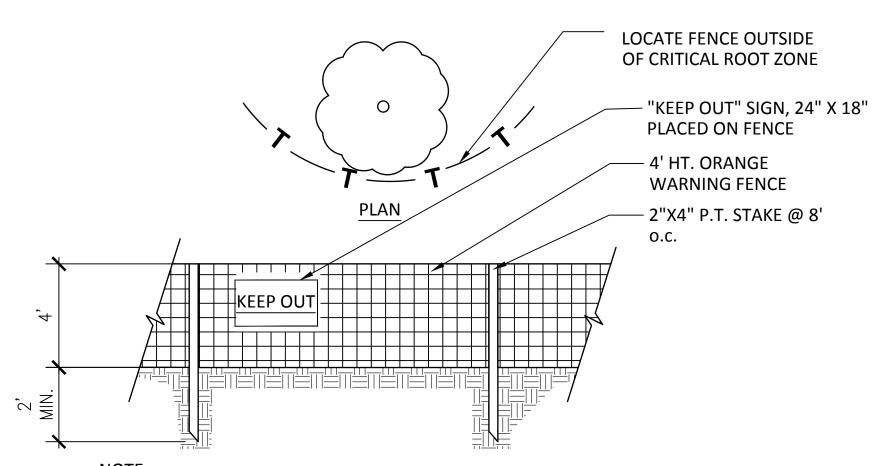

NOTE:


PROVIDE FENCE AS SHOWN ON PLAN ALONG LIMITS OF CONSTRUCTION AT EDGE OF IMPACT TO CRITICAL ROOT ZONE. PROVIDE AT LEAST ONE FOOT OF DISTANCE FROM TREE TO FENCE FOR EACH INCH OF TREE DBH, WHERE DBH REFERS TO THE TREE DIAMETER MEASURED AT 4.5' ABOVE THE GROUND. STAKE ONE LAYER OF HAY BALES IN FRONT OF FENCE (HAY BALE NOT SHOWN ON DETAIL)

TREE PROTECTION FENCE DETAIL NOT TO SCALE

NOTE:

FOR CONTAINER GROWN SHRUBS CUT BOUND ROOTS VERTICALY 3 TIMES TO PROMOTE PROPER ROOT GROWTH


KEY MAP

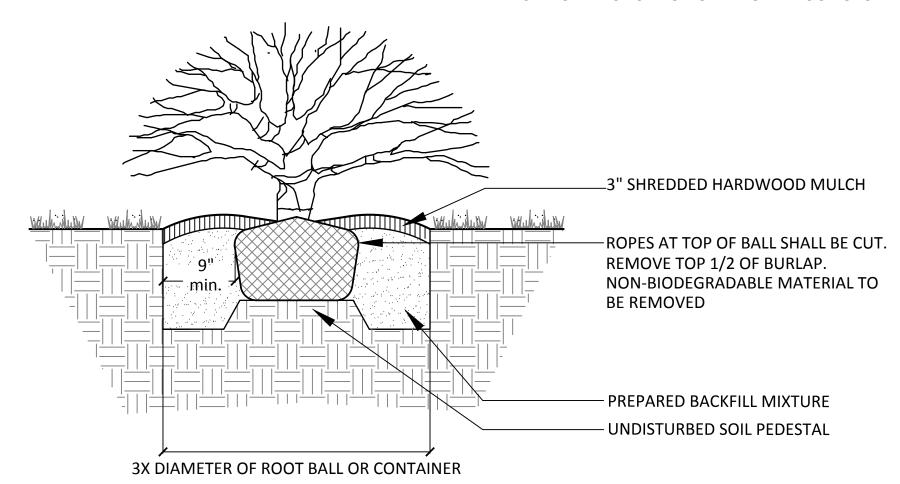

29-0000

SHRUB PLANTING DETAIL


SCALE: 1" = 1'-0"

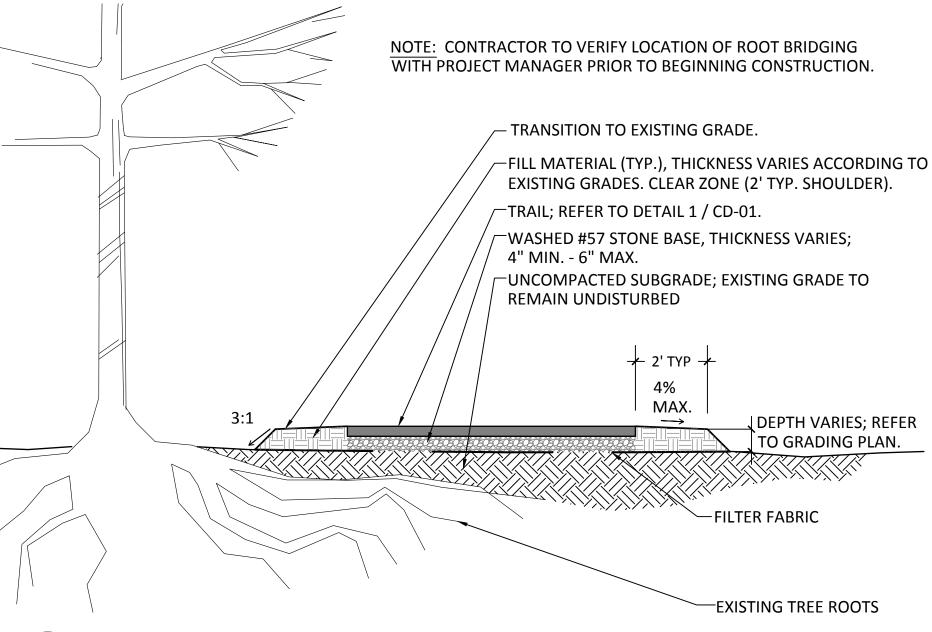

ROOT BRIDGING

SCALE: 1/4" = 1'-0"



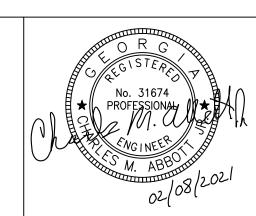



PLANS PREPARED BY: KAIZENCOLLABORATIVE 2390 Main Street | Tucker, GA 30084 | 404.239.2521


CHARLES M. ABBOTT JR. P.E. DESIGN ENGINEER LEVEL II CERTIFICATION GSWCC # 0000041686 EXPIRES: 04/13/2022 CHUCK.ABBOTT@KAIZENCOLLABORATIVE.COM T: 404-239-2521


CITY OF BROOKHAVEN DONALD SHERRILL - PUBLIC WORKS DEPUTY DIRECTOR 4362 PEACHTREE RD., BROOKHAVEN, GA 30319 E: DON.SHERRILL@BROOKHAVENGA.GOV O: 404-991-4763 C: 404-637-0682

STATE OF GEORGIA REVISION DATES DEPARTMENT OF TRANSPORTATION 100% ISSUE FOR PERMIT 11/20/2020 OFFICE: DISTRICT 7 REV. 1 CITY COMMENTS 01/11/2021 LANDSCAPE NOTES, DETAILS & REV. 2 AGENCY COMMENTS 02/08/2021 PLANT SCHEDULE DRAWING No. N.E. EXPRESSWAY FRONTAGE ROAD 29-0000 MUTI-USE PATH

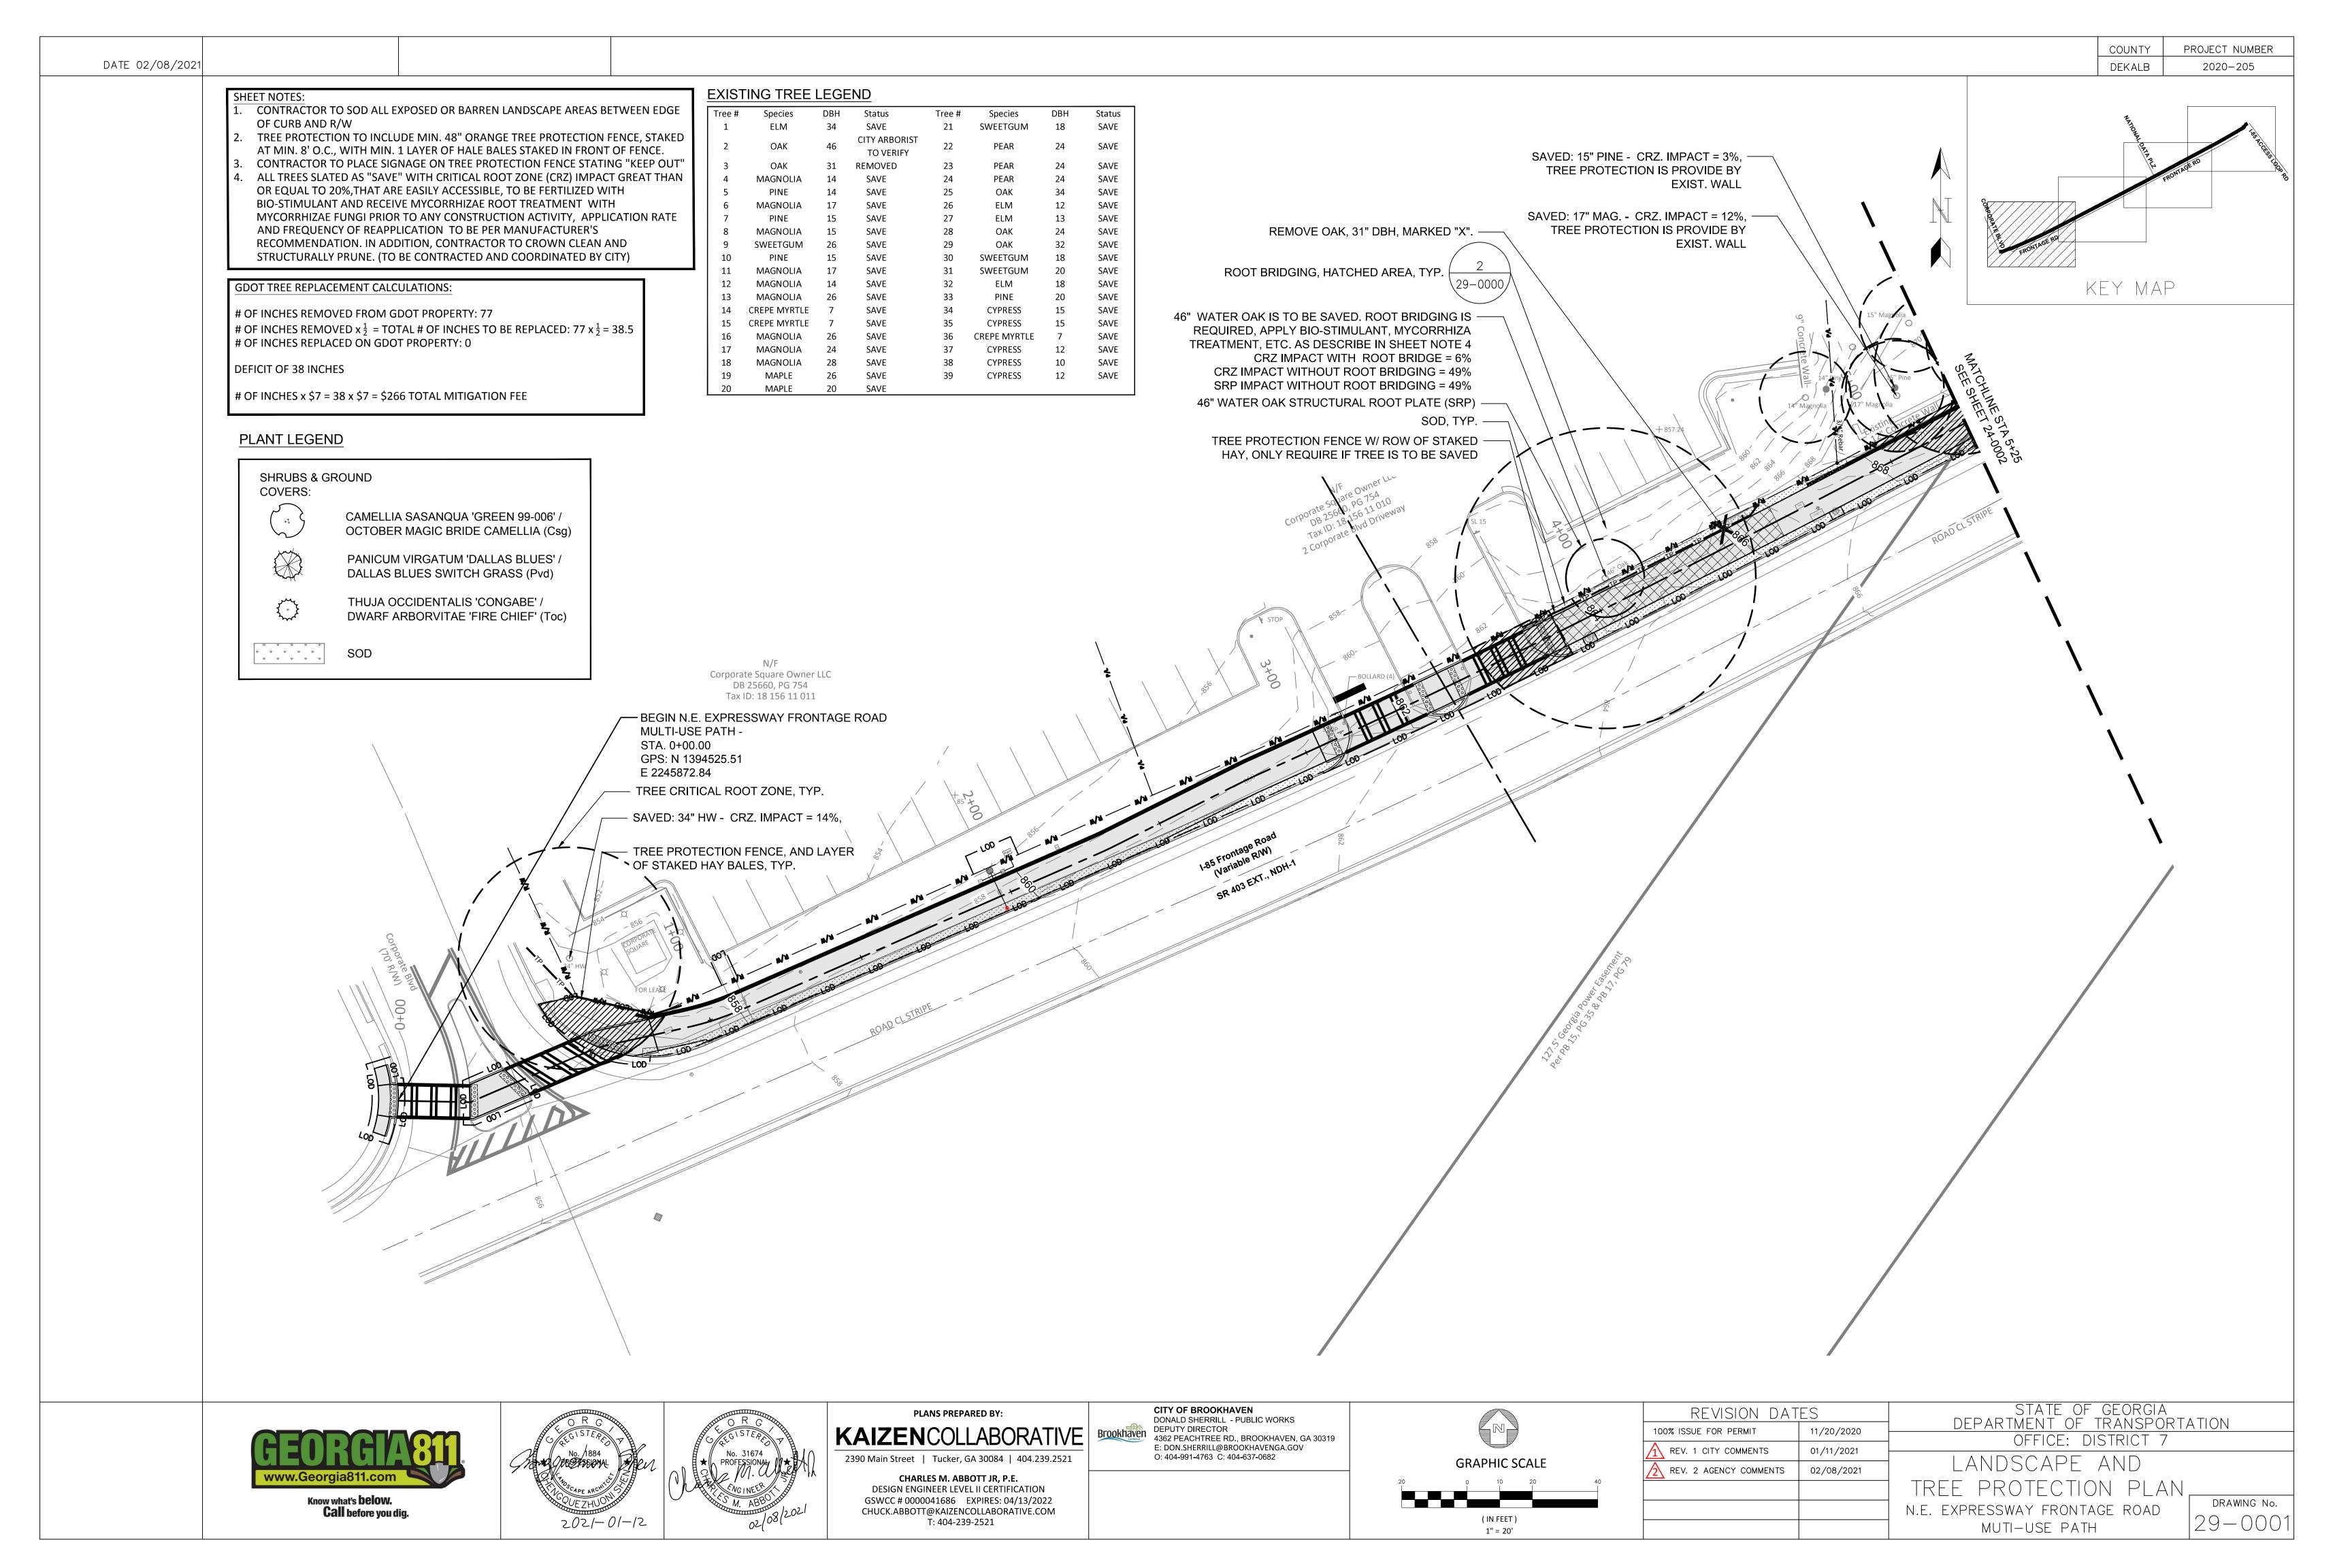

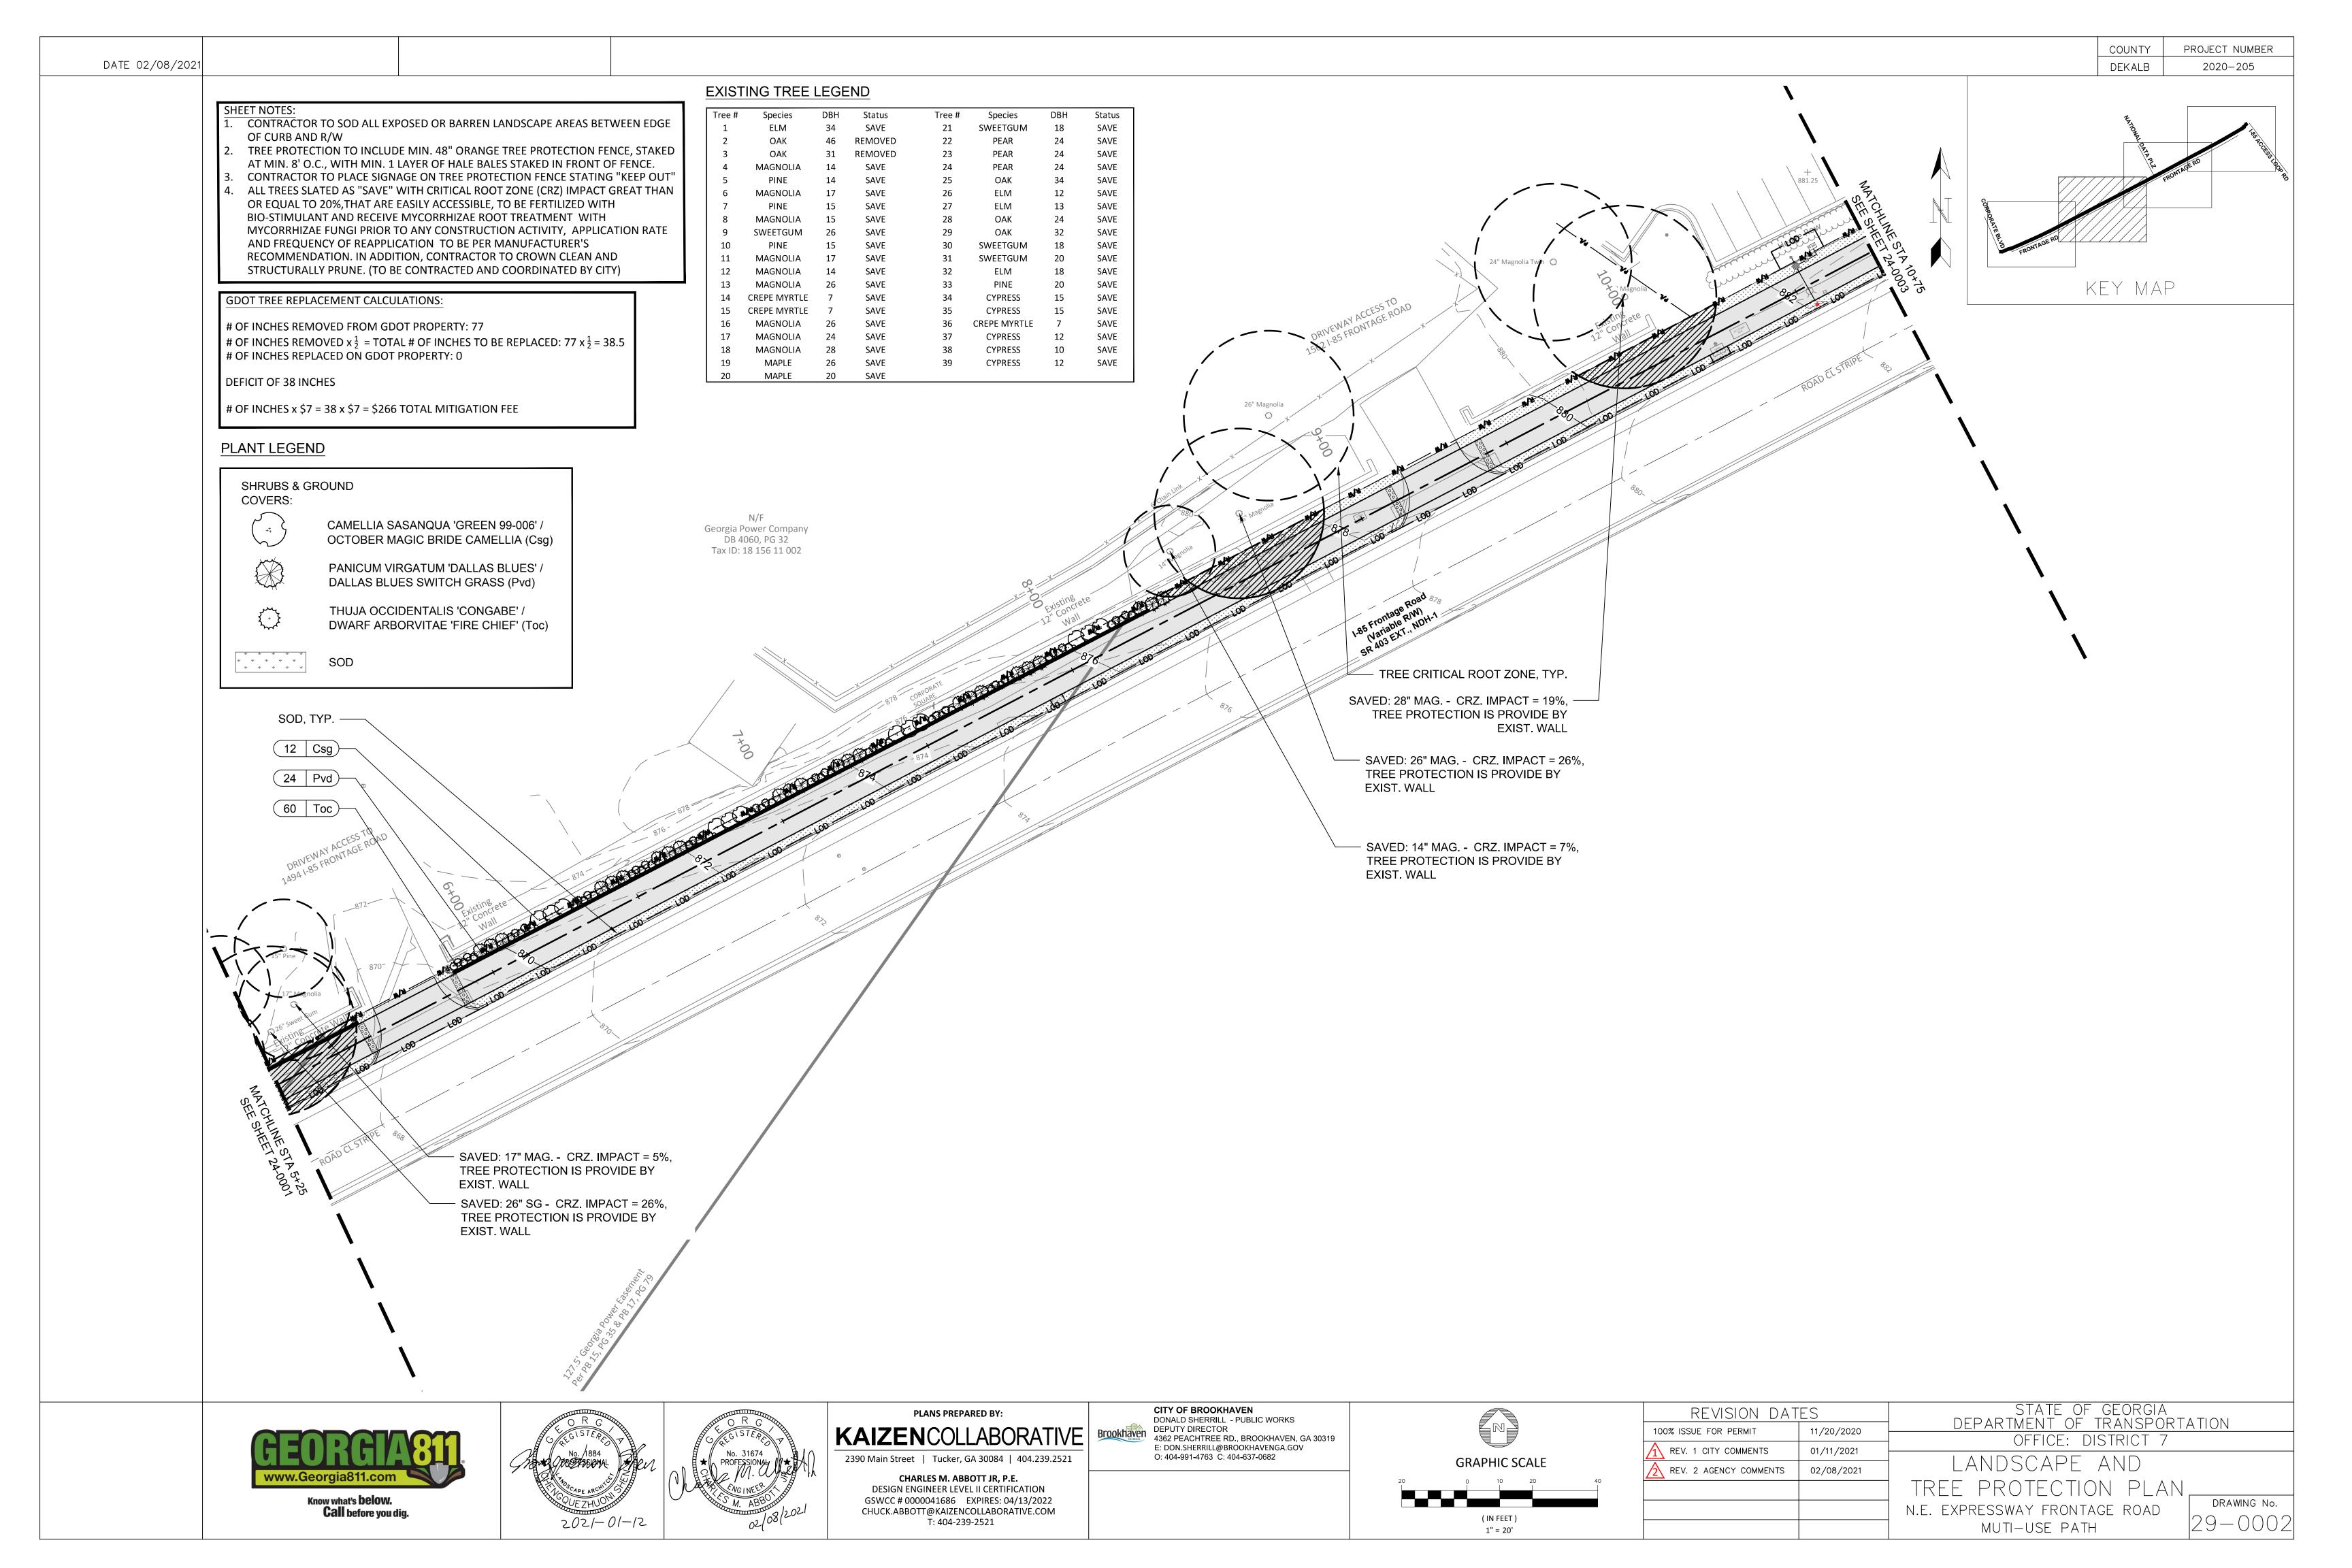

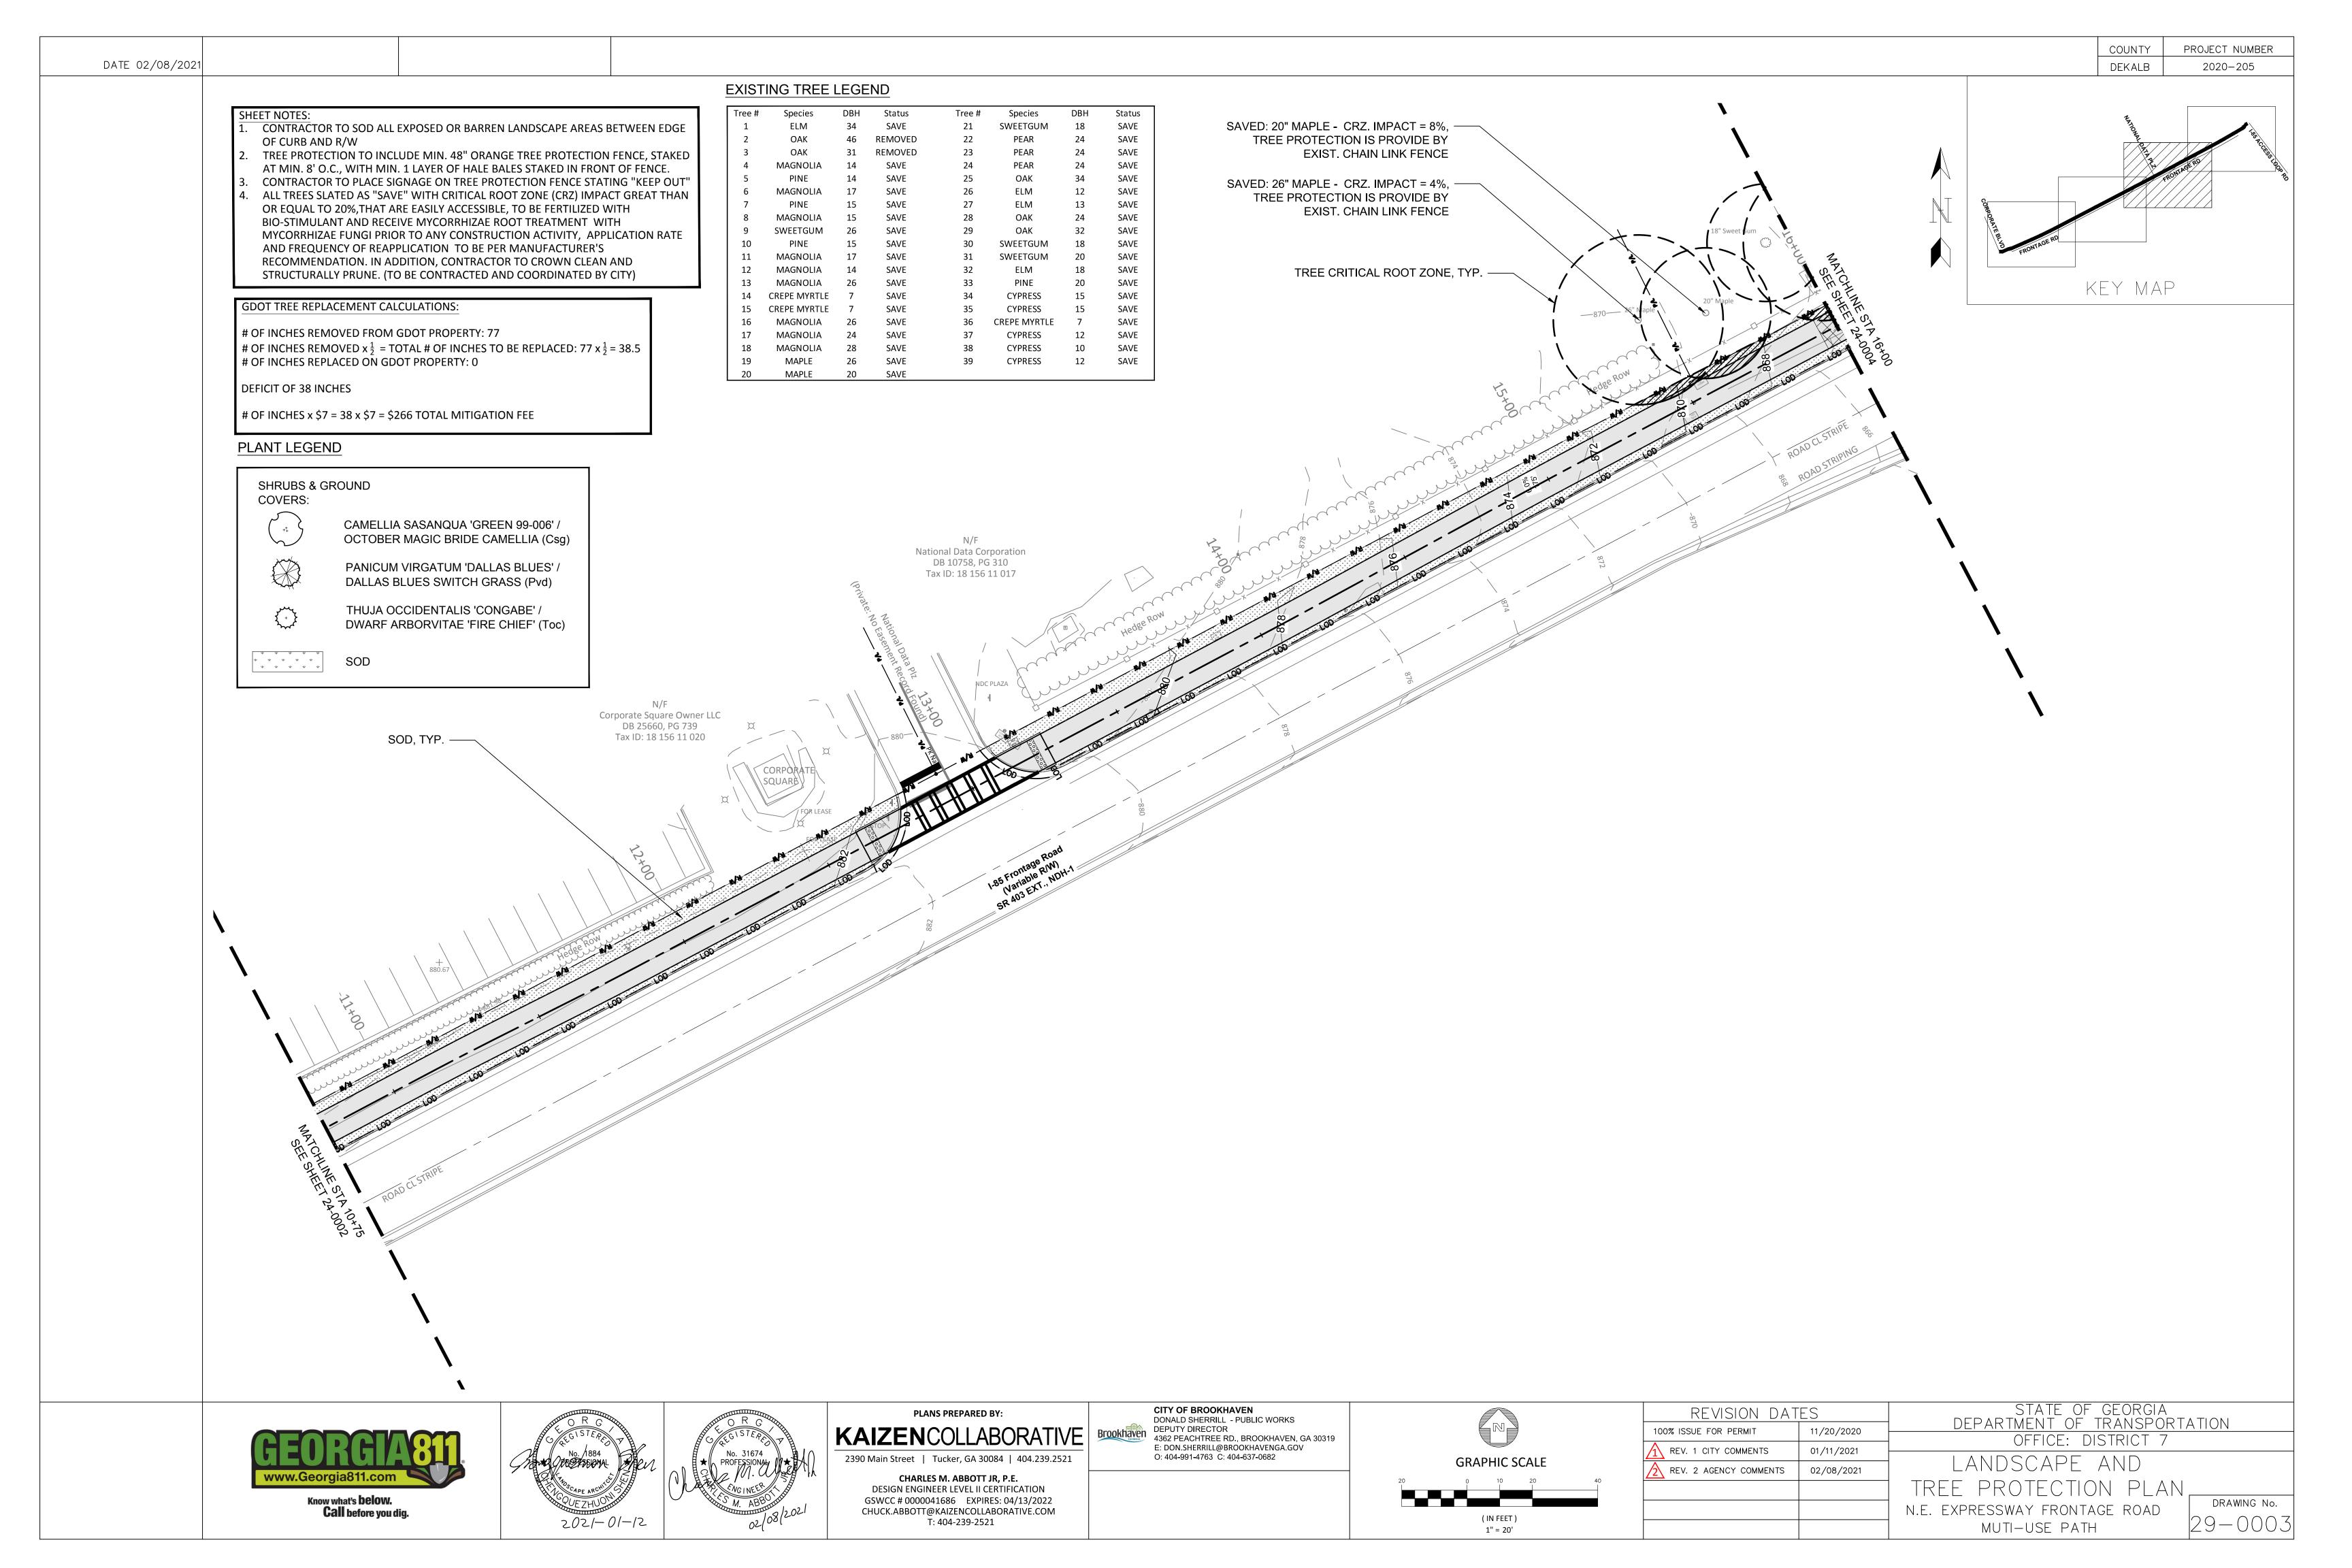

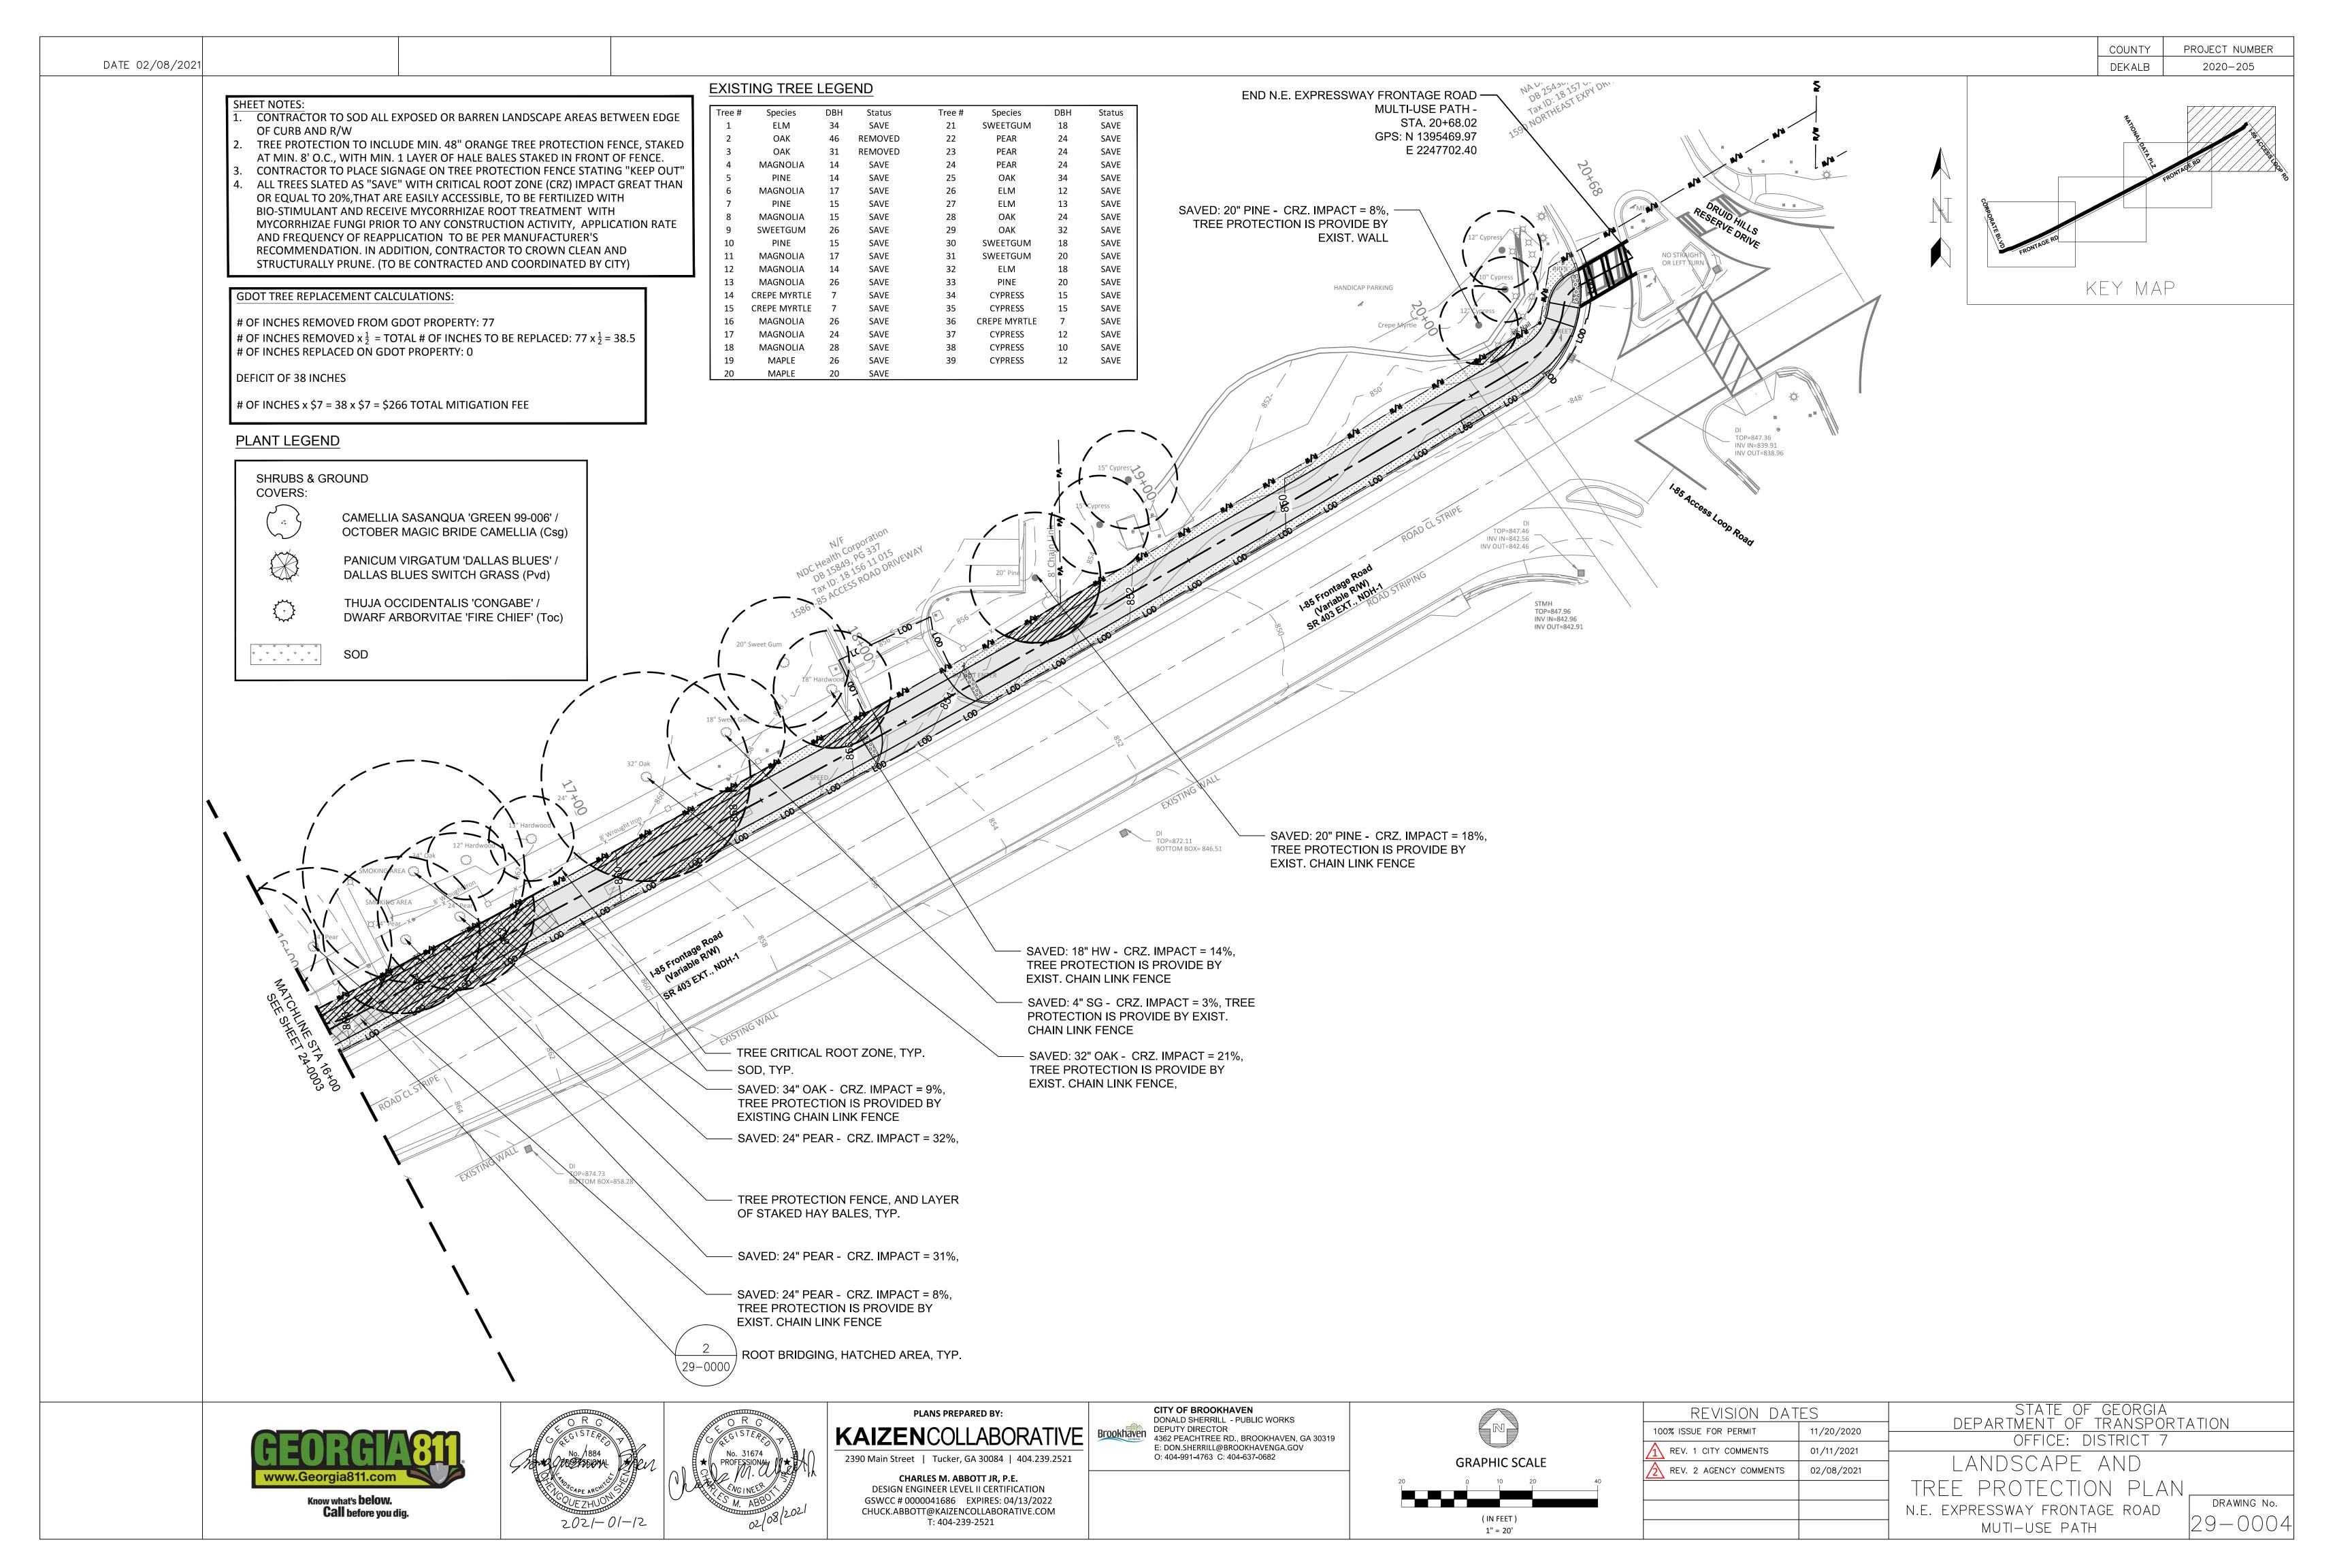

- THE GENERAL CONTRACTOR SHALL COORDINATE STRUCTURAL DRAWINGS WITH CIVIL AND LANDSCAPE ARCHITECT DRAWINGS, AND PROMPTLY NOTIFY THE ARCHITECT/ENGINEERS OF ANY DISCREPANCIES OR OMISSIONS.
- 2. THE GENERAL CONTRACTOR SHALL VERIFY ALL DIMENSIONS AND EXISTING SITE CONDITIONS PRIOR TO COMMENCING WORK. PROMPTLY NOTIFY THE ARCHITECT/ENGINEER OF ANY DISCREPANCIES BETWEEN ACTUAL SITE CONDITIONS AND THE CONTRACT DOCUMENTS.
- 3. DO NOT SCALE DRAWINGS. ALL WORK REQUIRING MEASURING SHALL BE DONE ACCORDING TO FIGURES ON DRAWING. ANY MISSING DIMENSIONS WILL BE FURNISHED UPON REQUEST.
- 4. WHERE A DETAIL IS SHOWN FOR ONE CONDITION, IT SHALL ALSO APPLY FOR ALL LIKE OR SIMILAR CONDITIONS UNLESS NOTED OTHERWISE.
- 5. THE STRUCTURE IS DESIGNED TO BE SELF-SUPPORTING AND STABLE AFTER FULLY COMPLETED. THE ERECTION PROCEDURE AND SEQUENCE INCLUDING THE DESIGN ADEQUACY AND SAFETY OF ERECTION BRACING, SHORING, RE-SHORING, TEMPORARY SUPPORTS, ETC., ARE THE SOLE RESPONSIBILITY OF THE CONTRACTOR.
- THESE GENERAL NOTES APPLY WHERE OTHER PROVISIONS ARE NOT PROVIDED BY THE DRAWINGS, SPECIFICATIONS OR TYPICAL DETAILS. IN CASE OF SPECIAL CONDITIONS INDICATED ON DRAWINGS, THE DRAWINGS SHALL GOVERN OVER THE SPECIFICATIONS.
- CONSTRUCTION SHALL BE IN ACCORDANCE WITH FEDERAL, STATE, AND LOCAL ORDINANCES. DESIGN OF STRUCTURES IN ACCORDANCE WITH AASHTO LRFD 7TH EDITION (2014), AND THE ACI318-14 FOR DESIGN OF CONCRETE ELEMENTS.

FOUNDATION:

- 1. FOUNDATIONS ARE DESIGNED FOR AN ALLOWABLE SOIL BEARING PRESSURE OF 2000 PSF. DESIGN SOIL BEARING PRESSURES ARE INDICATED ON THE SITE PLANS AND DETAILS. THESE VALUES SHALL BE FIELD VERIFIED AT EACH EXCAVATION PRIOR TO FOUNDATION CONSTRUCTION. NOTIFY STABILITY ENGINEERING IF FIELD CONDITIONS VARY BY MORE THAN 10% FROM DESIGN VALUES. ALL FOOTINGS ARE TO BE PLACED ON UNDISTURBED SOIL OR COMPACTED FILL.
- 2. ALL BACKFILLING SHALL BE ACCOMPLISHED USING MATERIAL CONSISTING OF CRUSHED STONE AND/OR MATERIAL APPROVED BY A REGISTERED SOILS ENGINEER. FILL MATERIAL TAKEN FROM SITE EXCAVATION SHALL HAVE OPTIMUM MOISTURE CONTENT FOR COMPACTION AND BE FREE OF ANY DEBRIS. BACKFILL SHALL BE COMPACTED TO 95% MAXIMUM DENSITY AS DETERMINED BY ASTM D698, IN MAXIMUM LIFTS OF EIGHT INCHES. NO BACKFILL MATERIAL SHALL BE PLACED AGAINST WALLS WITHOUT PROVISIONS FOR ADEQUATE BRACING OF THESE WALLS.
- 3. ALL SOIL CONDITIONS ARE SUBJECT TO EVALUATION BY A SOILS ENGINEER PRIOR TO FOUNDATION CONSTRUCTION. SOILS WITHOUT ADEQUATE CAPACITY TO SUPPORT DESIGN LOADS MUST BE REPLACED OR MODIFIED PRIOR TO PROCEEDING WITH CONSTRUCTION.
- 4. ALL WIRE MESH AND REBARS ARE TO BE PLACED ON SUPPORTS PER ACI STANDARDS PRIOR TO POURING CONCRETE.
- 5. SEE LANDSCAPE ARCHITECT DRAWINGS FOR CONCRETE FINISHING REQUIREMENTS NO SPECIFIED HEREIN.
- 6. ALL CONCRETE RETAINING WALLS SHALL BE CURED AT LEAST SEVEN DAYS PRIOR TO BACKFILLING IN ACCORDANCE WITH APPLICABLE CODES.

HAND RAIL DETAILS:

- 1. REFER TO "STREETSCAPE DESIGN STANDARDS" BY THE CITY OF BROOKHAVEN FOR HANDRAIL DETAILS.
- 2. FABRICATOR TO COORDINATE FINISHES AND COATINGS WITH PROJECT MANAGER AND/OR CITY OF BROKHAVEN PRIOR TO FABRICATION.

<u>REINFORCING</u>:

- 1. CONCRETE REINFORCING STEEL SHALL COMPLY WITH THE REQUIREMENTS OF ASTM A615, GRADE 40 FOR #3 BARS AND ASTM A615, GRADE 60 FOR #4 AND LARGER BARS. WELDED WIRE MESH SHALL COMPLY WITH THE REQUIREMENTS OF ASTM A185.
- 2. DETAILING OF CONCRETE REINFORCEMENT AND ACCESSORIES SHALL BE IN ACCORDANCE WITH ACI 315, LATEST EDITION.
- 3. REINFORCING STEEL SHALL BE SPLICED ONLY AS INDICATED ON THE PLANS. WHEN SPLICE LENGTHS ARE NOT GIVEN ON THE PLANS, THEY SHALL BE TAKEN FROM THE TABLE BELOW. USE "CLASS B" LAPS UNLESS THE PLANS INDICATE "CLASS A".

BAR	SIZE	CLASS	" B"	<u>SPLICE</u>	CLASS	"A"	SPLI
#3	•••••		28"			22"	
#4			37"			29"	
#5	•••••		47"		•••••	36"	
#6			56"			43"	
#7			81"		•••••	63"	
#8			93"			72"	

LAPS SHOWN ABOVE WERE CALCULATED PER ACI 318-11, EQ. 12-1 FOR MATS, WALLS, BEAMS, COLUMNS AND SLABS. VALUES ASSUMED ARE: f'c 3000 PSI, Ktr=0, 1" MIN COVER AND 2" MIN CLEAR BETWEEN BARS FOR #4. #5 AND #6 BARS, AND 1½" MIN COVER AND 3" MIN CLEAR BETWEEN BARS FOR #7 THRU #11 BARS. SHORTER LAPS MAY BE CALCULATED FOR SOME SPECIFIC CONDITIONS SUCH AS TIED BEAMS OR ADDITIONAL COVER. LAPS MUST BE INCREASED 50% PER ACI 318-11 FOR EPOXY COATED REBAR, OR 30% FOR LIGHTWEIGHT CONCRETE.

- 4. LAPS IN W.W.F. SHOULD BE ONE MESH PLUS TWO INCHES AT
- 5. ALL BAR HOOKS SHALL BE STANDARD 90-DEGREE HOOKS UNLESS NOTED OTHERWISE ON THE DRAWINGS.
- 6. SEE SECTION 7.7 OF ACI 318-11 FOR CONDITIONS NOT NOTED.
- 7. DESIGN OF STRUCTURAL CONCRETE ELEMENTS IS IN ACCORDANCE WITH ACI 318.

CONCRETE:

- 1. CONCRETE WORK SHALL CONFORM TO ALL REQUIREMENTS OF ACI 301, "SPECIFICATION FOR STRUCTURAL CONCRETE", EXCEPT AS NOTIFIED BY THE REQUIREMENTS OF THESE STRUCTURAL DRAWINGS.
- 2. CONCRETE SHALL BE NORMAL WEIGHT AND HAVE A DESIGNATED COMPRESSIVE STRENGTH (F'c) IN 28 DAYS OF 3000 PSI WITH A 4" $(\pm 1")$ SLUMP UNLESS NOTED OTHERWISE.
- 3. CONCRETE COARSE AGGREGATE, WITH A MAXIMUM SIZE OF 1" MAY BE USED IN FOUNDATIONS. ALL OTHER CONCRETE SHALL HAVE A COARSE AGGREGATE WITH A MAXIMUM SIZE OF 3/4".
- 4. CONCRETE MIXING, TRANSPORTING, PLACING, AND CURING SHALL BE DONE IN ACCORDANCE WITH THE RECOMMENDATIONS OF ACI 301. READY-MIXED CONCRETE SHALL BE MIXED AND DELIVERED IN ACCORDANCE WITH REQUIREMENTS OF ASTM C94 OR ASTM
- 5. NO CONSTRUCTION LOADS SHALL BE SUPPORTED ON, NOR ANY SHORING REMOVED FROM, ANY PART OF THE STRUCTURE UNDER CONSTRUCTION EXCEPT WHEN THAT PORTION OF THE STRUCTURE IN COMBINATION WITH REMAINING FORMING AND SHORING SYSTEM HAS SUFFICIENT STRENGTH TO SUPPORT SAFELY ITS WEIGHT AND LOADS PLACED THEREON.
- 6. ALL EQUIPMENT FOR MIXING AND TRANSPORTING CONCRETE SHALL BE CLEAN, ALL DEBRIS, WATER AND ICE SHALL BE REMOVED PRIOR TO PLACING CONCRETE. FORMS SHALL BE PROPERLY COATED. REINFORCEMENT SHALL BE CLEAN OF ICE OR OTHER DELETERIOUS COATING. ALL LAITANCE AND OTHER UNSOUND MATERIAL SHALL BE REMOVED BEFORE ADDITIONAL
- CONCRETE IS PLACED AGAINST HARDENED CONCRETE. 7. MINIMUM COVER FOR CAST-IN-PLACE CONCRETE REINFORCEMENT:

		MINIMUM COVER (IN)
	(a) CONCRETE CAST AGAINST AND PERMANENTLY EXPOSED TO EARTH	3
	(b) CONCRETE EXPOSED TO EARTH OR WEATH	HER:
	#6 THROUGH #18 BARS#5 BAR, W31 OR D31 WIRE,	2
	AND SMALLER	1½
8.	UNLESS NOTED OTHERWISE, PROVIDE VERTICA IN RETAINING WALLS @ 20'-0" O.C. MAXIMUM TRAIL SLAB CONTROL JOINTS	

- TRAIL SLAB CONTROL JOINTS.
- COORDINATE CONCRETE FINISHES COATINGS WITH PROJECT MANAGER AND/OR OWNER.

COUNTY

DEKALB

PROJECT NUMBER

2020-205

ABBREVIATION (ALPHABETIZED)

A.B. = ANCHOR BOLTS = ARCHITECT = CONTROL JOINT = CAST IN PLACE CONC. = CONCRETE = CONTINUOUS = CONNECTION COORD. = COORDINATE = EDGE OF CONCRETE = EACH WAY = EXPANSION = EXTERIOR = FINISH FLOOR ELEVATION = FLOOR = FOOTING = GYPSUM BOARD = HANDRAIL

= HEADER = HORIZONTAL = INTERIOR = MAXIMUM = MANUFACTURER

= MOMENT CONNECTION = MINIMUM = ON CENTER = POWDER ACTUATED FASTENER

= REINFORCEMENT = REQUIRED = SIMILAR = SLAB ON GRADE = STANDARD


= STEEL = SQUARE = TOP & BOTTOM = TYPICAL

W.W.M. = WELDED WIRE MESH


= UNLESS NOTED U.N.O. = UNLESS NOTED OTHERWISE VERT. = VERTICAL

HSS2x2x¾6" DECORATIVE RAILING PANELS BY HANDRAIL POSTS OTHERS, PATTERN NOT SHOWN, 4'-0" SEE CITY OF BROOKHAVEN PANEL ATTACHMENTS STREETSCAPE DESIGN STANDARDS BY OTHERS 4"ø 16GA GALV. STEEL PIPE OR CORE DRILL FACE OF RETAINING WALL, NON-SHRINK GROUT COORDINATE FINISH W/ CLIENT

32-0001 SCALE: 1/2"=1'-0"

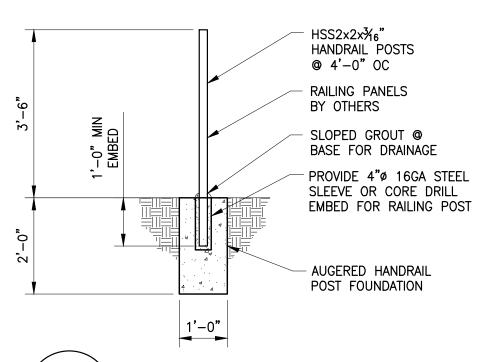


RAILING POST FOUNDATION 32-0001 SCALE: 1/2"=1'-0"

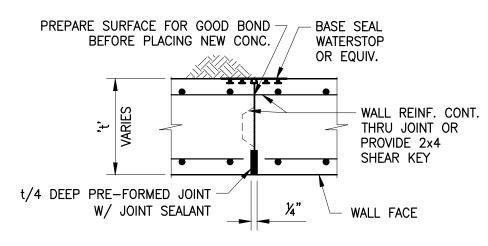


CONSTRUCTION JOINT - PLAN VIEW


NOTE: COORDINATE JOINTS W/ TRAIL SLAB CONSTRUCTION JOINTS, IF POSSIBLE. CONTRACTOR TO PROVIDE CONSTRUCTION JOINTS AS REQ'D FOR CONSTRUCTION.

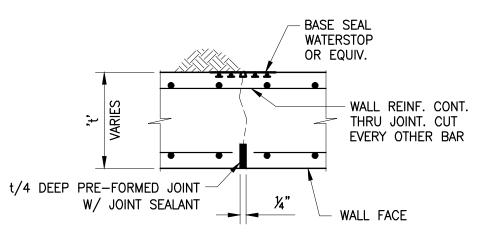

CONTROL JOINT - PLAN VIEW NOTE: COORDINATE JOINTS W/ TRAIL SLAB CONTROL JOINTS,

IF POSSIBLE. PROVIDE CONTROL JOINTS @ 20'-0" O.C. MAX.

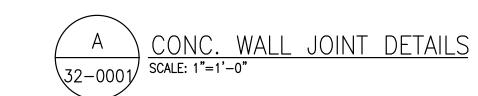

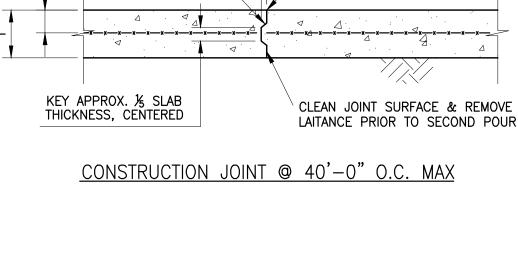

CONC.- FIRST POUR | CONC.- SECOND POUR

FORM OR SAW CUT GROOVE


¼"x¾" DEEP AND FILL WITH

BONDING SEALER


T/10 KEY

(¾" MIN.)

1:3 SLOPE

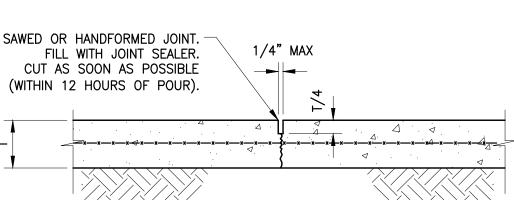

CONTROL JOINT @ 10'-0" O.C. MAX.

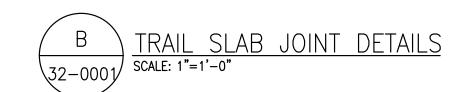

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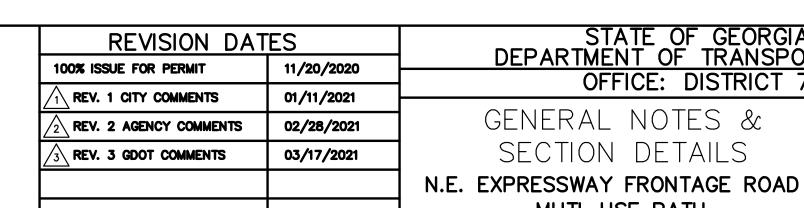
PLANS PREPARED BY: KAIZENCOLLABORATIVE Brookhaven

2390 Main Street | Tucker, GA 30084 | 404.239.2521

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CITY OF BROOKHAVEN DONALD SHERRILL - PUBLIC WORKS DEPUTY DIRECTOR 4362 PEACHTREE RD., BROOKHAVEN, GA 30319 E: DON.SHERRILL@BROOKHAVENGA.GOV O: 404-991-4763 C: 404-637-0682

> e STABILITY ENGINEERING 1376 Church St., Suite 200, Decatur, GA 30030 Ph/Fax: 404-377-9316 SE #20491





STATE OF GEORGIA DEPARTMENT OF TRANSPORTATION OFFICE: DISTRICT 7


GENERAL NOTES & SECTION DETAILS

MUTI-USE PATH

DRAWING No. 32-0001

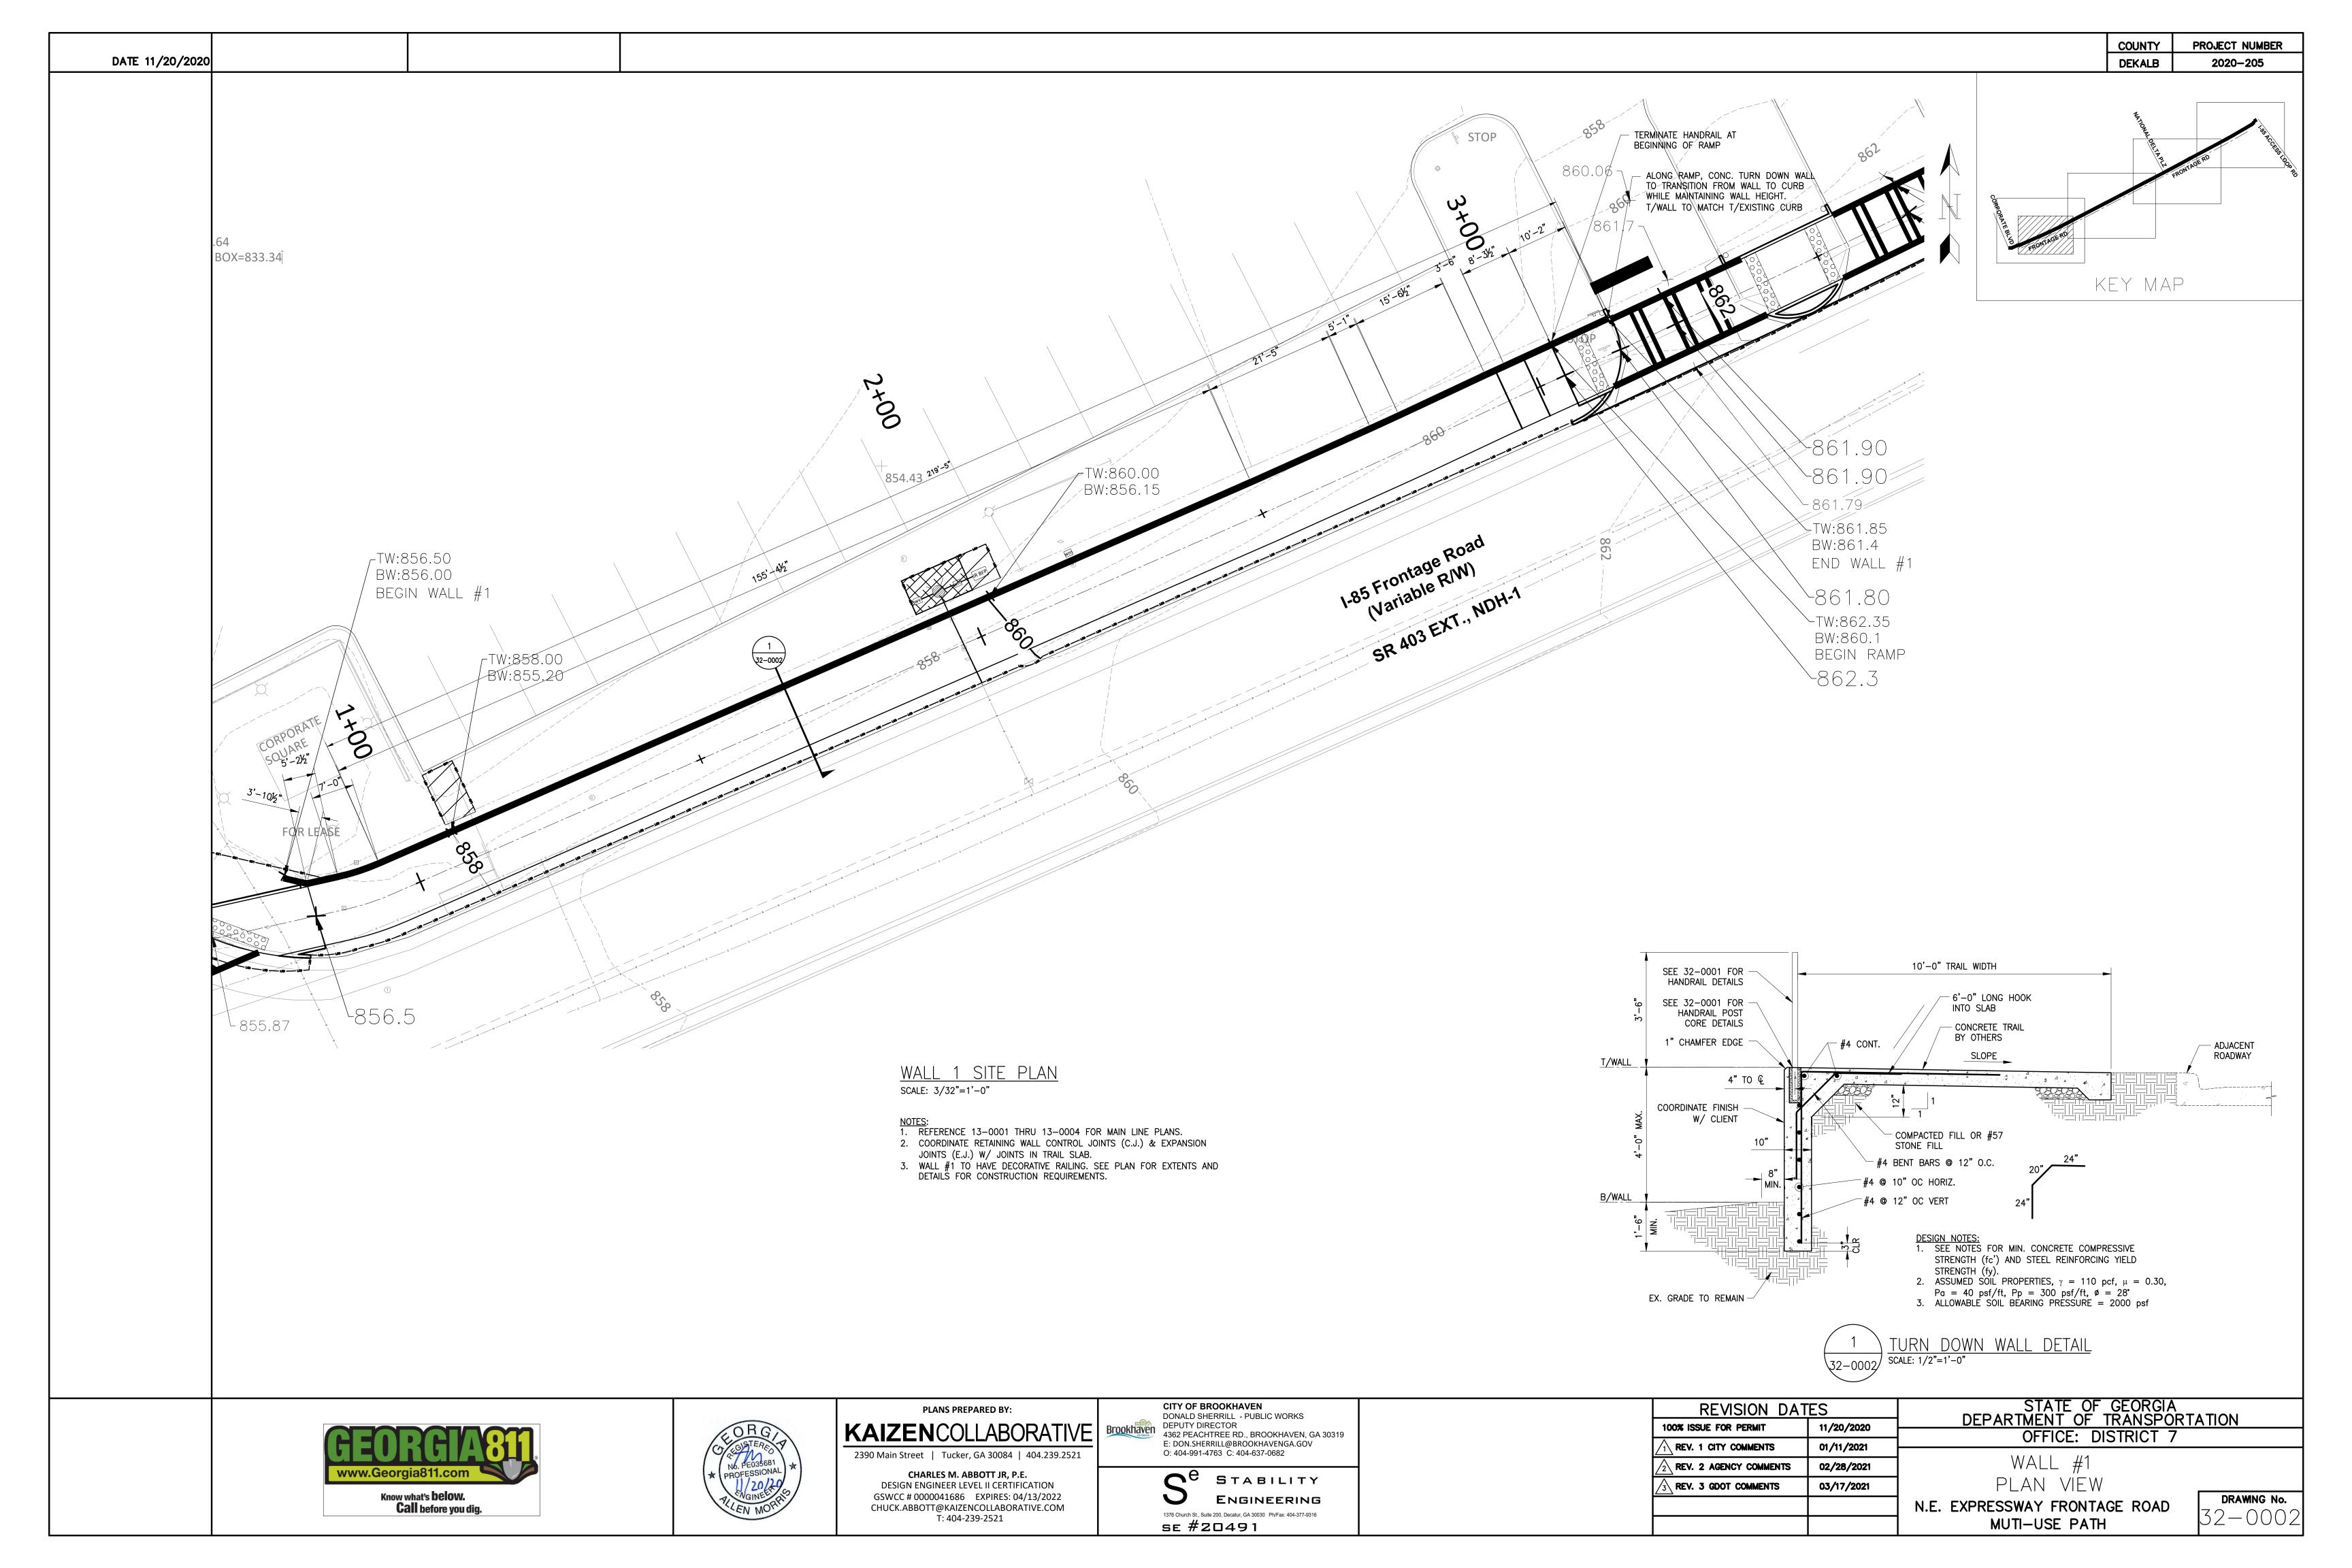

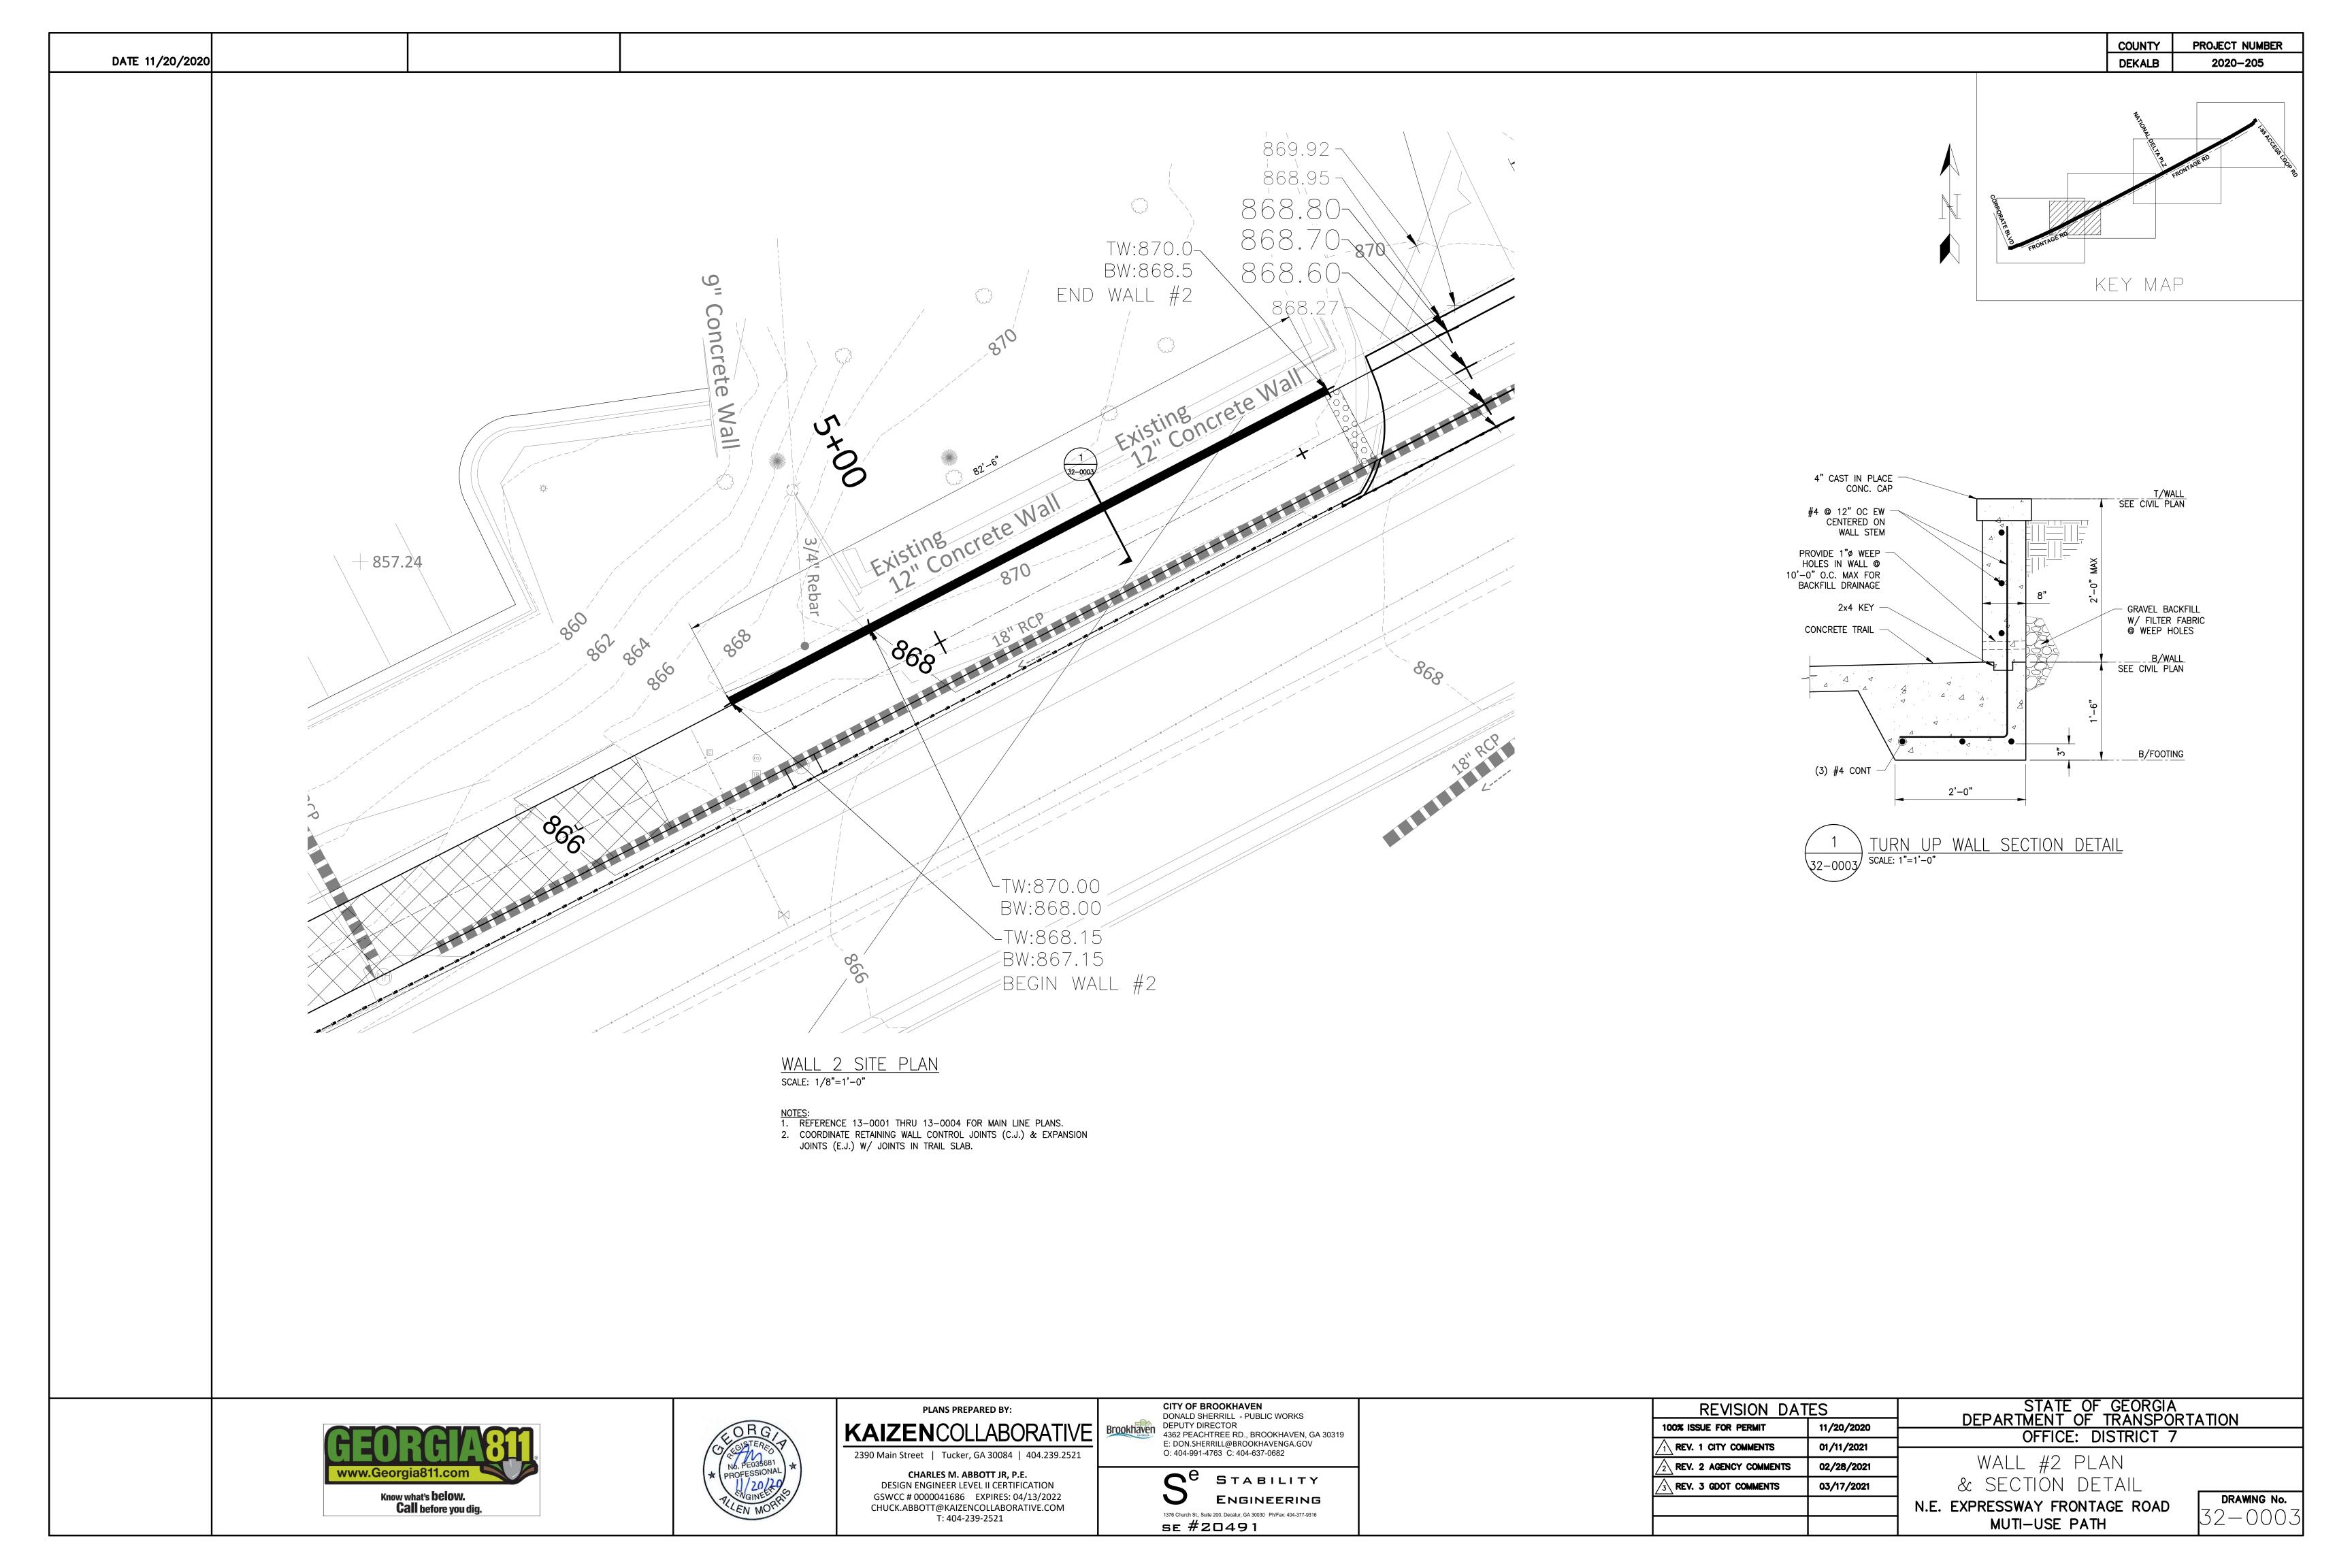

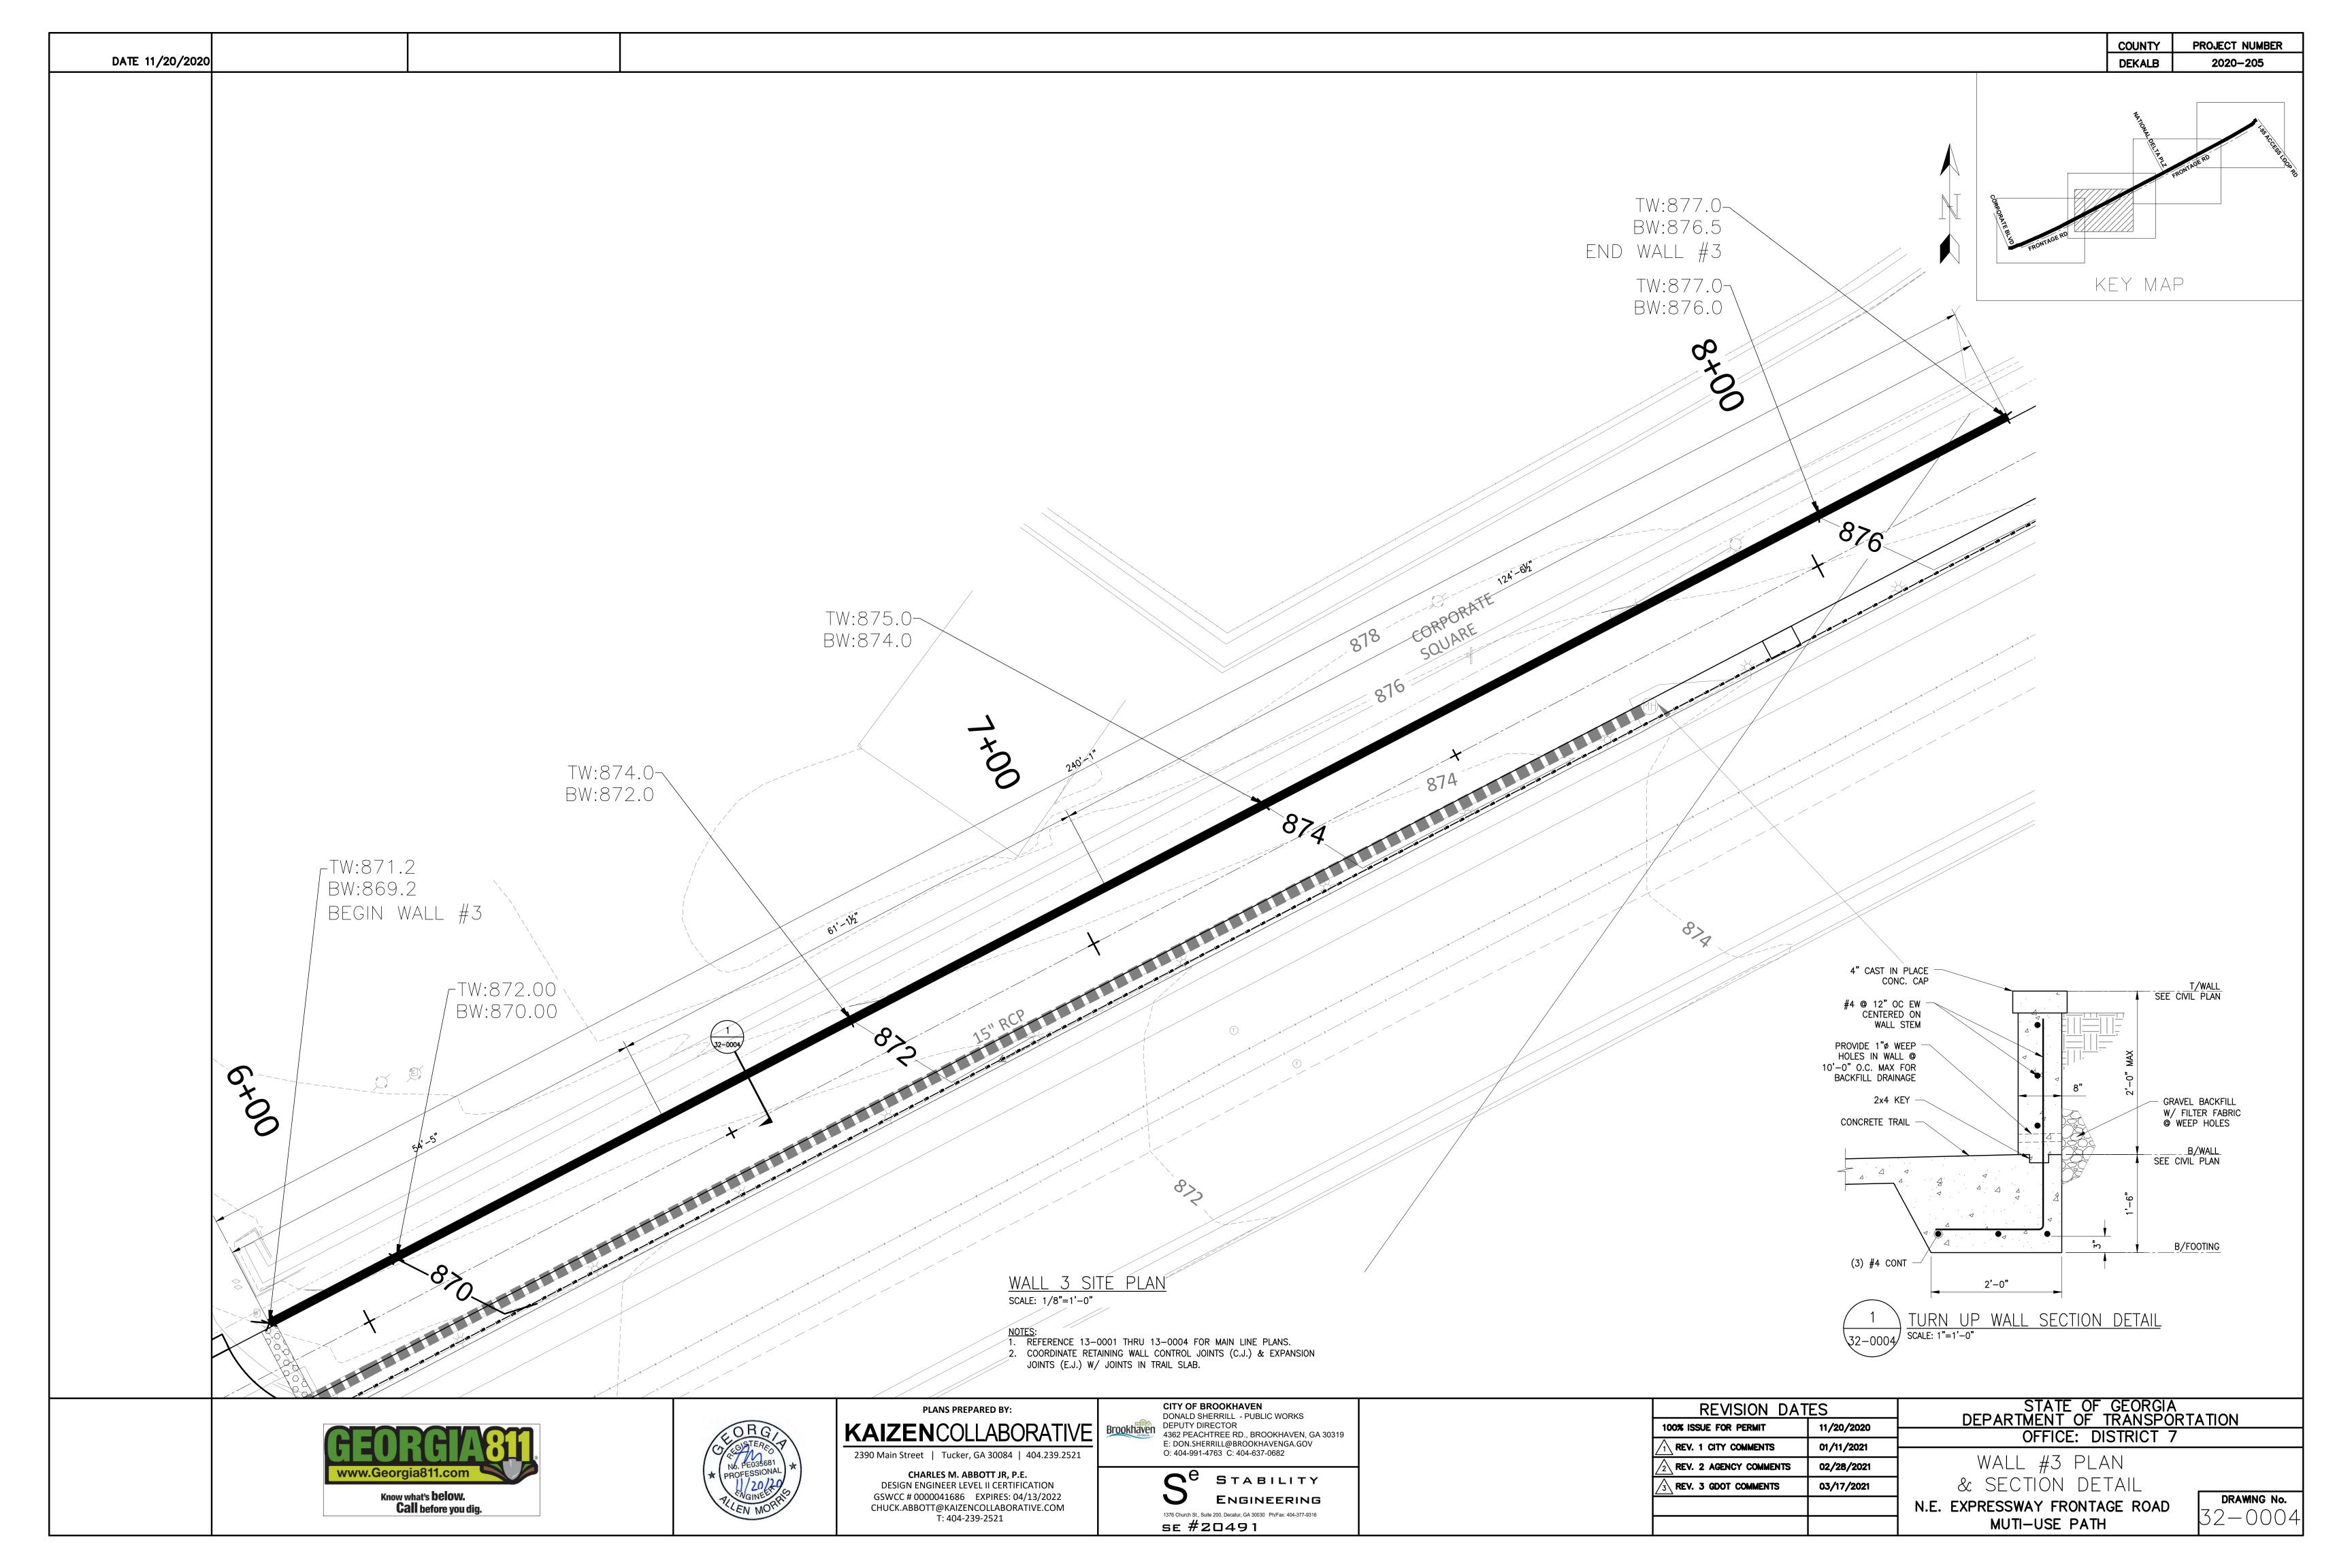

COUNTY PROJECT NUMBER DEKALB


2020-205

1) TRAIL CONCRETE TO BE 4" THICK EXCEPT WITHIN LIMITS OF A RADIUS WHERE IT IS TO BE 8"

2) CONTRACTOR TO SAW CUT CONTROL JOINT AT LEAST 3/4" DEPTH OF SLAB ACROSS ENTIRE WIDTH OF TRAIL. CONTROL JOINTS TO BE LOCATED EVERY 5' ALONG ENTIRE LENGTH OF TRAIL. CONTRACTOR REQUIRED TO REMOVE SAW DUST AFTER CUTTING.

3) 3/8" X 4" EXPANSION JOINTS TO BE LOCATED ALONG TRAIL MIN. EVERY 50' IN PLACE OF CONTROL JOINT.

4) TOOL ALL EXPOSED EDGES AND JOINTS TO 1/4" RADIUS

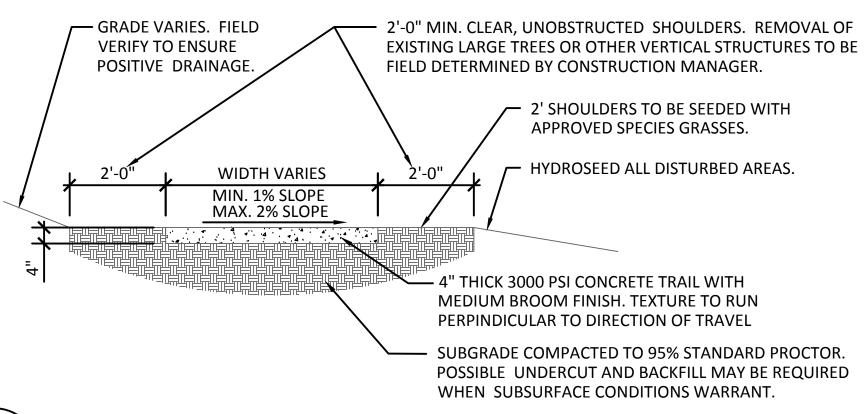




SCALE: 1/2" = 1'-0"

CONTRACTOR IS RESPONSIBLE FOR PRUNING AND TRIMMING TREES WITHIN THE TRAIL CLEAR ZONE TO THE STANDARDS OF THE INTERNATIONAL SOCIETY OF ARBORICULTURE (ISA). FOR MORE INFORMATION PLEASE REVIEW: http://www.treesaregood.com/treecare/pruning_mature.aspx **CLEAR ZONE:** ALL VEGETATION MUST BE REMOVED WITHIN 10' VERTICAL HEIGHT OF THE TRAIL AND 2' ON EITHER SIDE (TYP.) PATH TRAIL — FINISHED GRADE REFER TO PLANS FOR TRAIL WIDTH



1. ALL CROSSWALK MARKINGS TO BE ALKYO THERMOPLASTIC WITH CLEAN CUT EDGES (TYP.). CONFORM TO GDOT STANDARD SPECIFICATIONS FOR INSTALLATION, COLOR, AND FINISH.

*USE 5' FOR (L / 2) WHEN LANE WIDTH EXCEEDS 12', OR WHERE LANE LINES HAVE BEEN OMITTED.

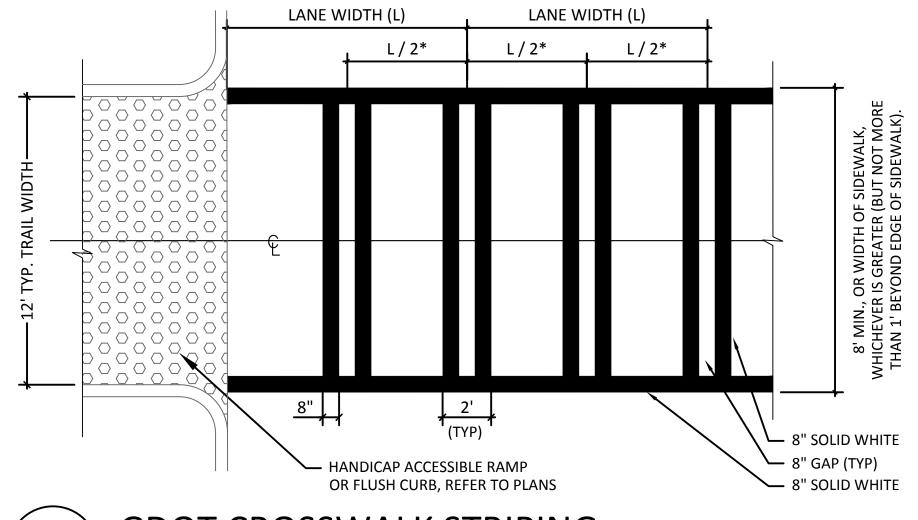

SCALE: 1/4" = 1'-0"


GDOT CROSSWALK STRIPING

1) CONCRETE TO BE 4" THICK EXCEPT WITHIN LIMITS OF A RADIUS WHERE IT IS TO BE 8"

2) CONTRACTOR TO SAW CUT CONTROL JOINT AT LEAST 3/4" DEPTH OF SLAB ACROSS ENTIRE WIDTH OF TRAIL. CONTROL JOINTS TO BE LOCATED EVERY 5' ALONG ENTIRE LENGTH OF TRAIL. CONTRACTOR REQUIRED TO REMOVE SAW DUST AFTER CUTTING.


3) 3/8" X 4" EXPANSION JOINTS TO BE LOCATED ALONG TRAIL MIN. EVERY 50' IN PLACE OF CONTROL JOINT.

4) TOOL ALL EXPOSED EDGES AND JOINTS TO 1/4" RADIUS

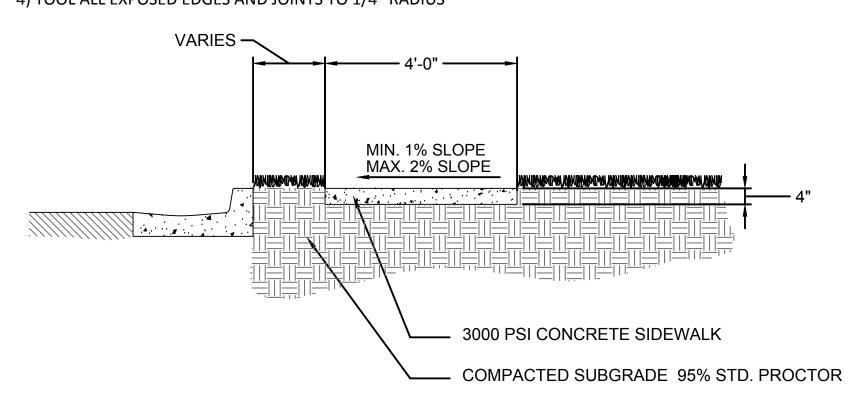

TYPICAL SIDEWALK

SCALE: 1/2" = 1'-0" \38-0001

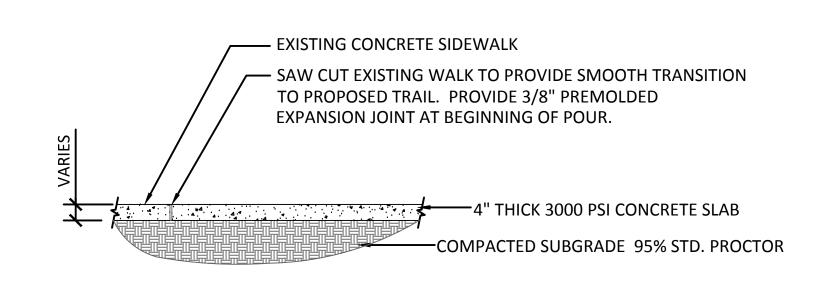

EXISTING WALK/TRAIL TRANSITION SCALE: 1/2" = 1'-0" \38-0001/

— SAW CUT EXISTING ASPHALT TO PROVIDE CLEAN TRANSITION TO PROPOSED CONCRETE. CONCRETE TRAIL COMPACTED SUBGRADE 95% STD. PROCTOR

ASPHALT STREET/TRAIL TRANSITION

SCALE: 1/2" = 1'-0" \38-0001



PLANS PREPARED BY: KAIZENCOLLABORATIVE 2390 Main Street | Tucker, GA 30084 | 404.239.2521

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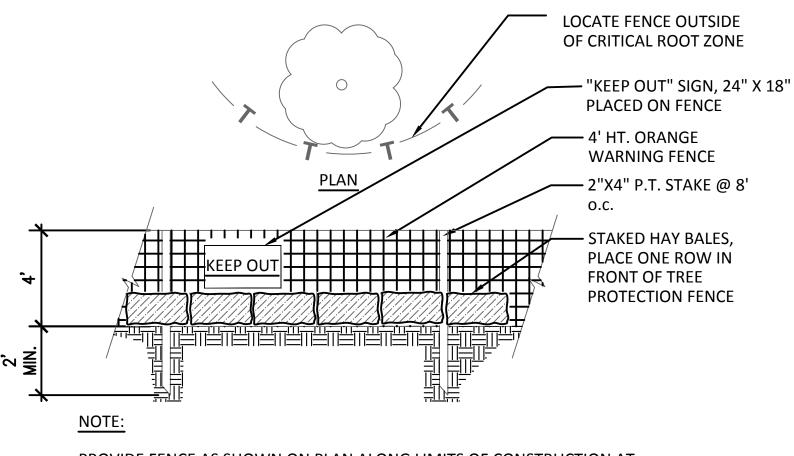
STATE OF GEORGIA DEPARTMENT OF TRANSPORTATION REVISION DATES 100% ISSUE FOR PERMIT 11/20/2020 OFFICE: DISTRICT 7 REV. 1 CITY COMMENTS 01/11/2021 REV. 2 AGENCY COMMENTS 02/08/2021

SPECIAL CONSTRUCTION DETAILS

N.E. EXPRESSWAY FRONTAGE ROAD MUTI-USE PATH

DRAWING No. 38-0001






PROVIDE FENCE AS SHOWN ON PLAN ALONG LIMITS OF CONSTRUCTION AT EDGE OF IMPACT TO CRITICAL ROOT ZONE. PROVIDE AT LEAST ONE FOOT OF DISTANCE FROM TREE TO FENCE FOR EACH INCH OF TREE DBH, WHERE DBH REFERS TO THE TREE DIAMETER MEASURED AT 4.5' ABOVE THE GROUND. STAKE ONE LAYER OF HAY BALES IN FRONT OF FENCE

TREE PROTECTION FENCE

SCALE: 1/4" = 1'-0"

NOTE: CONTRACTOR TO VERIFY LOCATION OF ROOT BRIDGING WITH PROJECT MANAGER PRIOR TO BEGINNING CONSTRUCTION. TRANSITION TO EXISTING GRADE. FILL MATERIAL (TYP.), THICKNESS VARIES ACCORDING TO EXISTING GRADES. CLEAR ZONE (2' TYP. SHOULDER). TRAIL; REFER TO DETAIL 1 / CD-01. WASHED #57 STONE BASE, THICKNESS VARIES; 4" MIN. - 6" MAX. ☐UNCOMPACTED SUBGRADE; EXISTING GRADE TO REMAIN UNDISTURBED 4% MAX. DEPTH VARIES; REFER TO GRADING PLAN. —FILTER FABRIC EXISTING TREE ROOTS **ROOT BRIDGING** SCALE: 1/4" = 1'-0" \38-0002/

- 1. RAMP LENGTH TRANSITIONS ON HIGH SIDE AND LOW SIDE OF DRIVEWAY VARY WITH ROAD GRADE.
- 2. PER GDOT DETAIL A3, RAMP LENGTH IS NOT REQUIRED TO EXCEED 15 FT.
- 3. SEE CONSTRUCTION PLANS FOR PROPOSED DRIVEWAY SPOT ELEVATIONS. FIELD ADJUST ELEVATIONS WITH PROJECT LANDSCAPE ARCHITECT & PROJECT CIVIL ENGINEER AS CONDITIONS REQUIRE.

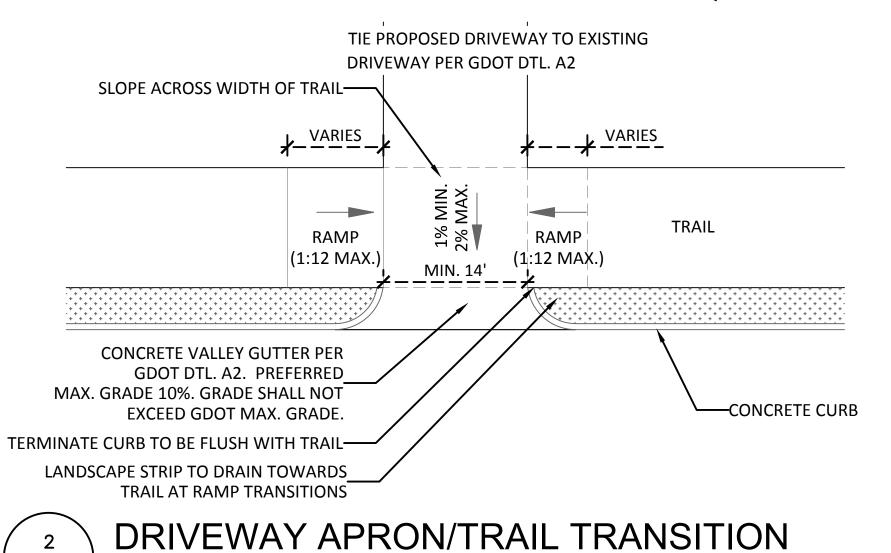

1. REFER TO MAINLINE PLANS FOR RAILING FLARE LOCATIONS. 2. REFER TO STRUCTURAL FOR WALL AND RAILING DETAILS. EXTEND RAILING (1) BAY BEYOND -TURNDOWN EDGE/RETAINING WALL RAILING · TURNDOWN EDGE/RETAINING WALL


END RAILING FLARE: PLAN VIEW

SCALE: 1/4" = 1'-0"

*FOR 115kV SUBSTATION YARDS & SMALLER, 6" OF #57 STONE SHALL BE INSTALLED ON COMPACTED SUBGRADE FOR DRIVEWAYS

*SUBGRADE FOR DRIVEWAYS SHALL BE COMPACTED TO A MINIMUM OF 95 PERCENT OF MAXIMUM DRY DENSITY AS DETERMINED BY THE STANDARD PROCTOR TEST ASTM-D-698. THE TOPE ONE (1) FOOT SHOULD BE COMPACTED TO A MINIMUM OF 98 PERCENT.

HEAVY DUTY CONCRETE DESIGN DETAIL TO BE USED AT ALL GEORGIA POWER DRIVEWAY CROSSINGS

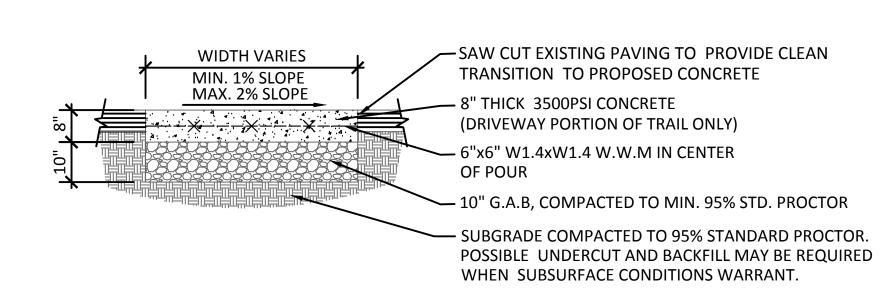


NOTE:

- 1) REFER TO DRAWING 3/40-0001 "GDOT STD. DRIVEWAY APRON" FOR CURB DETAILS AND TIE-BACK INSTRUCTION OF DRIVEWAY TO EXISTING ROAD.
- 2) ALL SLOPES/GRADING TO BE BASED OFF CONTOURS, SPOTS, AND CROSS SECTIONS ON SHEET 13-0002

-10" GRADED AGGREGATE NOTE: FOR ALL FILLS GREATER THAN 10 FEET, A CROSS-SLOPE OF 4:1 IS RECOMMENDED. ALL DRIVEWAY SLOPES ARE 3:1, MAXIMUM. TYPICAL DRIVE SECTION COMPACTED **OUTSIDE SUBSTATION YARD** SUBGRADE FOR 230kV AND 500kV YARDS

** SEE ADJACENT DETAIL FOR DRIVEWAY SPECIFICATIONS. #57 STONE IS NOT ACCEPTABLE FINAL SURFACE MATERIAL FOR THIS PROJECT. THIS DETAIL AS BEEN PROVIDED BY GEORGIA POWER FOR REFERENCE ONLY, REFER TO SHEET 13-0002 FOR DRIVEWAY GRADES

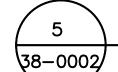


GA POWER SUBSTATION DRIVEWAY APRON DETAIL

SCALE: 1/2" = 1'-0"

SCALE: 1/8" = 1'-0"



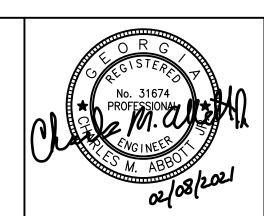


PLANS PREPARED BY: KAIZENCOLLABORATIVE 2390 Main Street | Tucker, GA 30084 | 404.239.2521

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REVISION DATES		STATE OF GEORGIA	ATION
100% ISSUE FOR PERMIT	11/20/2020	DEPARTMENT OF TRANSPORT OFFICE: DISTRICT 7	ATION
REV. 1 CITY COMMENTS	01/11/2021	OTTIOE. DISTRICT /	
REV. 2 AGENCY COMMENTS	02/08/2021	SPECIAL CONSTRUCTION	DETAILS
			DRAWING No
		N.E. EXPRESSWAY FRONTAGE ROAD MUTI-USE PATH	38-000

DRAWING No.



Guard Railing Systems

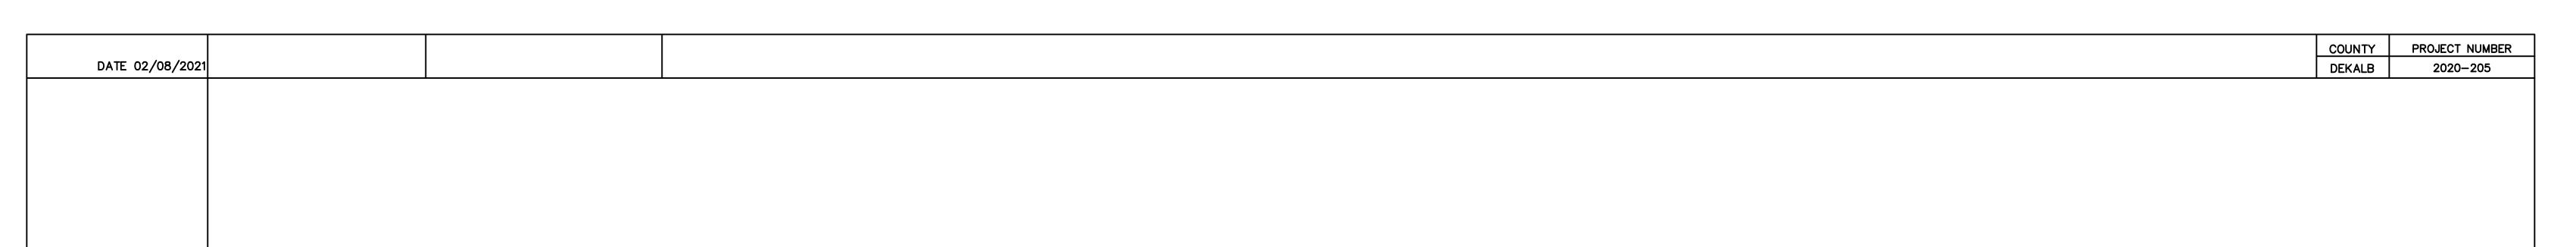
Material: Hot rolled Steel Finish: Powdercoat finish Infil Panel Design: TBD Connectors hardware: Stainless Steel 304 Base insert: Stainless steel sleeve, 2" diameter, backfilled with non-shrink grout. Inset depth to be 12" minimum.

 The railings will be a square pipe rail frame, at 4 foot intervals, that accepts digitally fabricated metal panels that can reflect the unique situations and locations that they are installed in.

All steel to be shop welded and


Finish assembly to be completed in

Color: RAL 9007

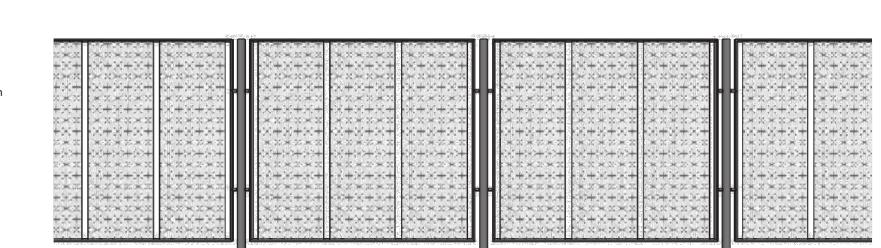


STREETSCAPE DESIGN STANDARDS | CITY OF BROOKHAVEN | AUGUST 28, 2018


ST-03

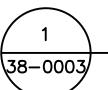

CITY OF BROOKHAVEN STANDARD RAILING DETAIL

38-0003 SCALE: 1/4'' = 1'-0''

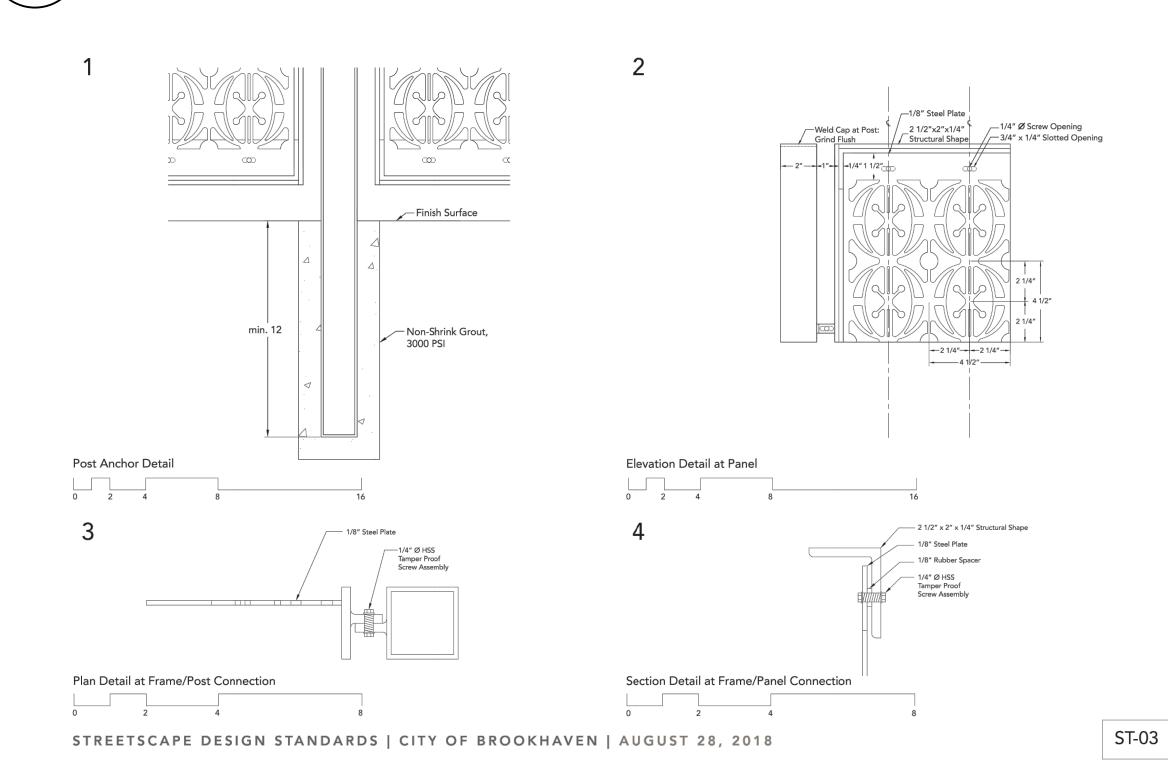

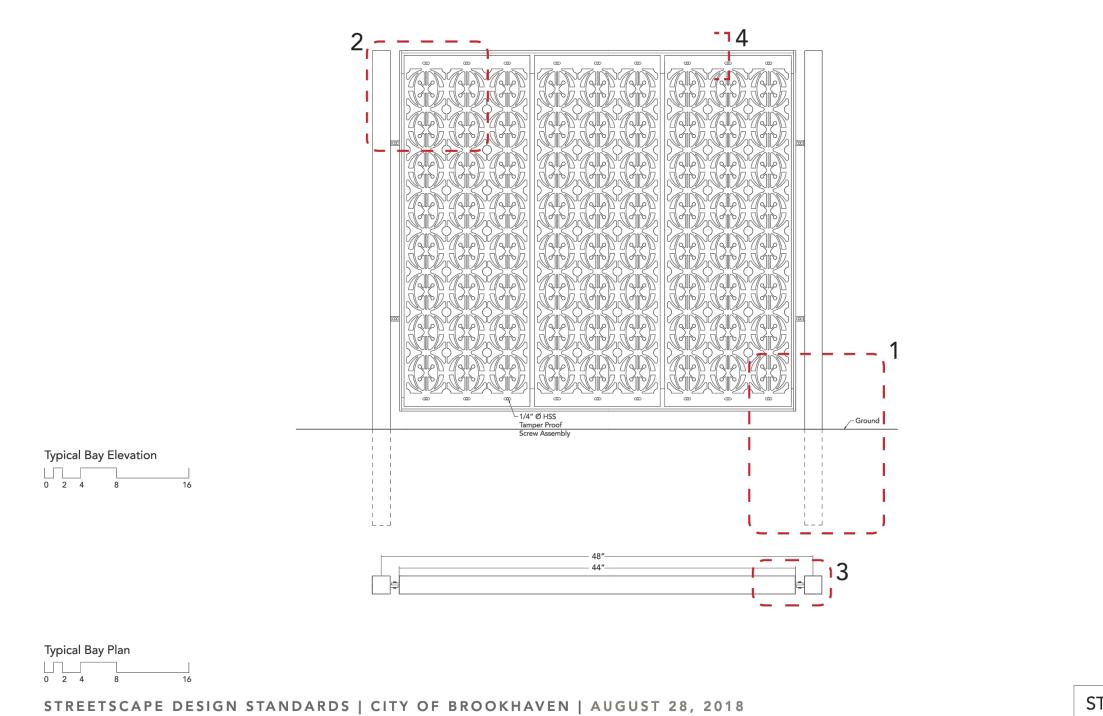


CITY OF BROOKHAVEN STANDARD RAILING - PANEL DETAIL

 $\sqrt{38-0003}$ SCALE: 1/4'' = 1'-0''

CITY OF BROOKHAVEN STANDARD RAILING - PANEL ENLARGEMENT DETAIL

SCALE: 1/4" = 1'-0"



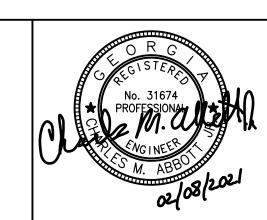

PLANS PREPARED BY: KAIZENCOLLABORATIVE			
2390 Main Street Tucker, GA 30084 404.239.2521			
CHARLES M. ABBOTT JR, P.E. DESIGN ENGINEER LEVEL II CERTIFICATION			


GSWCC # 0000041686 EXPIRES: 04/13/2022 CHUCK.ABBOTT@KAIZENCOLLABORATIVE.COM


T: 404-239-2521

CITY OF BROOKHAVEN DONALD SHERRILL - PUBLIC WORKS Brookhaven DEPUTY DIRECTOR 4362 PEACHTREE RD., BROOKHAVEN, GA 30319 E: DON.SHERRILL@BROOKHAVENGA.GOV O: 404-991-4763 C: 404-637-0682

REVISION DATES		STATE OF GEORGIA DEPARTMENT OF TRANSPORTATION	
100% ISSUE FOR PERMIT	11/20/2020	OFFICE: DISTRICT 7	ATION
1 REV. 1 CITY COMMENTS 01/11/2021	CDECIAL CONCEDUCTION DETAILS		
	02/08/2021	SPECIAL CONSTRUCTION	DETAILS
		N.E. EXPRESSWAY FRONTAGE ROAD	DRAWING No.
		MUTI-USE PATH	38-0003

PROJECT NUMBER COUNTY DATE 02/08/202 DEKALB 2020-205

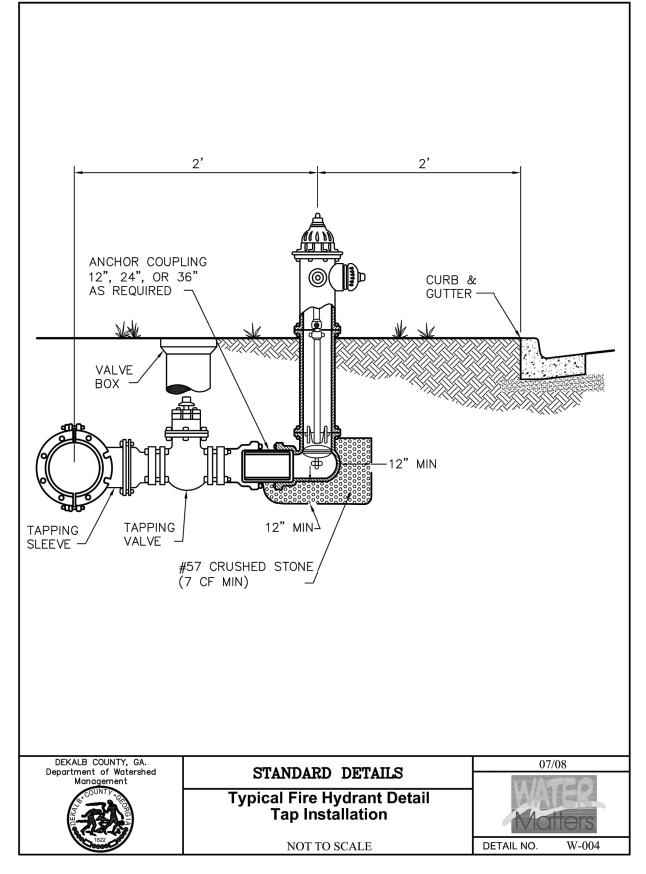

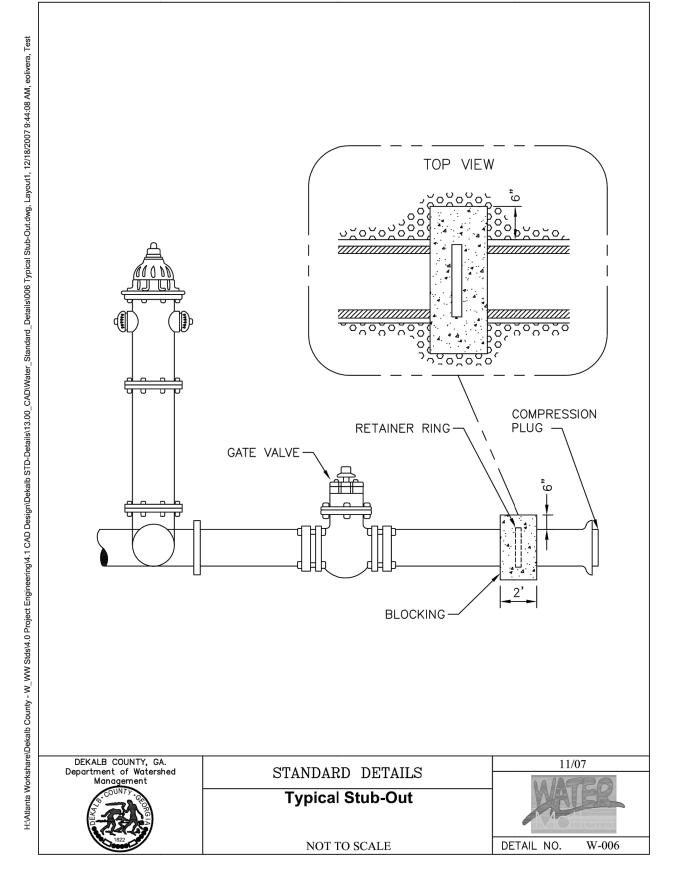


DEKALB COUNTY TYP. FIRE HYRDANT TAP INSTALLTION AND STUB OUT DEATAILS

38-0004 NTS


VALVE BOX -SQUARE WRENCH NUT — GATE VALVE -DEKALB COUNTY, GA. Department of Watershed STANDARD DETAILS **Typical Gate Valve** Installation NOT TO SCALE

DEKALB COUNTY TYP. GATE VALVE DETAIL 38-0004/ NTS

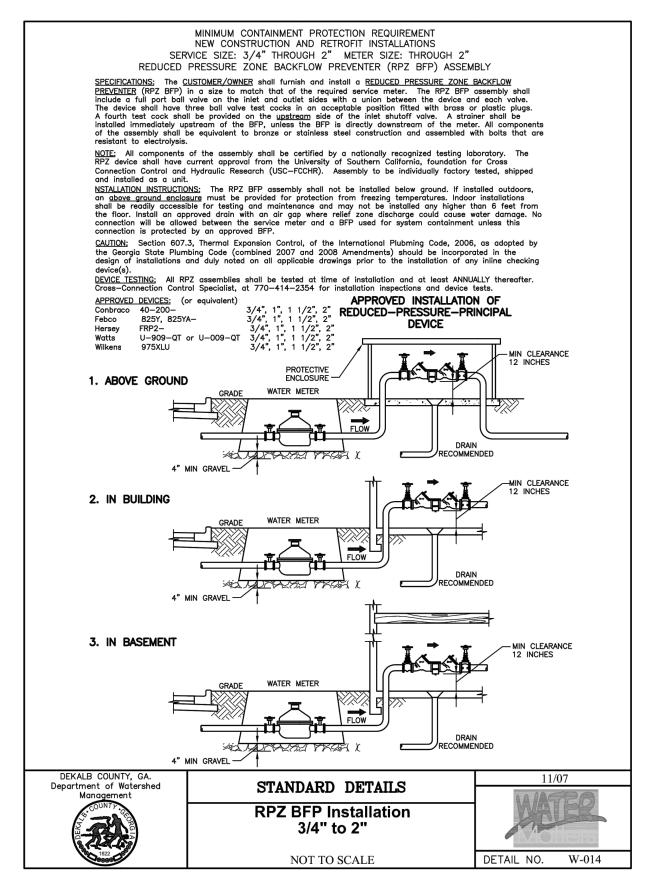

DEKALB COUNTY RPZ BFP INSTALLATION DETAIL 38-0004/ NTS

CITY OF BROOKHAVEN

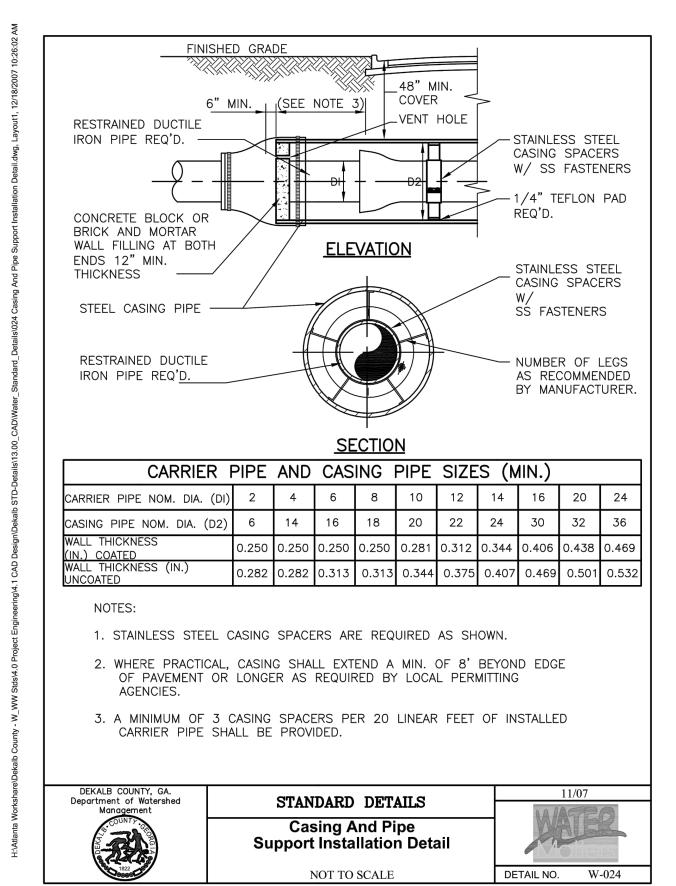

38-0004

DEKALB COUNTY CASING AND PIPE SUPPORT DETAIL

Know what's **below. Call** before you dig.



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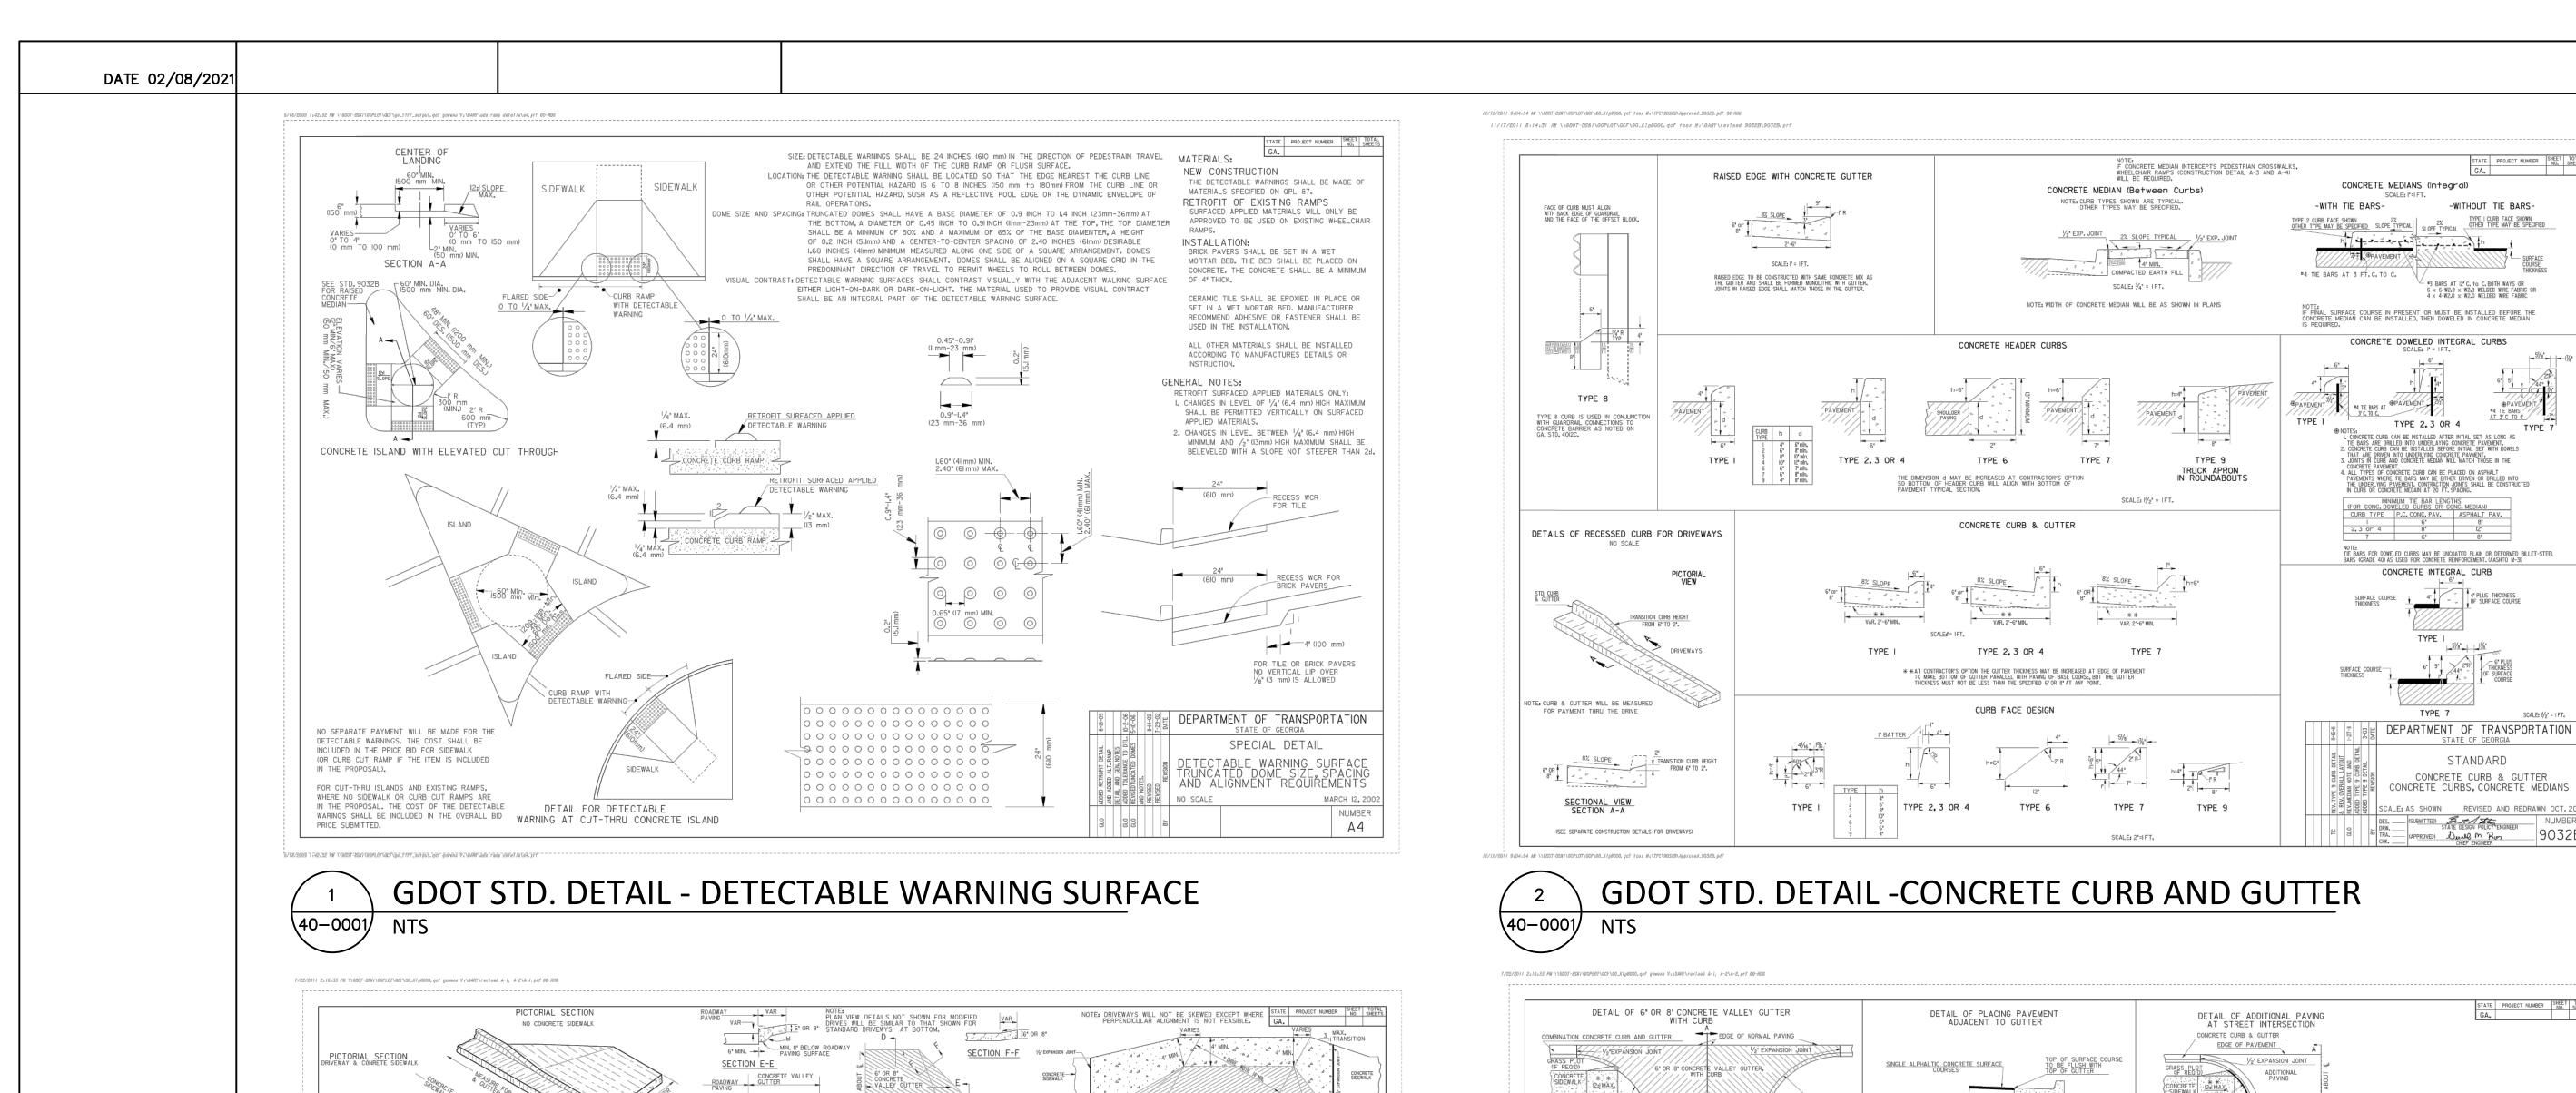
DONALD SHERRILL - PUBLIC WORKS Brookhaven DEPUTY DIRECTOR 4362 PEACHTREE RD., BROOKHAVEN, GA 30319 E: DON.SHERRILL@BROOKHAVENGA.GOV O: 404-991-4763 C: 404-637-0682 CHARLES M. ABBOTT JR, P.E. DESIGN ENGINEER LEVEL II CERTIFICATION GSWCC # 0000041686 EXPIRES: 04/13/2022

REVISION DAT		
100% ISSUE FOR PERMIT	11/20/2020	
1 REV. 1 CITY COMMENTS	01/11/2021	
2 REV. 2 AGENCY COMMENTS	02/08/2021	
		N.E.

STATE OF GEORGIA DEPARTMENT OF TRANSPORTATION OFFICE: DISTRICT 7 SPECIAL CONSTRUCTION DETAILS

EXPRESSWAY FRONTAGE ROAD MUTI-USE PATH

DRAWING No.



N.E.P. 4'-0' N.E.P. D TRANS.

PLANS E OR INTEGRAL CURB DRIVE ENTRANCE MODIFIED FOR SKEW DRIVE MODIFIED FOR HEADER OR INTEGRAL CURB ALONG ROADWAY GENERAL NOTES: CONCRETE VALLEY VARIES
GUTTER 4' MIN. SEE PLANS SHOULDER
THE CONCRETE VALLEY
ORNVENAY

27. MAX
MAY BE FLAT

ASPHALT PAVING, CONCRETE
VALUE


SECTION C-C N.E.P.IS DEFINED AS THE POINT WHERE THE ROADWAY PAVING MEETS THE CURB & GUTTER, OR HEADER CURB, OR FACE OR THE INTEGRAL CURB. (SPECIAL CASE FOR <u>SECTION B-B</u> OR <u>SECTION C-C:</u> WHERE THE SHOULDER OR SIDEWALK IS SLOPED AWAY FROM THE ROAD) DRIVES RECONSTRUCTED SHALL BE REPLACED IN KIND, LE, ASPHALT FOR ASPHALT, CONCRETE FOR CONCRETE, AND PAVED TO THE RIGHT OF WAY LINE. SEE STANDARD 9032-B FOR DETAILS OF CONCRETE CURB & GUTTER, HEADER CURBS AND DOWELED INTEGRAL CURBS. ROADWAY PAVING 2'-6' CONCRETE VALLEY GUTTER a' 6' 4' MIN. / -2 Z 8% 1 #7'-0"(MAX.)

DRIVE WIDTH, 14'-0" MIN. 3'-0"

MAX. 4'-0" -CURBING SHOWN AS TYPICAL AND WILL DIFFER WHEN SPECIFIED DOWELED INTEGRAL CURB 3 IS BEGINNING OF DRIVEWAY TIE-IN. This Detail Replaces Ga Standard 6050 DEPARTMENT OF TRANSPORTATION * 4'-0' (MAX.) C - C - C - 3'-0" (MAX.) /2DRIVE WIDTH /2DRIVE WIDTH 3'-0" * CONSTRUCTION DETAIL DRIVEWAYS WITH TAPERED ENTRANCES CONCRETE VALLEY GUTTERS NUMBER RESIDENTIAL, COMMERCIAL OR NON-COMMERCIAL DRIVE ₩ 7'-0" OR DISTANCE EQUAL TO THAT FROM BACK OF CURB TO BACK OF SIDEWALK, WHICHEVER IS LESSER ΑI

GDOT STD. DETAIL - DRIVEWAY APRON

40-0001 NTS

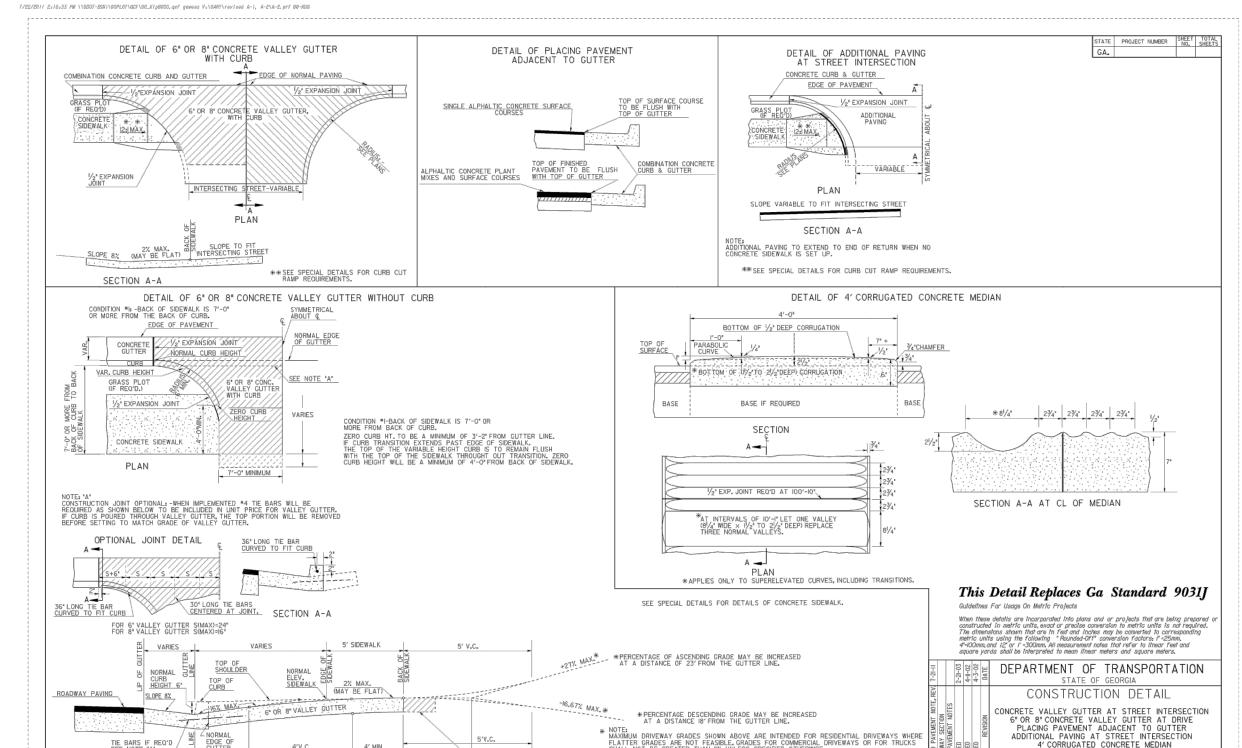


GDOT STD. DETAIL - CONCRETE VALLEY GUTTER

40-0001 NTS

SECTION AT Q OF DRIVEWAY



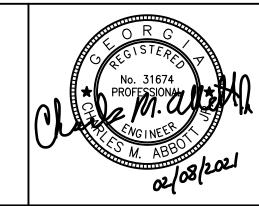

PLANS PREPARED BY:

KAIZENCOLLABORATIVE

2390 Main Street | Tucker, GA 30084 | 404.239.2521

2390 Main Street | Tucker, GA 30084 | 404.239.25

CHARLES M. ABBOTT JR, P.E.

DESIGN ENGINEER LEVEL II CERTIFICATION
GSWCC # 0000041686 EXPIRES: 04/13/2022
CHUCK.ABBOTT@KAIZENCOLLABORATIVE.COM
T: 404-239-2521

CITY OF BROOKHAVEN
DONALD SHERRILL - PUBLIC WORKS
DEPUTY DIRECTOR
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O: 404-991-4763 C: 404-637-0682

7/22/2017 2:16:33 PM \\BD07-8581\D0FL0T\GCT\B0_RTpB000.qet "gewehe" V:\GARY\TeVfeed A-1, "A-2\A-2\pit

REVISION DAT	ES	_
100% ISSUE FOR PERMIT	11/20/2020	L
REV. 1 CITY COMMENTS	01/11/2021	
REV. 2 AGENCY COMMENTS	02/08/2021	GDOT
		N.E. EX

STATE OF GEORGIA

DEPARTMENT OF TRANSPORTATION

OFFICE: DISTRICT 7

OT STANDARD DETAIL

COUNTY

DEKALB

PROJECT NUMBER

2020-205


E. EXPRESSWAY FRONTAGE ROAD

MUTI-USE PATH

4

Α2

DRAWING No. 40-001

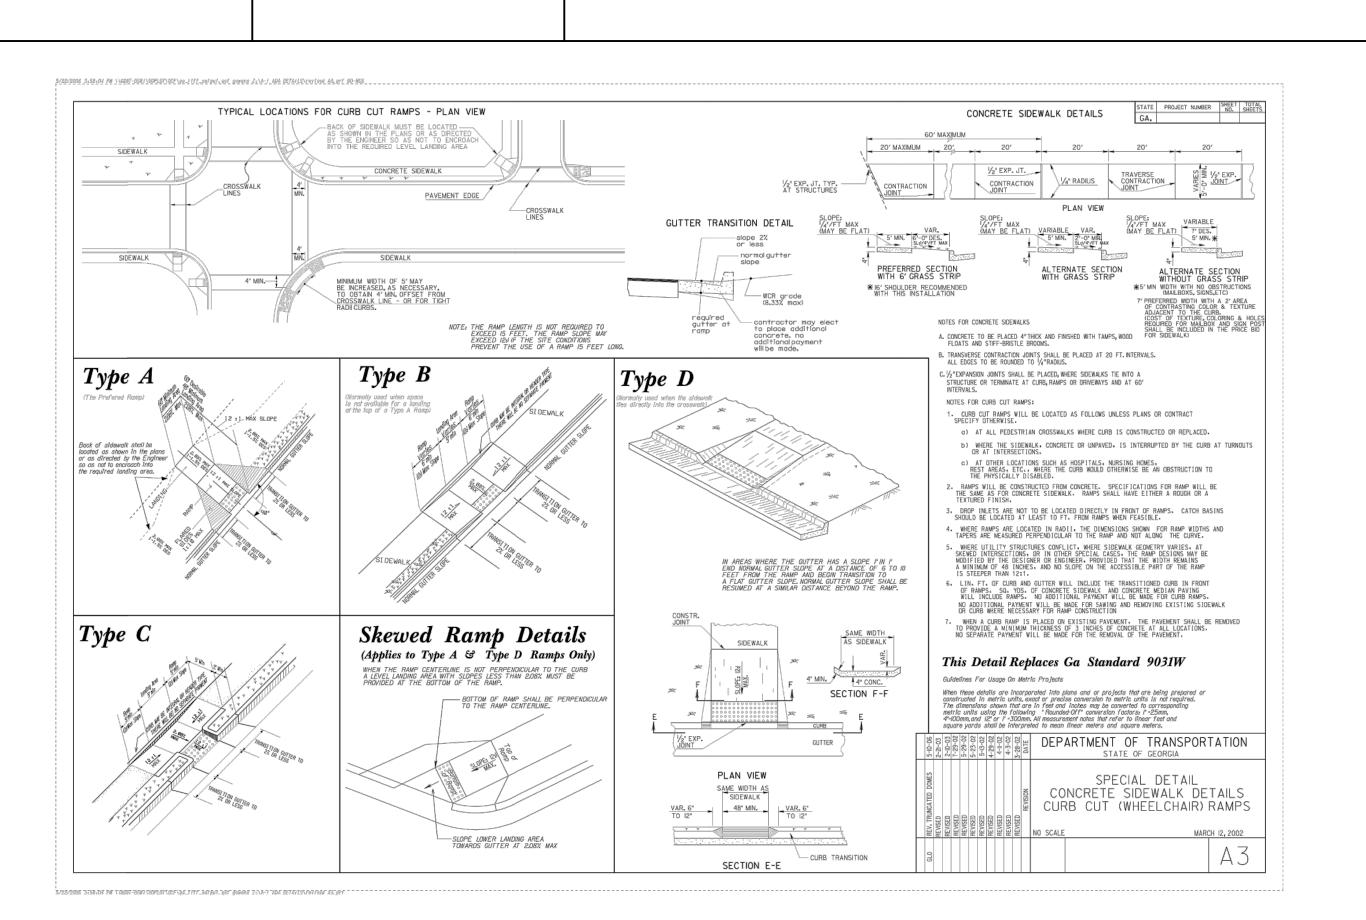


1 GDOT 40-0002 NTS

DATE 02/08/2021

GDOT STD. DETAIL - RAMPS

CEORGIASII.com

Know what's below.
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PLANS PREPARED BY:
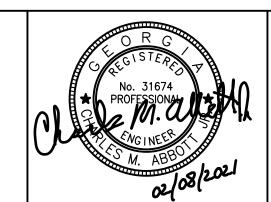
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2390 Main Street | Tucker, GA 30084 | 404.239.2521

CHARLES M. ABBOTT JR, P.E.

DESIGN ENGINEER LEVEL II CERTIFICATION

GSWCC # 0000041686 EXPIRES: 04/13/2022

CHUCK.ABBOTT@KAIZENCOLLABORATIVE.COM

T: 404-239-2521

Brockhaven
DONALD SHERRILL - PUBLIC WORKS
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REVISION DATES		STA
100% ISSUE FOR PERMIT	11/20/2020	DEPARTME!
REV. 1 CITY COMMENTS	01/11/2021	OI I
REV. 2 AGENCY COMMENTS	02/08/2021	GDOT STAND
		N.E. EXPRESSWAY
		l Muti-u

STATE OF GEORGIA

DEPARTMENT OF TRANSPORTATION

OFFICE: DISTRICT 7

OOT STANDARD DETAIL

COUNTY

DEKALB

PROJECT NUMBER

2020-205

I.E. EXPRESSWAY FRONTAGE ROAD

MUTI-USE PATH

drawing no. 40–0002

PROJECT NUMBER 2020-205

EROSION CONTROL NOTES 1) EROSION CONTROL MEASURES WILL BE MAINTAINED AT ALL TIMES. IF FULL IMPLEMENTATION OF THE APPROVED PLAN DOES NOT PROVIDE FOR EFFECTIVE EROSION CONTROL, ADDITIONAL EROSION AND SEDIMENT CONTROL MEASURES SHALL BE IMPLEMENTED TO CONTROL OR TREAT THE SEDIMENT

ALL BMPS WILL BE INSPECTED DAILY AND ANY DIFICIENCIES NOTED WILL BE CORRECTED BY THE END OF EACH DAY. ADDITIONAL BMPS WILL BE INSTALLED IF DEEMED NECESSARY BY ON-SITE INSPECTION.

3) ALL DISTURBED AREAS MUST BE SEEDED, FERTILIZED, AND MULCHED AS SOON AS CONSTRUCTION PHASE PERMIT. ALSO, THESE DISTURBED AREAS MUST BE PROTECTED UNTIL PERMANENT VEGETATION IS ESTABLISHED

4) THE ESCAPE OF SEDIMENT FROM THE SITE SHALL BE PREVENTED BY THE INSTALLATION OF EROSION AND SEDIMENT CONTROL MEASURES AND PRACTICES PRIOR TO LAND-DISTURBING ACTIVITIES.

ALL UNSURFACED AREAS DISTURBED BY GRADING OPERATIONS SHALL RECEIVE FOUR (4) INCHES OF TOPSOIL. CONTRACTOR SHALL APPLY STABILIZATION FABRIC TO ALL SLOPES THAT ARE 10' OR GREATER IN HEIGHT & SLOPE OF 3H:1V OR GREATER AS NECESSARY TO RETAIN TOPSOIL. CONTRACTOR SHALL MAINTAIN BEST MANAGEMENT PRACTICES ON DISTURBED SLOPES IN ACCORDANCE WITH THE MANUAL FOR EROSION AND SEDIMENT CONTROL IN GEORGIA UNTIL A HEALTHY STAND OF GRASS IS MAINTAINED OVER MORE THAN 70% OF THE

DISTURBED AREA AND TO THE SATISFACTION OF THE OWNER. 5) it is the responsibility of the contractor to clean out ALL EXISTING AND PROPOSED INLETS, PIPES, AND MANHOLES OF DEBRIS AND SEDIMENT AT COMPLETION OF THE SITE WORK IN CONFORMANCE WITH ALL STATE AND LOCAL SPECIFICATIONS, AND TO THE SATISFACTION OF THE OWNER

) SILT FENCE SHALL MEET THE REQUIREMENTS OF SECTION 171, "SILT FENCE" OF THE STATE OF GEORGIA DEPARTMENT OF TRANSPORTATION STANDARD SPECIFICATIONS, AND MEET SPECIFICATIONS FOR TYPE "C" SILT FENCE IN THE "MANUAL FOR EROSION AND SEDIMENT CONTROL IN GEORGIA", AND SHALL BE WIRE REINFORCED AS REQUIRED BY THESE SPECIFICATIONS. A DOUBLE ROW MUST BE INSTALLED BETWEEN LAND DISTURBING ACTIVITIES AND STATE WATERS.

B) ALL EARTHWORK OPERATIONS SHOULD BE SCHEDULED IN A MANNER TO MAINTAIN PROPER ROUTING OF STORM WATER THROUGH SEDIMENT CONTROL DEVICES. IF IT IS NECESSARY TO PERFORM CONSTRUCTION ACTIVITIES IN AN ORDER THAT IS NOT IN ACCORDANCE WITH THE ACTIVITY SCHEDULE ON THIS PLAN, OR THE CONSTRUCTION SCHEDULE WILL ALLOW FOR DISTURBED AREAS TO BYPASS BEST MANAGEMENT PRACTICES, THE CONTRACTOR IS TO CONTACT THE ENGINEER PRIOR TO COMMENCEMENT OF SUCH ACTIVITIES AND IMPLEMENT EROSION CONTROL DEVICES THAT WILL CONTROL SEDIMENT, AT THE SATISFACTION OF THE ENGINEER AND IN ACCORDANCE WITH THE MANUAL FOR EROSION AND SEDIMENT CONTROL IN

) DETENTION FACILITIES AND EROSION CONTROL MEASURES ARE TO BE ACCOMPLISHED PRIOR TO ANY OTHER CONSTRUCTION ON THE SITE AND MAINTAINED UNTIL PERMANENT GROUND COVER IS ESTABLISHED.

))LENGTH OF RIPRAP SHALL BE 6 TIMES THE DIAMETER OF THE STORMWATER OUTLET PIPE AT A MINIMUM.

WASHOUT

1) FILE NOTICE OF INTENT AND NOTICE OF TERMINATION WITH GA EPD IF REQUIRED.

APPROX. LOCATION OF CONC.

USE WASHOUT SYSTEMS OR

CONTRACTOR TO DETERMINE

855.34 \

854.7

TOP=855.28

INV IN(A)=851.53

INV IN(B)=846.53 BOTTOM BOX=836.88

855.33 -

EXACT LOCATION ON-SITE.

ECO-PAN, PER CITY.

12) NO CONCRETE VEHICLE WASHDOWN OR UNPROTECTED STORAGE OF PETROLEUM PRODUCTS IS ALLOWED ON SITE. 13) STORMWATER POLLUTANTS ARE DECREASED ON THIS SITE WITH THE INSTALLATION OF SEDIMENT BARRIERS AND PERMANENT VEGETATIVE COVER. THE VEGETATIVE COVER WILL REMAIN AS

A PERMANENT GROUND STABILIZATION MEASURE 14) AMENDMENTS/REVISIONS TO THE ES&PC PLAN WHICH HAVE A SIGNIFICANT EFFECT ON BMPs WITH A HYDRAULIC COMPONENT MUST BE CERTIFIED BY THE DESIGN PROFESSIONAL

15) WASTE MATERIALS SHALL NOT BE DISCHARGED TO WATERS OF THE STATE, EXCEPT AS AUTHORIZED BY A SECTION 404

16) OWNER TO VERIFY ALL WASTE DISPOSAL, SANITARY SEWER, AND SEPTIC TANK REGULATIONS FOR REMOVAL AND REMEDIATION HAVE BEEN IMPLEMENTED

THAN 14 DAYS SHALL BE STABILIZED WITH TEMPORARY 18) ANY DISTURBED AREA REMAINING IDLE FOR 30 DAYS SHALL BE

17) ANY DISTURBED AREA LEFT EXPOSED FOR A PERIOD GREATER

STABILIZED WITH PERMANENT VEGETATION. 19) EROSION AND SEDIMENT CONTROL MEASURES SHALL BE INSPECTED AT LEAST WEEKLY, AFTER EACH RAIN AND

REPAIRED AS NECESSARY. 20) ADDITIONAL EROSION AND SEDIMENT CONTROL MEASURES SHALL BE INSTALLED IF DETERMINED NECESSARY BY ON-SITE

INSPECTION. 21) "SILT FENCE SHALL MEET THE REQUIREMENTS OF SECTION 171-TYPE C TEMPORARY SILT FENCE, OF THE GEORGIA DEPARTMENT OF TRANSPORTATION STANDARD SPECIFICATIONS, 1993 EDITION"

22) THE PROPERTY OWNER AND CONTRACTOR ARE EQUALLY RESPONSIBLE FOR ALL EROSION CONTROL ACTIVITIES.

23) IT IS THE RESPONSIBILITY OF THE CONTRACTOR TO OBTAIN QUALIFIED PROFESSIONAL ADVICE WHEN QUESTIONS ARISE CONCERNING DESIGN AND EFFECTIVENESS OF EROSION CONTROL MEASURES, NOT THE CITY OF ATLANTA.

24) ALL TEMPORARY AND PERMANENT SEEDING SHALL BE PERFORMED IN THE APPROPRIATE SEASON. IN SUCH INSTANCES WHERE THE ESTABLISHED VEGETATION IS INOPPORTUNE DUE TO SEASON OR DROUGHT, DISTURBED AREAS SHALL BE STABILIZED USING 2"-4" OF MULCH (DS1) ADDITIONAL PLANTS IN WILL BE NECESSARY IF A SUFFICIENT STAND OF GRASS FAILS TO GROW.

25) THE CITY INSPECTOR OR DESIGNEE WILL VERIFY ADEQUATE GROUND COVER (100% COVER, 70% DENSITY) OF PERMANENT VEGETATION (DS3, DS4).

Corporate Square Owner LLC

DB 25660, PG 754

Tax ID: 18 156 11 011

Ud

-PROVIDE CONSTRUCTION EXIT

LOCATION: 33.833588, -84.333480

BE INSTALLED PRIOR TO ANY OTHER CONSTRUCTION.

BW:855.20

BW:856.00

26) SILT FENCES SHALL NOT BE PLACED IN STREAM BUFFER LIMITS OR FLOOD PLAIN LIMITS UNLESS UTILIZED FOR THE CONSTRUCTION OF AN EXEMPT ACTIVITY (EG ROADWAY DRAINAGE STRUCTURES, SEWER/WATER UTILITY CROSSINGS, ETC) AS PER THE APPROVED PLANS. FOR SUCH DISTURBANCES WITHIN THE UNDISTURBED BUFFER LIMITS, THE BUFFER SHALL BE IMMEDIATELY STABILIZED WITH MATTING AND BLANKETS ONCE THE CONSTRUCTION ACTIVITY IS COMPLETE.

27) FOR EACH SITE ON WHICH LAND DISTURBING ACTIVITY OCCURS. EACH ENTITY OR PERSON ACTING AS EITHER A PRIMARY. SECONDARY OR TERTIARY PERMITTEE, AS DEFINED IN THE STATE GENERAL PERMIT, SHALL HAVE AS A MINIMUM ONE PERSON WHO IS IN RESPONSIBLE CHARGE OF EROSION AND SEDIMENTATION CONTROL ACTIVITIES ON BEHALF OF SAID ENTITY OR PERSON AND MEETS THE APPLICABLE (LEVEL 1A) EDUCATION OR TRAINING CERTIFICATION REQUIREMENTS (0.C.G.A. 12-7-19 (A)(2)). 28)SUBCONTRACTORS INVOLVED WITH LAND DISTURBANCE ACTIVITIES SHALL MEET THE EDUCATION REQUIREMENTS (LEVEL 1) DESCRIBED IN O.C.G.A.

28) SD1-NS SEDIMENT BARRIERS SHALL BE SILT FENCE AS PER DETAILS SHOWN ON SHEET 56-0007. CONTRACTOR MUST PRICE SILT FENCE IN BASE BID AND SHOW ADD FOR FILTER MEDIA SOCK IN AREAS THAT MAY NEED ADDITIONAL SEDIMENT BARRIERS PER FIELD CONDITIONS. USE FILTER MEDIA SOCK IN AREAS OF CRITICAL ROOT ZONES.

29) THE DESIGN PROFESSIONAL WHO PREPARED THE ES&PC PLAN IS TO INSPECT THE INSTALLATION OF THEINITIAL SEDIMENT STORAGE REQUIREMENTS, PERIMETER CONTROL BMPS, AND SEDIMENT BASINS WITHIN 7 DAYS AFTER INSTALLATION.

30)NON-EXEMPT ACTIVITIES SHALL NOT BE CONDUCTED WITHIN THE 25 OR 50-FOOT UNDISTURBED STREAM BUFFERS AS MEASURED FROM THE POINT OF WRESTED VEGETATION OR WITHIN 25-FEET OF THE COASTAL MARSHLAND BUFFER AS MEASURED FROM THE JURISDICTIONAL DETERMINATION LINE WITHOUT FIRST ACQUIRING THE NECESSARY VARIANCES AND PERMITS.

SEDIMENT STORAGE IN THE LINEAR PROJECT IS ACCOMPLISHED WITH THE USE OF TYPE NS SILT FENCE INSTALLED ALONG THE DOWNHILL SIDE OF THE ENTIRE DISTURBED LENGTH. NO DISCHARGE FROM PROJECT FLOWS DIRECTLY TOWARD STREAM BUFFER/STATE WATERS

SEDIMENT STORAGE REQUIRED: 134 CU. YD./ACRE $134 \times 0.7 = 94$ CU. YD. STORAGE

TYPE NS FENCE WILL STORE SEIMENT = 1 ACRE / 100 L.F. (SOURCE: US EPA, AND GSWCC 2016 EDITION, PAGE 6-137) 0.7 ACRE $/ \frac{1}{4}$ ACRE = 2.8

 2.8×100 L.F. FENCE = 280 L.F. REQUIRED

≫861.90

****-861.90

TW:861.85

BW:861.4 END WALL #1

`_TW:862.35

BEGIN RAMP

BW:860.1

\862.3


Ud

NO NPDES MONITORING TO

OCCUR FOR THIS PROJECT

3,382 L.F. OF SILT FENCE PROVIDED

INSTALLATION OF A SEDIMENT BASIN IS NOT FEASIBLE FOR THIS PROJECT. THE CORRIDOR IS VERY NARROW, AND THERE IS NOT AN OPPORTUNITY TO INSTALL SEDIMENT BASINS ALONG THE ROUTE WITHOUT CHANNELIZING AREAS THAT WOULD OTHERWISE

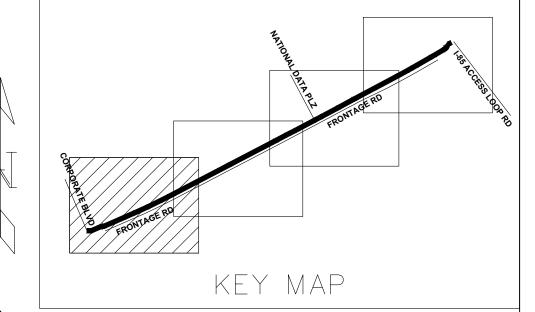

TOP=864.45 INV IN=859.30 BW:868.00 `_TW:868.15 SBW:867.15 ∕BEGIN WALL #2 SEE NOTE 28

> SOIL CLASSIFICTION LEGEND URBAN LAND

EXISTING SOIL NOTE: ALL LAND WITHIN THE PROJECT CORRIDOR IS CLASSIFIED AS "URBAN AND" (Ud) BY THE UNITED STATES DEPARTMENT. OF ARGICULTURE'S NATURAL RESOURCES CONSERVATION SERVICES

EROSION, SEDIMENTATION AND POLLUTION CONTROL PLAN

1 certify that the permittee's Erosion, Sedimentation and Pollution Control Plan provides for an appropriate and comprehensive system of best management practices required by the Georgia Water Quality Control Act and the document Manual for Erosion and Sediment Control in Georgia" (Manual) published by the Georgia Soil and Water Conservation Commission as of January 1 of the year in which the land-disturbing activity was permitted, provides for the sampling of the receiving water(s) or the sampling of the storm water outfalls and that the designed system of best management practices and sampling methods is expected to meet the requirements contained in the General NPDES Permit No. GAR

Charle M. allety FOR THE FIRM - KAIZEN COLLABORATIVE CHARLES M. ABBOTT JR.

GSWCC LEVEL II #0000041686

'I certify under penalty of law that this Plan was prepared after a site visit to the locations described herein by myself or my authorized agent, under my supervision." The Plan shall include, as a minimum, best management practices, including sound conservation and engineering practices to prevent and minimize erosion and resultant sedimentation, which are consistent with, and no less stringent than, those practices contained in the 'Manual for Erosion and Sediment Control in Georgia" (Manual) published by the Georgia Soil and Water Conservation Commission as of January 1 of the year in which the land disturbing activity was permitted and O.C.G.A. 12—7—6, as well as the following:

Charle M. allett <u>01-11-2021</u> FOR THE FIRM - KAIZEN COLLABORATIVE CHARLES M. ABBOTT JR. GSWCC LEVEL II #0000041686

"I certify under penalty of law that this document and all attachments were prepared under my direction or supervision in accordance with a system designed o assure that certified personnel properly gather and evaluate the information submitted. Based on my inquiry of the person or persons who manage the system, or those persons directly responsible for gathering the information, the information submitted is, to the best of my knowledge and belief, true, accurate, and complete. I am aware that there are significant penalties for submitting false information, including the possibility of fine and imprisonment for knowing violations."

Charle M. allety 01-11-2021 FOR THE FIRM - KAIZEN COLLABORATIVE CHARLES M. ABBOTT JR. GSWCC LEVEL II #0000041686

PRE-CONSTRUCTION RUNOFF COEFFICIENT: 0..6 POST-CONSTRUCTION RUNOFF COEFFICIENT: 0.8 SEE SOIL DATA CHART ON SHEET N/A

TOTAL ACREAGE = 0.7 AC

DISTURBED ACREAGE = 0.7

Charles M Abbott

ISSUED: 04/13/2019 EXPIRES: 04/13/2022

LEGENL

CONSTRUCTION

EXIT

-X- SEDIMENT

DISTURBED AREA

DISTURBED AREA

DISTURBED AREA

DUST CONTROL

STABILIZATION WITH PERMANENT SEEDING

STABILIZATION WITH

TEMPORARY SEEDING

MULCH

STABILIZATION WITH

BARRIER

INLET SEDIMENT TRAP "PIGS IN A BLANKET" CMU

BLOCKS OR

FILTER SOCK

CERTIFICATION NUMBER _

Level II Certified Design Professional

RECEIVING WATER: PEACHTREE CREEK NORTH AREA OF WETLANDS: 0.0 Ac.



24HR. CONTACT

DONALD SHERRILL

O: 404-637-0682 C: 404-991-4763

DON.SHERRILL@BROOKHAVENGA.GOV

BEGINNING OF BROOKHAVEN M.U.P

LOCATION: 33.833533, -84.333678

No. 31674

KAIZENCOLLABORATIVE 2390 Main Street | Tucker, GA 30084 | 404.239.2521

6) OWNER AGREES TO PROVIDE AND MAINTAIN OFF-STREET PARKING ON THE SUBJECT

-R/W IS NORTHERN LIMITS OF

DISTURBANCE. CONTRACTOR TO PLACE

BEHIND CURB ALONG FRONTAGE ROAD,

AREAS, SILT FENCE TO BE PLACED

TYP. EXISTING CURB TO REMAIN

(Sd1-NS) SEE NOTE 28

8

SILT FENCE AT R/W EXCEPT FOR PAVED

/BW:856.15

EXISTING CURB TO REMAIN. UNLESS

OTHERWISE NOTED. LIMITS OF

DISTURBANCE IS SET AT B.O.C


SEE NOTE 28


CHARLES M. ABBOTT JR, P.E. DESIGN ENGINEER LEVEL II CERTIFICATION GSWCC # 0000041686 EXPIRES: 04/13/2022 CHUCK.ABBOTT@KAIZENCOLLABORATIVE.COM T: 404-239-2521

CITY OF BROOKHAVEN DONALD SHERRILL - PUBLIC WORKS DEPUTY DIRECTOR 4362 PEACHTREE RD., BROOKHAVEN, GA 30319

(IN FEET)

1" = 20'

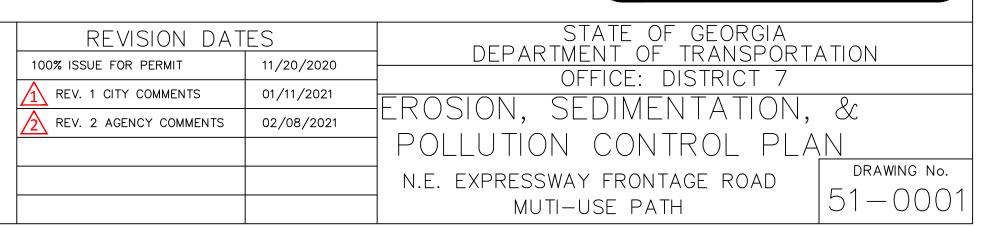

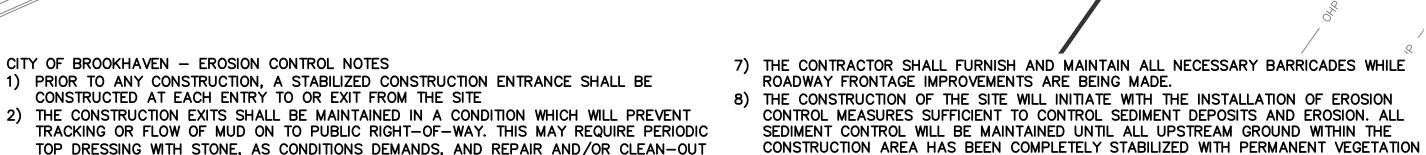

TOP DRESSING WITH STONE, AS CONDITIONS DEMANDS, AND REPAIR AND/OR CLEAN-OUT OF ANY STRUCTURE USED TO TRAP SEDIMENT. ALL MATERIALS SPILLED, DROPPED, AND ALL ROADS/DRIVEWAYS HAVE BEEN PAVED. 9) IF FULL IMPLEMENTATION OF THE APPROVED PLAN DOES NOT PROVIDE FOR EFFECTIVE WASHED, OR TRACKED FROM VEHICLES ONTO PUBLIC ROADWAY(S) OR INTO STORM DRAIN EROSION CONTROL, ADDITIONAL EROSION AND SEDIMENTATION CONTROL MEASURES SHALL MUST BE REMOVED IMMEDIATELY. THE CONTRACTOR SHALL INSPECT CONTROL MEASURES AT THE END OF EACH WORK DAY TO ENSURE MEASURES ARE FUNCTIONING PROPERLY BE IMPLEMENTED TO CONTROL OR TREAT THE SEDIMENT SOURCE AS NECESSARY. 3) CONTRACTOR TO PROVIDE GPS COORDINATES AT CONSTRUCTION EXIT(S) AS REQUIRED ON 10) IF CONCRETE WORK IS DONE ON SITE THEN A CONCRETE WASHDOWN BMP SHALL BE

THE NOTICE OF INTENT UNDER THE NPDES APPLICATION. PROVIDED OR A NOTE "CONCRETE WASHDOWN IS NOT ALLOWED ON SITE" PLACED AT 4) PRIOR TO COMMENCING LAND DISTURBANCE ACTIVITY, THE LIMITS OF LAND DISTURBANCE EACH CONSTRUCTION ENTRANCE. THE CONCRETE WASHDOWN AREA, IF ALLOWED, SHALL SHALL BE CLEARLY AND ACCURATELY DEMARCATED WITH STAKES, RIBBONS, OR OTHER BE FOR THE TOOLS, CONCRETE MIXER CHUTES, HOPPER AND THE REAR OF VEHICLES. APPROPRIATE MEANS. THE LOCATION AND EXTENT OF ALL AUTHORIZED LAND WASHOUT OF THE DRUM AT THE CONSTRUCTION SITE IS PROHIBITED. DISTURBANCE SHALL OCCUR WITHIN THE APPROVED LIMITS INDICATED ON THE APPROVED 11) FAILURE TO INSTALL, OPERATE OR MAINTAIN ALL EROSION CONTROL MEASURES WILL

RESULT IN ALL CONSTRUCTION BEING STOPPED ON THE JOB SITE UNTIL SUCH MEASURES 5) IMMEDIATELY AFTER THE ESTABLISHMENT OF CONSTRUCTION ENTRANCES/EXITS, ALL ARE CORRECTED CONSISTENT WITH THE CITY OF BROOKHAVEN EROSION CONTROL PERIMETER EROSION CONTROL DEVICES AND STORM WATER MANAGEMENT DEVICES SHALL ORDINANCE.

12) A COPY OF THE APPROVED LAND DISTURBANCE PLAN AND PERMIT SHALL BE PRESENT ON THE SITE WHENEVER LAND DISTURBANCE ACTIVITY IS IN PROGRESS 13) ALL SEWER EASEMENTS DISTURBED MUST BE DRESSED AND GRASSED TO CONTROL EROSION.

PROPERTY DURING THE ENTIRE CONSTRUCTION PERIOD. PLANS PREPARED BY:

E: DON.SHERRILL@BROOKHAVENGA.GOV O: 404-991-4763 C: 404-637-0682

KEY MAP

PROJECT NUMBER 2020-205

EROSION CONTROL NOTES 1) EROSION CONTROL MEASURES WILL BE MAINTAINED AT ALL TIMES. IF FULL IMPLEMENTATION OF THE APPROVED PLAN DOES NOT PROVIDE FOR EFFECTIVE EROSION CONTROL, ADDITIONAL EROSION AND SEDIMENT CONTROL MEASURES SHALL BE IMPLEMENTED TO CONTROL OR TREAT THE SEDIMENT SOURCE.

) ALL BMPS WILL BE INSPECTED DAILY AND ANY DIFICIENCIES NOTED WILL BE CORRECTED BY THE END OF EACH DAY. ADDITIONAL BMPS WILL BE INSTALLED IF DEEMED NECESSARY BY ON-SITE INSPECTION.

3) ALL DISTURBED AREAS MUST BE SEEDED, FERTILIZED, AND MULCHED AS SOON AS CONSTRUCTION PHASE PERMIT. ALSO, THESE DISTURBED AREAS MUST BE PROTECTED UNTIL PERMANENT VEGETATION IS ESTABLISHED

4) THE ESCAPE OF SEDIMENT FROM THE SITE SHALL BE PREVENTED BY THE INSTALLATION OF EROSION AND SEDIMENT CONTROL MEASURES AND PRACTICES PRIOR TO LAND-DISTURBING ACTIVITIES.

ALL UNSURFACED AREAS DISTURBED BY GRADING OPERATIONS SHALL RECEIVE FOUR (4) INCHES OF TOPSOIL. CONTRACTOR SHALL APPLY STABILIZATION FABRIC TO ALL SLOPES THAT ARE 10' OR GREATER IN HEIGHT & SLOPE OF 3H:1V OR GREATER AS NECESSARY TO RETAIN TOPSOIL. CONTRACTOR SHALL MAINTAIN BEST MANAGEMENT PRACTICES ON DISTURBED SLOPES IN ACCORDANCE WITH THE MANUAL FOR EROSION AND SEDIMENT CONTROL IN GEORGIA UNTIL A HEALTHY STAND OF GRASS IS MAINTAINED OVER MORE THAN 70% OF THE DISTURBED AREA AND TO THE SATISFACTION OF THE OWNER.

S) IT IS THE RESPONSIBILITY OF THE CONTRACTOR TO CLEAN OUT ALL EXISTING AND PROPOSED INLETS, PIPES, AND MANHOLES OF DEBRIS AND SEDIMENT AT COMPLETION OF THE SITE WORK IN CONFORMANCE WITH ALL STATE AND LOCAL SPECIFICATIONS, AND TO THE SATISFACTION OF THE OWNER.

) SILT FENCE SHALL MEET THE REQUIREMENTS OF SECTION 171, "SILT FENCE" OF THE STATE OF GEORGIA DEPARTMENT OF TRANSPORTATION STANDARD SPECIFICATIONS, AND MEET SPECIFICATIONS FOR TYPE "C" SILT FENCE IN THE "MANUAL FOR EROSION AND SEDIMENT CONTROL IN GEORGIA", AND SHALL BE WIRE REINFORCED AS REQUIRED BY THESE SPECIFICATIONS. A DOUBLE ROW MUST BE INSTALLED BETWEEN LAND DISTURBING ACTIVITIES AND STATE WATERS.

B) ALL EARTHWORK OPERATIONS SHOULD BE SCHEDULED IN A MANNER TO MAINTAIN PROPER ROUTING OF STORM WATER THROUGH SEDIMENT CONTROL DEVICES. IF IT IS NECESSARY TO PERFORM CONSTRUCTION ACTIVITIES IN AN ORDER THAT IS NOT IN ACCORDANCE WITH THE ACTIVITY SCHEDULE ON THIS PLAN, OR THE CONSTRUCTION SCHEDULE WILL ALLOW FOR DISTURBED AREAS TO BYPASS BEST MANAGEMENT PRACTICES, THE CONTRACTOR IS TO CONTACT THE ENGINEER PRIOR TO COMMENCEMENT OF SUCH ACTIVITIES AND IMPLEMENT EROSION CONTROL DEVICES THAT WILL CONTROL SEDIMENT, AT THE SATISFACTION OF THE ENGINEER AND IN ACCORDANCE WITH THE MANUAL FOR EROSION AND SEDIMENT CONTROL IN

) DETENTION FACILITIES AND EROSION CONTROL MEASURES ARE TO BE ACCOMPLISHED PRIOR TO ANY OTHER CONSTRUCTION ON THE SITE AND MAINTAINED UNTIL PERMANENT GROUND COVER IS ESTABLISHED.

0) LENGTH OF RIPRAP SHALL BE 6 TIMES THE DIAMETER OF THE STORMWATER OUTLET PIPE AT A MINIMUM.

868.80

868.70

`868.60-

1) FILE NOTICE OF INTENT AND NOTICE OF TERMINATION WITH GA EPD IF REQUIRED.

TW:870.Ó-

BW:868.5

END WALL #2

12) NO CONCRETE VEHICLE WASHDOWN OR UNPROTECTED STORAGE OF PETROLEUM PRODUCTS IS ALLOWED ON SITE.

13) STORMWATER POLLUTANTS ARE DECREASED ON THIS SITE WITH THE INSTALLATION OF SEDIMENT BARRIERS AND PERMANENT VEGETATIVE COVER. THE VEGETATIVE COVER WILL REMAIN AS A PERMANENT GROUND STABILIZATION MEASURE. 14) AMENDMENTS/REVISIONS TO THE ES&PC PLAN WHICH HAVE A

SIGNIFICANT EFFECT ON BMPs WITH A HYDRAULIC COMPONENT MUST BE CERTIFIED BY THE DESIGN PROFESSIONAL. 15) WASTE MATERIALS SHALL NOT BE DISCHARGED TO WATERS OF THE STATE, EXCEPT AS AUTHORIZED BY A SECTION 404

16) OWNER TO VERIFY ALL WASTE DISPOSAL, SANITARY SEWER, AND SEPTIC TANK REGULATIONS FOR REMOVAL AND REMEDIATION HAVE BEEN IMPLEMENTED

17) ANY DISTURBED AREA LEFT EXPOSED FOR A PERIOD GREATER THAN 14 DAYS SHALL BE STABILIZED WITH TEMPORARY

18) ANY DISTURBED AREA REMAINING IDLE FOR 30 DAYS SHALL BE STABILIZED WITH PERMANENT VEGETATION.

19) EROSION AND SEDIMENT CONTROL MEASURES SHALL BE INSPECTED AT LEAST WEEKLY, AFTER EACH RAIN AND REPAIRED AS NECESSARY.

20) ADDITIONAL EROSION AND SEDIMENT CONTROL MEASURES SHALL BE INSTALLED IF DETERMINED NECESSARY BY ON-SITE INSPECTION.

21) "SILT FENCE SHALL MEET THE REQUIREMENTS OF SECTION 171-TYPE C TEMPORARY SILT FENCE. OF THE GEORGIA DEPARTMENT OF TRANSPORTATION STANDARD SPECIFICATIONS, 1993 EDITION"

22) THE PROPERTY OWNER AND CONTRACTOR ARE EQUALLY RESPONSIBLE FOR ALL EROSION CONTROL ACTIVITIES.

23) IT IS THE RESPONSIBILITY OF THE CONTRACTOR TO OBTAIN QUALIFIED PROFESSIONAL ADVICE WHEN QUESTIONS ARISE CONCERNING DESIGN AND EFFECTIVENESS OF EROSION CONTROL MEASURES, NOT THE CITY OF ATLANTA.

24) ALL TEMPORARY AND PERMANENT SEEDING SHALL BE PERFORMED IN THE APPROPRIATE SEASON. IN SUCH INSTANCES WHERE THE ESTABLISHED VEGETATION IS INOPPORTUNE DUE TO SEASON OR DROUGHT, DISTURBED AREAS SHALL BE STABILIZED USING 2"-4" OF MULCH (DS1). ADDITIONAL PLANTS IN WILL BE NECESSARY IF A SUFFICIENT STAND OF GRASS FAILS TO GROW.

25) THE CITY INSPECTOR OR DESIGNEE WILL VERIFY ADEQUATE GROUND COVER (100% COVER, 70% DENSITY) OF PERMANENT VEGETATION (DS3, DS4).

BW:874.0

SEE NOTÉ 28

TW:874.0~

TW:872.00 / BW:870.00


-TW:871.2 BW:869.2 BEGIN WALL #3 26) SILT FENCES SHALL NOT BE PLACED IN STREAM BUFFER LIMITS OR FLOOD PLAIN LIMITS UNLESS UTILIZED FOR THE CONSTRUCTION OF AN EXEMPT ACTIVITY (EG ROADWAY DRAINAGE STRUCTURES, SEWER/WATER UTILITY CROSSINGS, ETC) AS PER THE APPROVED PLANS. FOR SUCH DISTURBANCES WITHIN THE UNDISTURBED BUFFER LIMITS, THE BUFFER SHALL BE IMMEDIATELY STABILIZED WITH MATTING AND BLANKETS ONCE THE CONSTRUCTION ACTIVITY IS COMPLETE.

27) FOR EACH SITE ON WHICH LAND DISTURBING ACTIVITY OCCURS. EACH ENTITY OR PERSON ACTING AS EITHER A PRIMARY, SECONDARY OR TERTIARY PERMITTEE, AS DEFINED IN THE STATE GENERAL PERMIT, SHALL HAVE AS A MINIMUM ONE PERSON WHO IS IN RESPONSIBLE CHARGE OF EROSION AND SEDIMENTATION CONTROL ACTIVITIES ON BEHALF OF SAID ENTITY OR PERSON AND MEETS THE APPLICABLE (LEVEL 1A) EDUCATION OR TRAINING CERTIFICATION REQUIREMENTS (0.C.G.A. 12-7-19 (A)(2)). 28)SUBCONTRACTORS INVOLVED WITH LAND DISTURBANCE ACTIVITIES SHALL MEET THE EDUCATION REQUIREMENTS (LEVEL 1) DESCRIBED IN O.C.G.A. 12 - 7 - 19.

28) SD1-NS SEDIMENT BARRIERS SHALL BE SILT FENCE AS PER DETAILS SHOWN ON SHEET 56-0007. CONTRACTOR MUST PRICE SILT FENCE IN BASE BID AND SHOW ADD FOR FILTER MEDIA SOCK IN AREAS THAT MAY NEED ADDITIONAL SEDIMENT BARRIERS PER FIELD CONDITIONS. USE FILTER MEDIA SOCK IN AREAS OF CRITICAL ROOT ZONES.

29) THE DESIGN PROFESSIONAL WHO PREPARED THE ES&PC PLAN IS TO INSPECT THE INSTALLATION OF THEINITIAL SEDIMENT STORAGE REQUIREMENTS, PERIMETER CONTROL BMPS, AND SEDIMENT BASINS WITHIN 7 DAYS AFTER INSTALLATION. 30) NON-EXEMPT ACTIVITIES SHALL NOT BE CONDUCTED WITHIN THE 25 OR 50-FOOT UNDISTURBED STREAM BUFFERS AS

MEASURED FROM THE POINT OF WRESTED VEGETATION OR WITHIN 25-FEET OF THE COASTAL MARSHLAND BUFFER AS MEASURED FROM THE JURISDICTIONAL DETERMINATION LINE WITHOUT FIRST ACQUIRING THE NECESSARY VARIANCES AND PERMITS.

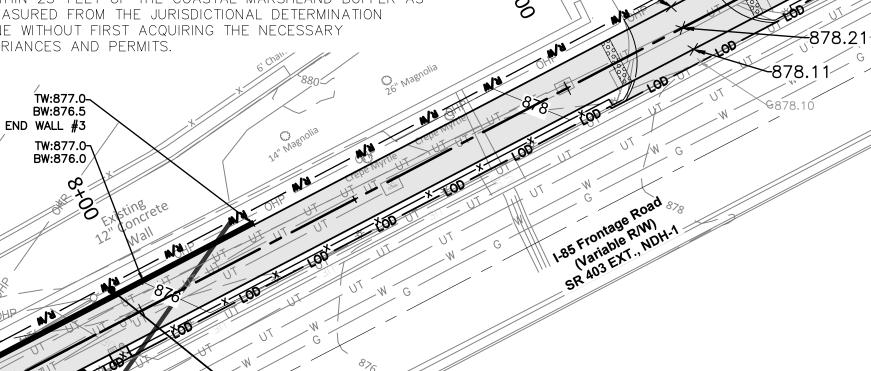

`878.31

TOP=874.40

EXISTING CURB TO REMAIN. UNLESS

OTHERWISE NOTED. LIMITS OF

DISTURBANCE IS SET AT B.O.C

-R/W IS NORTHERN LIMITS OF DISTURBANCE. CONTRACTOR TO PLACE SILT FENCE AT R/W EXCEPT FOR PAVED AREAS, SILT FENCE TO BE PLACED BEHIND CURB ALONG FRONTAGE ROAD, TYP. EXISTING CURB TO REMAIN

Sd1-NS SEE NOTE 28

CITY OF BROOKHAVEN - EROSION CONTROL NOTES 1) PRIOR TO ANY CONSTRUCTION, A STABILIZED CONSTRUCTION ENTRANCE SHALL BE CONSTRUCTED AT

Ud

24" Magnolia Twin 🔘

EACH ENTRY TO OR EXIT FROM THE SITE 2) THE CONSTRUCTION EXITS SHALL BE MAINTAINED IN A CONDITION WHICH WILL PREVENT TRACKING OR FLOW OF MUD ON TO PUBLIC RIGHT-OF-WAY. THIS MAY REQUIRE PERIODIC TOP DRESSING WITH STONE. AS CONDITIONS DEMANDS, AND REPAIR AND/OR CLEAN-OUT OF ANY STRUCTURE USED TO TRAP SEDIMENT. ALL MATERIALS SPILLED, DROPPED, WASHED, OR TRACKED FROM VEHICLES ONTO PUBLIC ROADWAY(S) OR INTO STORM DRAIN MUST BE REMOVED IMMEDIATELY. THE CONTRACTOR SHALL INSPECT CONTROL MEASURES AT THE END OF EACH WORK DAY TO ENSURE MEASURES ARE FUNCTIONING

3) CONTRACTOR TO PROVIDE GPS COORDINATES AT INTENT UNDER THE NPDES APPLICATION.

4) PRIOR TO COMMENCING LAND DISTURBANCE ACTIVITY, THE LIMITS OF LAND DISTURBANCE SHALL BE CLEARLY AND ACCURATELY DEMARCATED WITH STAKES, RIBBONS, OR OTHER APPROPRIATE MEANS. THE LOCATION AND EXTENT 12) A COPY OF THE APPROVED LAND DISTURBANCE PLAN OF ALL AUTHORIZED LAND DISTURBANCE SHALL OCCUR WITHIN THE APPROVED LIMITS INDICATED ON THE APPROVED PLANS

5) IMMEDIATELY AFTER THE ESTABLISHMENT OF CONSTRUCTION ENTRANCES/EXITS, ALL PERIMETER EROSION CONTROL DEVICES AND STORM WATER MANAGEMENT DEVICES SHALL BE INSTALLED PRIOR TO ANY OTHER CONSTRUCTION.

6) OWNER AGREES TO PROVIDE AND MAINTAIN OFF-STREET PARKING ON THE SUBJECT PROPERTY DURING THE ENTIRE CONSTRUCTION PERIOD. 7) THE CONTRACTOR SHALL FURNISH AND MAINTAIN ALL

NECESSARY BARRICADES WHILE ROADWAY FRONTAGE

IMPROVEMENTS ARE BEING MADE. 8) THE CONSTRUCTION OF THE SITE WILL INITIATE WITH THE INSTALLATION OF EROSION CONTROL MEASURES SUFFICIENT TO CONTROL SEDIMENT DEPOSITS AND EROSION. ALL SEDIMENT CONTROL WILL BE MAINTAINED

UNTIL ALL UPSTREAM GROUND WITHIN THE CONSTRUCTION AREA HAS BEEN COMPLETELY STABILIZED WITH PERMANENT VEGETATION AND ALL ROADS/DRIVEWAYS HAVE BEEN PAVED.

SEE NOTÉ 28

IF FULL IMPLEMENTATION OF THE APPROVED PLAN DOES NOT PROVIDE FOR EFFECTIVE EROSION CONTROL. ADDITIONAL EROSION AND SEDIMENTATION CONTROL MEASURES SHALL BE IMPLEMENTED TO CONTROL OR TREAT THE SEDIMENT SOURCE AS NECESSARY. 10) IF CONCRETE WORK IS DONE ON SITE THEN A CONCRETE WASHDOWN BMP SHALL BE PROVIDED OR A NOTE "CONCRETE WASHDOWN IS NOT ALLOWED ON SITE" PLACED AT EACH CONSTRUCTION ENTRANCE. THE CONCRETE WASHDOWN AREA, IF ALLOWED, SHALL BE FOR THE TOOLS, CONCRETE MIXER CHUTES, HOPPER AND THE REAR OF VEHICLES. WASHOUT OF THE DRUM AT THE

CONSTRUCTION EXIT(S) AS REQUIRED ON THE NOTICE OF 11) FAILURE TO INSTALL, OPERATE OR MAINTAIN ALL EROSION CONTROL MEASURES WILL RESULT IN ALL CONSTRUCTION BEING STOPPED ON THE JOB SITE UNTIL SUCH MEASURES ARE CORRECTED CONSISTENT WITH THE CITY OF

> AND PERMIT SHALL BE PRESENT ON THE SITE WHENEVER LAND DISTURBANCE ACTIVITY IS IN PROGRESS 13) ALL SEWER EASEMENTS DISTURBED MUST BE DRESSED

> > 24HR. CONTACT DONALD SHERRILL O: 404-637-0682 C: 404-991-4763 DON.SHERRILL@BROOKHAVENGA.GOV

Ds1

CONSTRUCTION

SEDIMENT

BARRIER

INLET SEDIMEN

TRAP "PIGS IN A

BLANKET" CMU

BLOCKS OR

DISTURBED AREA

DISTURBED AREA

DISTURBED AREA

DUST CONTROL

STABILIZATION WITH

TEMPORARY SEEDING

STABILIZATION WITH

PERMANENT SEEDING

MULCH

STABILIZATION WITH

FILTER SOCK

CONSTRUCTION SITE IS PROHIBITED.

BROOKHAVEN EROSION CONTROL ORDINANCE.


AND GRASSED TO CONTROL EROSION.



EXISTING SOIL NOTE: ALL LAND WITHIN THE PROJECT CORRIDOR IS CLASSIFIED AS "URBAN AND" (Ud) BY THE UNITED STATES DEPARTMENT OF ARGICULTURE'S NATURAL RESOURCES CONSERVATION SERVICES

TOTAL ACREAGE = 0.7 AC DISTURBED ACREAGE = 0.7




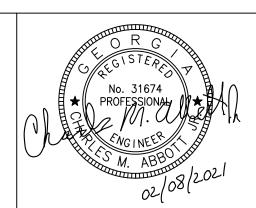

PLANS PREPARED BY: KAIZENCOLLABORATIVE 2390 Main Street | Tucker, GA 30084 | 404.239.2521

CHARLES M. ABBOTT JR, P.E. DESIGN ENGINEER LEVEL II CERTIFICATION GSWCC # 0000041686 EXPIRES: 04/13/2022 CHUCK.ABBOTT@KAIZENCOLLABORATIVE.COM T: 404-239-2521

CITY OF BROOKHAVEN DONALD SHERRILL - PUBLIC WORKS DEPUTY DIRECTOR 4362 PEACHTREE RD., BROOKHAVEN, GA 30319 E: DON.SHERRILL@BROOKHAVENGA.GOV O: 404-991-4763 C: 404-637-0682

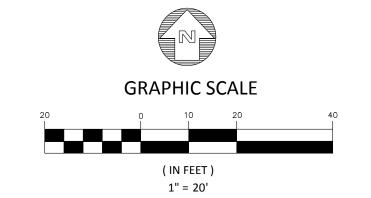

NO NPDES MONITORING TO

OCCUR FOR THIS PROJECT

STATE OF GEORGIA REVISION DATES DEPARTMENT OF TRANSPORTATION 100% ISSUE FOR PERMIT 11/20/2020 OFFICE: DISTRICT 7 REV. 1 CITY COMMENTS SEDIMENTATION, & REV. 2 AGENCY COMMENTS 02/08/2021 POLLUTION CONTROL PLAN DRAWING No. N.E. EXPRESSWAY FRONTAGE ROAD MUTI-USE PATH

OTHERWISE NOTED. LIMITS OF DISTURBANCE IS SET AT B.O.C

Ds2 Ds3

∽R/W IS NORTHERN LIMITS OF DISTURBANCE. CONTRACTOR TO PLACE SILT FENCE AT R/W EXCEPT FOR PAVED AREAS. SILT FENCE TO BE PLACED BEHIND CURB ALONG FRONTAGE ROAD, TYP. EXISTING CURB TO REMAIN

Sd1-NS SEE NOTE 28

WITHIN THE APPROVED LIMITS INDICATED ON THE APPROVED PLANS

5) IMMEDIATELY AFTER THE ESTABLISHMENT OF CONSTRUCTION ENTRANCES/EXITS, ALL PERIMETER EROSION CONTROL DEVICES AND STORM WATER MANAGEMENT DEVICES SHALL BE INSTALLED PRIOR TO ANY OTHER CONSTRUCTION. 6) OWNER AGREES TO PROVIDE AND MAINTAIN OFF-STREET

PARKING ON THE SUBJECT PROPERTY DURING THE ENTIRE CONSTRUCTION PERIOD. 7) THE CONTRACTOR SHALL FURNISH AND MAINTAIN ALL

NECESSARY BARRICADES WHILE ROADWAY FRONTAGE IMPROVEMENTS ARE BEING MADE.

8) THE CONSTRUCTION OF THE SITE WILL INITIATE WITH THE INSTALLATION OF EROSION CONTROL MEASURES SUFFICIENT TO CONTROL SEDIMENT DEPOSITS AND EROSION. ALL SEDIMENT CONTROL WILL BE MAINTAINED

NO NPDES MONITORING TO OCCUR FOR THIS PROJECT

13) ALL SEWER EASEMENTS DISTURBED MUST BE DRESSED AND GRASSED TO CONTROL EROSION.

> GSWCC Charles M Abbott

> > 24HR. CONTACT

DONALD SHERRILL

O: 404-637-0682 C: 404-991-4763

DON.SHERRILL@BROOKHAVENGA.GOV

Level II Certified Design Professional CERTIFICATION NUMBER _ ISSUED: 04/13/2019 EXPIRES: 04/13/2022

EXISTING SOIL NOTE: ALL LAND WITHIN THE PROJECT CORRIDOR IS CLASSIFIED AS "URBAN AND" (Ud) BY THE UNITED STATES DEPARTMENT OF ARGICULTURE'S NATURAL RESOURCES CONSERVATION SERVICES

DISTURBED AREA


DUST CONTROL

STABILIZATION WITH

PERMANENT SEEDING

TOTAL ACREAGE = 0.7 AC DISTURBED ACREAGE = 0.7



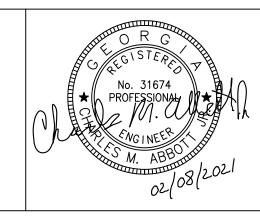


PLANS PREPARED BY: KAIZENCOLLABORATIVE 2390 Main Street | Tucker, GA 30084 | 404.239.2521

CHARLES M. ABBOTT JR, P.E. DESIGN ENGINEER LEVEL II CERTIFICATION GSWCC # 0000041686 EXPIRES: 04/13/2022 CHUCK.ABBOTT@KAIZENCOLLABORATIVE.COM T: 404-239-2521

CITY OF BROOKHAVEN DONALD SHERRILL - PUBLIC WORKS DEPUTY DIRECTOR 4362 PEACHTREE RD., BROOKHAVEN, GA 30319


E: DON.SHERRILL@BROOKHAVENGA.GOV O: 404-991-4763 C: 404-637-0682

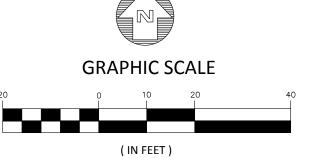

1" = 20'

STATE OF GEORGIA REVISION DATES DEPARTMENT OF TRANSPORTATION 100% ISSUE FOR PERMIT 11/20/2020 OFFICE: DISTRICT 7 REV. 1 CITY COMMENTS SEDIMENTATION, & REV. 2 AGENCY COMMENTS 02/08/2021 POLLUTION CONTROL PLAN DRAWING No. N.E. EXPRESSWAY FRONTAGE ROAD MUTI-USE PATH



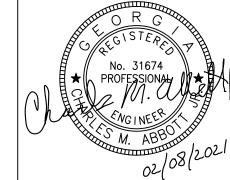

PLANS PREPARED BY: KAIZENCOLLABORATIVE 2390 Main Street | Tucker, GA 30084 | 404.239.2521

CHARLES M. ABBOTT JR, P.E. DESIGN ENGINEER LEVEL II CERTIFICATION GSWCC # 0000041686 EXPIRES: 04/13/2022 CHUCK.ABBOTT@KAIZENCOLLABORATIVE.COM

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DONALD SHERRILL - PUBLIC WORKS DEPUTY DIRECTOR 4362 PEACHTREE RD., BROOKHAVEN, GA 30319 E: DON.SHERRILL@BROOKHAVENGA.GOV

O: 404-991-4763 C: 404-637-0682 **GRAPHIC SCALE** (IN FEET)

1" = 20'

REVISION DATES 100% ISSUE FOR PERMIT 11/20/2020 REV. 1 CITY COMMENTS REV. 2 AGENCY COMMENTS 02/08/2021

STATE OF GEORGIA DEPARTMENT OF TRANSPORTATION OFFICE: DISTRICT 7 SEDIMENTATION, & DRAWING No. N.E. EXPRESSWAY FRONTAGE ROAD

MUTI-USE PATH

PROJECT NUMBER DEKALB

2020-205

EROSION, SEDIMENTATION & POLLUTION CONTROL PLAN CHECKLIST INFRASTRUCTURE CONSTRUCTION PROJECTS

SWCD: Oconee River

Project Name: 'N.E. EXPRESSWAY FRONTAGE ROAD MULTI-USE PATH City/County: BROOKHAVEN/ DEKALB COUNTY Date on Plans: <u>01-10-2021</u>

Name & email of person filling out checklist: Tanner Copeland | tanner.copeland@kaizencollaborative.com

TO BE SHOWN ON ES&PC PLAN

51-0005 1 The applicable Erosion, Sedimentation and Pollution Control Plan Checklist established by the Commission as of January 1 of the year in which the land-disturbing activity was permitted.

(The completed Checklist must be submitted with the ES&PC Plan or the Plan will not be reviewed)

51-0001-04 Y 2 Level II certification number issued by the Commission, signature and seal of the certified design professional. (Signature, seal and Level II number must be on each sheet pertaining to ES&PC Plan or the Plan will not be reviewed)

3 The name and phone number of the 24-hour local contact responsible for erosion, sedimentation and pollution controls.

4 Provide the name, address, **email address**, and phone number of primary permittee.

COVER COVER 5 Note total and disturbed acreage of the project or phase under construction.

51-0001&04 6 Provide the GPS locations of the beginning and end of the Infrastructure project. Give the Latitude and Longitude in

51-0001-04

51-0001 7 Initial date of the Plan and the dates of any revisions made to the Plan including the entity who requested the revisions.

51-0005 8 Description of the nature of construction activity.

9 Provide vicinity map showing site's relation to surrounding areas. Include designation of specific phase, if necessary. COVER

51-0001 10 Identify the project receiving waters and describe all sensitive adjacent areas including streams, lakes, residential areas, wetlands, marshlands, etc. which may be affected.

51-0001 Y 11 Design professional's certification statement and signature that the site was visited prior to development of the ES&PC Plan as stated on **Part IV page 21** of the permit.

51-0001 Y 12 Design professional's certification statement and signature that the permittee's ES&PC Plan provides for an appropriate and comprehensive system of BMPs and sampling to meet permit requirements as stated on Part IV page 20 of the permit. *

51-0001 Y 13 Design professional certification statement and signature that the permittee's ES&PC Plan provides for representative

sampling as stated on Part IV.D.6.c.(3) page 37 of the permit as applicable. * 51-0001&04 Y 14 Clearly note the statement that "The design professional who prepared the ES&PC Plan is to inspect the installation of the

initial sediment storage requirements, perimeter control BMPs, and sediment basins within 7 days after installation." in accordance with Part IV.A.5 page 26 of the permit. *

51-0001&04 Y 15 Clearly note the statement that "Non-exempt activities shall not be conducted within the 25 or 50-foot undisturbed stream buffers as measured from the point of wrested vegetation or within 25-feet of the coastal marshland buffer as measured

from the Jurisdictional Determination Line without first acquiring the necessary variances and permits."

16 Provide a description of any buffer encroachments and indicate whether a buffer variance is required. 17 Clearly note the statement that "Amendments/revisions to the ES&PC Plan which have a significant effect on BMPs with a

51-0001&04 hydraulic component must be certified by the design professional." *

51-0001&04 18 Clearly note the statement that "Waste materials shall not be discharged to waters of the State, except as authorized by a

51-0001&04 | Y 19 Clearly note statement that "The escape of sediment from the site shall be prevented by the installation of erosion and sediment control measures and practices prior to land disturbing activities."

51-0001&04 Y 20 Clearly note statement that "Erosion control measures will be maintained at all times. If full implementation of the approved Plan does not provide for effective erosion control, additional erosion and sediment control measures shall be implemented

to control or treat the sediment source."

21 Clearly note the statement "Any disturbed area left exposed for a period greater than 14 days shall be stabilized with mulch

22 Any construction activity which discharges storm water into an Impaired Stream Segment, or within 1 linear mile upstream

COVER

of and within the same watershed as, any portion of an Biota Impaired Stream Segment must comply with Part III. C. of the permit Include the completed Appendix 1 listing all the BMPs that will be used for those areas of the site which discharge

to the Impaired Stream Segment. * N/A 23 If a TMDL Implementation Plan for sediment has been finalized for the Impaired Stream Segment (identified in item 22

above) at least six months prior to submittal of NOI, the ES&PC Plan must address any site-specific conditions or requirements included in the TMDL Implementation Plan. *

24 BMPs for concrete washdown of tools, concrete mixer chutes, hoppers and the rear of the vehicles. Washout of the drum at the construction site is prohibited. *

51-0006 25 Provide BMPs for the remediation of all petroleum spills and leaks.

51-0006 26 Description of the measures that will be installed during the construction process to control pollutants in storm water that will occur after construction operations have been completed. *

27 Description of practices to provide cover for building materials and building products on site. *

28 Description of the practices that will be used to reduce the pollutants in storm water discharges. *

29 Description and chart or timeline of the intended sequence of major activities which disturb soils for the major portions of the site (i.e., initial perimeter and sediment storage BMPs, clearing and grubbing activities, excavation activities, utility

activities, temporary and final stabilization).

30 Provide complete requirements of inspections and record keeping by the primary permittee. *

31 Provide complete requirements of sampling frequency and reporting of sampling results. *

32 Provide complete details for retention of records as per Part IV.F. of the permit. *

33 Description of analytical methods to be used to collect and analyze the samples from each location. *

34 Appendix B rationale for NTU values at all outfall sampling points where applicable. *

35 Delineate all sampling locations, perennial and intermittent streams and other water bodies into which storm water is discharged also provide a summary chart of the justification and analysis for the representative sampling as applicable. *

> 36 A description of appropriate controls and measures that will be implemented at the construction site including: (1) initial sediment storage requirements and perimeter control BMPs, (2) intermediate grading and drainage BMPs, and (3) final

BMPs. For construction sites where there will be no mass grading and the initial perimeter control BMPs,

intermediate grading and drainage BMPs, and final BMPs are the same, the Plan may combine all of the BMPs into a single

37 Graphic scale and North arrow.

51-0001-04

51-0004

51-0004

51-0001

51-0001

51-0001-04

56-0007-09

51-0001-04 38 Existing and proposed contour lines with contour lines drawn at an interval in accordance with the following:

Proposed Contours 1": 400' Centerline Profile

Existing Contours USGS 1": 2000' Topographical Sheets

Commission). Please refer to the Alternative BMP Guidance Document found at www.gaswcc.org.

39 Use of alternative BMPs whose performance has been documented to be equivalent to or superior to conventional BMPs as certified by a Design Professional (unless disapproved by EPD or the Georgia Soil and Water Conservation

40 Use of alternative BMP for application to the Equivalent BMP List. Please refer to Appendix A-2 of the Manual for Erosion & Sediment Control in Georgia 2016 Edition. *

41 Delineation of the applicable 25-foot or 50-foot undisturbed buffers adjacent to State waters and any additional buffers

required by the Local Issuing Authority. Clearly note and delineate all areas of impact. 42 Delineation of on-site wetlands and all State waters located on and within 200 feet of the project site.

N/A 43 Delineation and acreage of contributing drainage basins on the project site.

51-0005 44 Delineate on-site drainage and off-site watersheds using USGS 1" :2000' topographical sheets.

45 An estimate of the runoff coefficient or peak discharge flow of the site prior to and after construction activities are

46 Storm-drain pipe and weir velocities with appropriate outlet protection to accommodate discharges without erosion.

Identify/Delineate all storm water discharge points.

USGS TOPOGRAPHIC MAP

51-0001-04 47 Soil series for the project site and their delineation.

51-0001-04 48 The limits of disturbance for each phase of construction.

> 49 Provide a minimum of 67 cubic yards of sediment storage per acre drained using a temporary sediment basin, retrofitted detention pond, and/or excavated inlet sediment traps for each common drainage location. Sediment storage volume must be in place prior to and during all land disturbance activities until final stabilization of the site has been achieved. A written justification explaining the decision to use equivalent controls when a sediment basin is not attainable must be included in the Plan for each common drainage location in which a sediment basin is not provided. A written justification as to why 67 cubic yards of storage is not attainable must also be given. Worksheets from the Manual must be included for structural BMPs and all calculations used by the design professional to obtain the required sediment storage when using equivalent controls. When discharging from sediment basins and impoundments, permittees are required to

utilize outlet structures that withdraw water from the surface, unless infeasible. If outlet structures that withdraw water from

the surface are not feasible, a written justification explaining this decision must be included in the Plan. 51-0001-04 Y 50 Location of Best Management Practices that are consistent with and no less stringent than the Manual for Erosion and

Sediment Control in Georgia. Use uniform coding symbols from the Manual, Chapter 6, with legend. 56-0007-09

51 Provide detailed drawings for all structural practices. Specifications must, at a minimum, meet the guidelines set forth in the Manual for Erosion and Sediment Control in Georgia.

52 Provide vegetative plan, noting all temporary and permanent vegetative practices. Include species, planting dates and seeding, fertilizer, lime and mulching rates. Vegetative plan shall be site specific for appropriate time of year that seeding will take place and for the appropriate geographic region of Georgia.

* If using this checklist for a project that is less than 1 acre and not part of a common development but within 200 ft of a perennial stream, the * checklist items would be N/A.

GEORGIA

Effective January 1, 2020

-SITE DOES NOT DISCHARGE

DIRECTLY TO STATE WATERS

NARRATIVE:

PROJECT DESCRIPTION:


CONSTRUCTION OF A 10' MULTI-USE PATH WITHIN THE EXISTING LANDSCAPSHOULDER OF I-85 FRONTAGE ROAD: THE PROJECT INCLUDE SIDEWALK CONSTRUCTION, (3) RETAINING WALLS, DRIVEWAY MODIFICATION, GRADING, MINOR UTILITY RELOCATION, LANDSCAPING, AND SIGNING & MARKING

THIS PROJECT WILL BE CONSTRUCTED WITHIN AN EXISTING GRASSED SHOULDER ALONG SR 403 EXT, I-85 FRONTAGE ROAD. WHICH BACKUPS TO EXISTING PARKING LOTS, A POWER STATION, AND VARYING PLACES OF BUISNESS

ADJACENT AREAS: THE SITE IS SURROUNDED BY URBAN LAND AREA BOTH COMMERCIAL AND RESIDENTIAL.

SEDIMENTATION IS CONTROLLED USING SEDIMENT TRAPS AT INLETS AND PERIMETER CONTROLS. THE TOTAL DISTURBED AREA FOR THE PROJECT IS 0.7 ACRES. EROSION CONTROL MEASURES WILL BE USED UNTIL FINAL STABILIZATION.

NO NPDES MONITORING TO OCCUR FOR THIS PROJECT

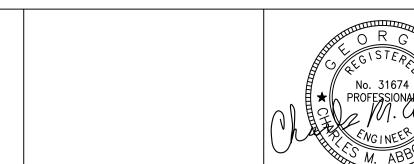

PLANS PREPARED BY: KAIZENCOLLABORATIVE Brookhaven 2390 Main Street | Tucker, GA 30084 | 404.239.2521 CHARLES M. ABBOTT JR. P.E. DESIGN ENGINEER LEVEL II CERTIFICATION


GSWCC # 0000041686 EXPIRES: 04/13/2022

CHUCK.ABBOTT@KAIZENCOLLABORATIVE.COM

T: 404-239-2521

PROJECT LOCATION

CITY OF BROOKHAVEN DONALD SHERRILL - PUBLIC WORKS DEPUTY DIRECTOR 4362 PEACHTREE RD., BROOKHAVEN, GA 30319 E: DON.SHERRILL@BROOKHAVENGA.GOV O: 404-991-4763 C: 404-637-0682

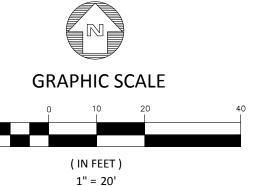

Atlanta

Montesson

International 5


SCALE: 1"=500'

DRAINAGE BASIN LIMITS FOR

DRAINAGE AREA = 0.7 AC.

NO OFFSITE DRAINAGE IS CONVEYED THROUGH SUBJECT

ALL PHASES OF CONSTRUCTION.

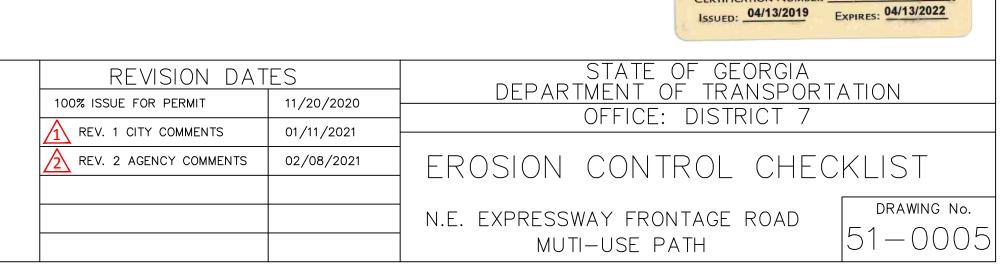

Charles M Abbott Level II Certified Design Professional

CERTIFICATION NUMBER



PROJECT NUMBER DEKALB

2020-205

MAINTENANCE AND INSPECTION PROCEDURES EROSION AND SEDIMENT CONTROL INSPECTION AND

MAINTENANCE PRACTICES

These are the inspection and maintenance practices that will be used to maintain erosion and sediment controls.

1. Less than one half of the site will be denuded at one time.

2. All control measures will be inspected at least once each

- 3. All measures will be maintained in good working order; if a repair is necessary, it will be initiated within 24 hours of
- 4. Built up sediment will be removed from silt fence when it

has reached one—third the height of the fence.

- 5. Silt fence will be inspected for depth of sediment, tears, to see if the fabric is securely attached to the fence posts, and to see that the fence posts are firmly in the ground.
- 6. The sediment basin will be inspected for depth of sediment, and built up sediment will be removed when it reaches one—third of the design capacity or at the end of the job.
- 7. Diversion dike will be inspected and any breaches promptly
- 8. Temporary and permanent seeding and planting will be inspected for bare spots, washouts, and healthy growth.
- 9. A maintenance inspection report will be made after each inspection.
- 10. The 24-hour emergency contact will select individuals who will be responsible for inspections, maintenance and repair activities, and filling out the inspection and maintenance
- 11. Personnel selected for inspection and maintenance responsibilities will receive training from the 24-hour emergency contact. They will be trained in all the inspection and sediment controls used onsite in good working order.

CONCRETE WASHDOWN BEST MANAGEMENT PRACTICES

These are the BMP's for preventing the illegal discharge or concrete washdown water into storm drains, streams or rivers.

- 1. Choose a suitable location away from storm drains, streams and rivers that is accessible to the vehicle.
- 2. Excavate a pit deep enough to contain the washdown water. 3. Vehicle should always back into the pit.
- 4. Washdown only the chute, hopper and rear of the vehicle. DO NOT wash out the drum or discharge surplus concrete into the pit.
- 5. Verify that washdown water goes into and stays the in the
- 6. Properly dispose of washdown in the pit. Fill in pit and smooth out ground.
- 7. Washout of Concrete Truck Drum is prohibited. Note: On some sites where it is not possible to have access to a washdown pit, washdown of chute and hopper will need to be CONCRETE TRUCK WASHING: done into a wheelbarrow or container and taken to an approved

disposal site.

SPILL PREVENTION BEST MANAGEMENT PRACTICES MATERIAL MANAGEMENT PRACTICES

The following are the material management practices that will be used to reduce the risk of spills or other accidental exposure of materials and substances to water runoff.

The following GOOD HOUSEKEEPING PRACTICES will be followed

onsite during the construction project. week and following any storm event of 0.5 inches or greater.

An effort will be made to store only enough product required to do

3) All disturbed areas must be seeded, fertilized, and

All materials stored onsite will be stored in a neat, orderly manner in their appropriate containers and, if possible, under a roof or

Products will be kept in their original containers with the original manufacture's label.

Substances will not be mixed with one another unless recommended by the manufacturer

Whenever possible, all of a product will be used up before disposing

Manufacturers' recommendations for proper use disposal will be

The site superintendent will inspect daily to ensure proper use disposal of materials onsite.

HAZARDOUS MATERIAL PRACTICES

contain important product information

other enclosure.

These practices are used to reduce the risks associated with hazardous materials:

Products will be kept in original containers unless they are not

Original labels and material safety data will be retained; they

and maintenance practices necessary for keeping the erosion If surplus product must be disposed of, manufacturers' or local and State recommended methods for proper disposal will be

PRODUCT SPECIFIC PRACTICES

The following product specific practices will be followed onsite: PETROLEUM BASED PRODUCTS:

Containers for products such as fuels, lubricants and tars will be inspected daily for leaks and spills. This includes on—site vehicle and machinery daily inspections and regular preventative maintenance of such equipment. Equipment maintenance areas will be located away from state water, natural drains and storm water drainage inlets. In addition, temporary fueling tanks shall have a secondary containment liner to prevent/minimize site contamination. Discharge of oils, fuels and lubricants is prohibited. Proper disposal methods will include collection in a suitable container and disposal as required by local and State regulations.

POINTS/FINISHES/SOLVENTS:

All products will be stored in tightly sealed original containers when not in use. Excess products will not be discharged to the storm water collection system. Excess product, materials used with these products and product containers will be disposed of according to manufacturer's specifications and recommendations.

No concrete trucks will not be allowed to wash out or discharge surplus concrete or drum wash water onsite.

FERTILIZER/HERBICIDES:

These products will be applied at rates that do not exceed the manufacturer's specifications or above the guidelines set forth in the crop establishment or in the GSWCC Manual for Erosion and Sediment Control in Georgia. Any storage of these materials will be under roof in sealed containers.

BUILDING MATERIALS:

No building or construction materials will be buried or disposed of onsite. All such material will be disposed of in proper waste disposal procedures.

SOIL CLEANUP AND SPILL CONTROL PRACTICES

Local, State and manufacturer's recommended methods for spill cleanup will be clearly posted and procedures will be made available to site personnel.

Material and equipment necessary for spill cleanup will be kept in the material storage areas. Typical materials and equipment includes, but is not limited to, brooms, dustpans, maps, rags, gloves, goggles, cat litter, sand, sawdust and property labeled plastic and metal waste containers.

Spill prevention practices and procedures will be reviewed after a spill and adjusted as necessary to prevent future spills.

All spills will be cleaned up immediately upon discovery. All spills

will reported as required by local, State and Federal regulations. FOR SPILLS THAT IMPACT SURFACE WATER (LEAVE A SHEEN ON SURFACE WATER). THE NATIONAL RESPONSE CENTER (NRC) WILL BE CONTACTED WITHIN 24 HOURS AT 1-800-424-8802.

FOR SPILLS of AN UNKNOWN AMOUNT, THE NATIONAL CENTER (NRC) WILL BE CONTACTED WITH 24 HOURS AT 1-800-424-8802.

FOR SPILLS GREATER THAN 25 GALLONS AND NO SURFACE WATER IMPACTS, THE GEORGIA EPD WILL BE CONTACTED WITHIN 24 HOURS.

FOR SPILLS LESS THAT 25 GALLONS AND NO SURFACE WATER IMPACTS, THE SPILL WILL BE CLEANED UP AND LOCAL AGENCIES WILL BE CONTACTED AS REQUIRED.

The contractor shall notify licensed professional who prepared this plan if more than 1320 gallons of petroleum is stored onsite (this includes capacities of equipment) or if any one piece of equipment has a capacity greater than 560 gallons. The contractor will need a Spill Prevention Containment and Countermeasures Plan prepared by that licensed professional.

1) Erosion control measures will be maintained at all times. If full implementation of the approved plan does not provide for effective erosion control, additional erosion and sediment control measures shall be implemented to control or treat the sediment source.

2) All BMPs will be inspected daily and any dificiencies noted will be corrected by the end of each day. Additional BMPs will be installed if deemed necessary by on-site inspection.

mulched as soon as construction phase permit. Also, these disturbed areas must be protected until permanent vegetation is established.

4) The escape of sediment from the site shall be prevented by the installation of erosion and sediment control measures and practices prior to land-disturbing

5) All unsurfaced areas disturbed by grading operations shall receive four (4) inches of topsoil. Contractor shall apply stabilization fabric to all slopes that are 10' or greater in height & slope of 3H:1V or greater as necessary to retain topsoil. Contractor shall maintain best management practices on disturbed slopes in accordance with the Manual for Erosion and Sediment Control in Georgia until a healthy stand of grass is maintained over more than 70% of the disturbed area and to the satisfaction of the Owner.

6) It is the responsibility of the contractor to clean out all existing and proposed inlets, pipes, and manholes of debris and sediment at completion of the site work in conformance with all State and local specifications, and to the satisfaction of the Owner.

7) Silt fence shall meet the requirements of Section 171, "Silt Fence" of the State of Georgia Department of Transportation Standard Specifications, and meet specifications for Type "C" silt fence in the "Manual for Erosion and Sediment Control in Georgia", and shall be wire reinforced as required by these specifications. A double row must be installed between land disturbing activities and state waters.

8) All earthwork operations should be scheduled in a manner to maintain proper routing of storm water through sediment control devices. If it is necessary to perform construction activities in an order that is not in accordance with the activity schedule on this plan, or the construction schedule will allow for disturbed areas to bypass best management practices, the contractor is to contact the engineer prior to commencement of such activities and implement erosion control devices that will control sediment, at the satisfaction of the engineer and in accordance with the Manual for Erosion and Sediment Control in Georgia.

9) Detention facilities and erosion control measures are to be accomplished prior to any other construction on the site and maintained until permanent ground cover is

10) Length of riprap shall be 6 times the diameter of the stormwater outlet pipe at a minimum.

11) File Notice of Intent and Notice of Termination with GA EPD if required.

12) No concrete vehicle washdown or storage of any petroleum products is allowed on site.

13) Stormwater pollutants are decreased on this site with the installation of sediment barriers and permanent vegetative cover. The vegetative cover will remain as a permanent ground stabilization measure.

14) Revisions to the ES&PC plan which have a significant hydraulic component must be certified by the design

15) Waste materials shall not be discharged to waters of the state, except as authorized by a section 404 permit.


16) Owner to verify all waste disposal, sanitary sewer, and septic tank regulations for removal and remediation have

17) Any disturbed area left exposed for a period greater than 14 days shall be stabilized with mulch or temporary




NO NPDES MONITORING TO OCCUR FOR THIS PROJECT




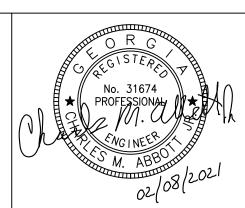




CHARLES M. ABBOTT JR, P.E. DESIGN ENGINEER LEVEL II CERTIFICATION GSWCC # 0000041686 EXPIRES: 04/13/2022 CHUCK.ABBOTT@KAIZENCOLLABORATIVE.COM T: 404-239-2521

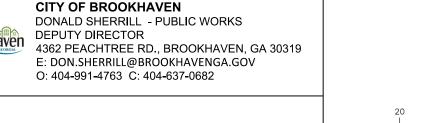


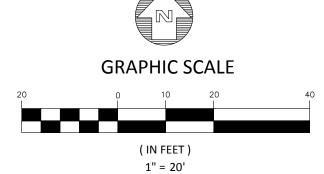

REVISION DATES			STATE OF GEORGIA DEPARTMENT OF TRANSPORTA	TION
	100% ISSUE FOR PERMIT	11/20/2020	OFFICE: DISTRICT 7	<u>. 11011</u>
	REV. 1 CITY COMMENTS REV. 2 AGENCY COMMENTS	01/11/2021 02/08/2021	FROSION CONTROL BM	 1P
			N.E. EXPRESSWAY FRONTAGE ROAD	DRAWING No
			MUTI-USE PATH	51-000

2020-205

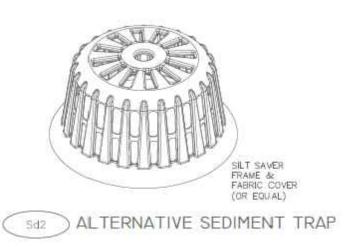

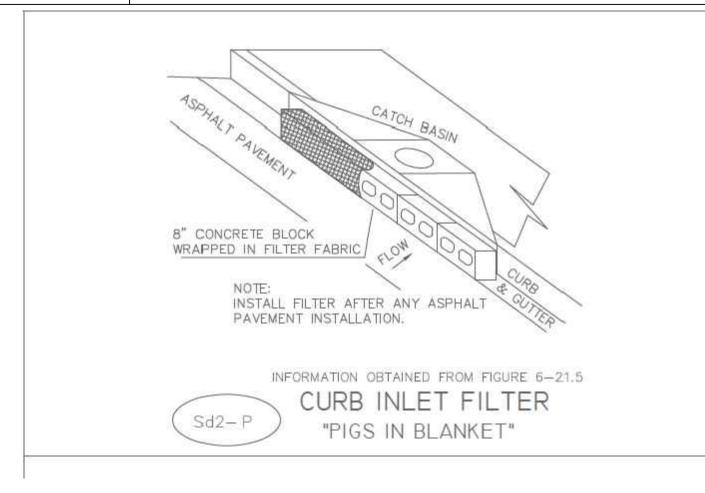

Dust Control on Disturbed Areas



Controlling surface and air movement of dust on construction sites, roads, and demolition sites.

PURPOSE To prevent surface and air movement of dust

or to animals or plant life.

from exposed soil surfaces. •To reduce the presence of airborne substances which may be harmful or injurious to human health, welfare, or safety,

CONDITIONS This practice is applicable to areas subject to surface and air movement of dust where on and off-site damage may occur without treatment.

METHOD AND MATERIALS

GSWCC (Amended - 2013)

A. Temporary Methods Mulches. See standard Ds1 - Disturbed Area Stabilization (With Mulching Only). Synthetic resins may be used instead of asphalt to bind mulch

material. Refer to specification Tac - Tackifiers. Resins such as Curasol or Terratack should be used according to manufacturer's recommenda-

Vegetative Cover. See specification Ds2 -Disturbed Area Stabilization (With Temporary

Spray-on Adhesives. These are used on mineral soils (not effective on muck soils). Keep traffic off these areas. Refer to specification Tac - Tackifiers. Tillage. This practice is designed to roughen

Charles M Abbott

ISSUED: 04/13/2019 EXPIRES: 04/13/2022

CERTIFICATION NUMBER ___

and bring clods to the surface. It is an emergency measure which should be used before wind erosion starts. Begin plowing on windward side of site. Chisel-type plows spaced about 12 inches apart, spring-toothed harrows, and similar plows are examples of equipment which may produce

the desired effect. Irrigation. This is generally done as an emergency treatment. Site is sprinkled with water until he surface is wet. Repeat as needed.

Barriers. Solid board fences, snowfences, burlap fences, crate walls, bales of hay and similar material can be used to control air currents and soil blowing. Barriers placed at right angles to prevailing currents at intervals of about 15 times their height are effective in controlling wind erosion.

surface moist. May need retreatment.

Calcium Chloride. Apply at rate that will keep


Permanent Vegetation. See specification Ds3
-Disturbed Area Stabilization (With Permanent afford valuable protection if left in place.

Topsoiling. This entails covering the surface with less erosive soil material. See specification

Stone. Cover surface with crushed stone or coarse gravel. See specification Cr-Construction

Level II Certified Design Professional

NO NPDES MONITORING TO OCCUR FOR THIS PROJECT

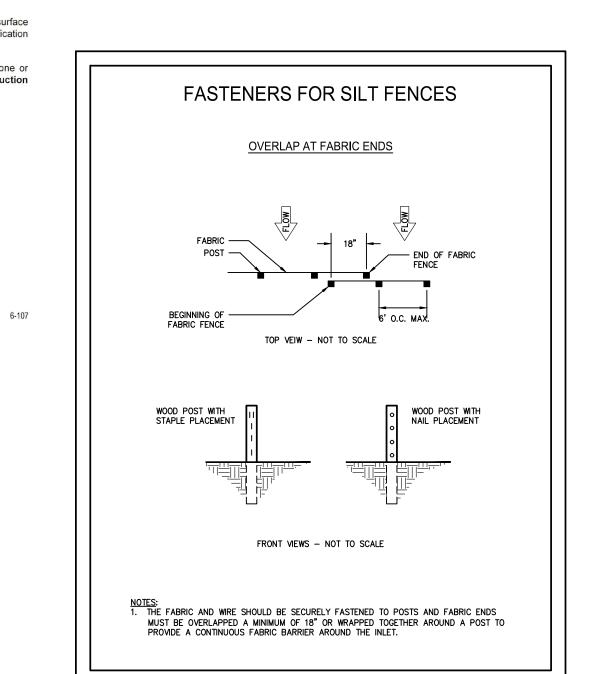

CRUSHED STONE CONSTRUCTION EXIT **EXIT DIAGRAM** CULVERT (IF NEEDED) DIVERSION RIDGE/ SEE NOTE 6 NSR R-2 (1.5" - 3.5")COARSE AĞGREGATE GEOTEXTILE UNDERLINER **ENTRANCE ELEVATION** TIER WASHRACK AREA/ TIRE WASHERS SUPPLY WATER IF NEEDED TO WASH WHEELS GEOTEXTILE 1. AVOID LOCATING ON STEEP SLOPES OR AT CURVES ON PUBLIC ROADS.

2. REMOVE ALL VEGETATION AND OTHER UNSUITABLE MATERIAL FROM THE FOUNDATION AREA, GRADE, AND CROWN FOR POSITIVE DRAINAGE.

3. AGGREGATE SIZE SHALL BE IN ACCORDANCE WITH NATIONAL STONE ASSOCIATION R-2 (1.5"-3.5" STONE). 4. GRAVEL PAD SHALL HAVE A MINIMUM THICKNESS OF 6". 5. PAD WIDTH SHALL BE EQUAL FULL WIDTH AT ALL POINTS OF VEHICULAR EGRESS, BUT NO LESS THAN 20'.

6. A DIVERSION RIDGE SHOULD BE CONSTRUCTED WHEN GRADE TOWARD PAVED AREA IS GREATER THAN 2%.. 7. INSTALL PIPE UNDER THE ENTRANCE IF NEEDED TO MAINTAIN DRAINAGE DITCHES. 8. WHEN WASHING IS REQUIRED, IT SHOULD BE DONE ON AN AREA STABILIZED WITH CRUSHED STONE THAT DRAINS INTO AN APPROVED SEDIMENT TRAP OR SEDIMENT BASIN (DIVERT ALL SURFACE RUNOFF AND

DRAINAGE FROM THE ENTRANCE TO A SEDIMENT CONTROL DEVICE). 9. WASHRACKS AND/OR TIRE WASHERS MAY BE REQUIRED DEPENDING ON SCALE AND CIRCUMSTANCE. IF NECESSARY, WASHRACK DESIGN MAY CONSIST OF ANY MATERIAL SUITABLE FOR TRUCK TRAFFIC THAT


REMOVE MUD AND DIRT. 10.MAINTAIN AREA IN A WAY THAT PREVENTS TRACKING AND/OR FLOW OF MUD ONTO PUBLIC RIGHTS-OF-WAYS. THIS MAY REQUIRE TOP DRESSING, REPAIR AND/OR CLEANOUT OF ANY MEASURES

USED TO TRAP SEDIMENT. 11. CONSTRUCTION ENTRANCE DIMENSIONS MAY BE ADJUSTED TO MEET FIELD CONDITIONS AND AS NECCESSARY TO STAY WITHIN PUBLIC R/W AND OUTSIDE OF ROADWAY. REDUCTION IN SIZE NOT PERMISSIBLE

IF DOING SO PROHIBITS PROPER EROSION AND SEDIMENT CONTROL BMPS

SILT FENCE - TYPE NON-SENSITIVE



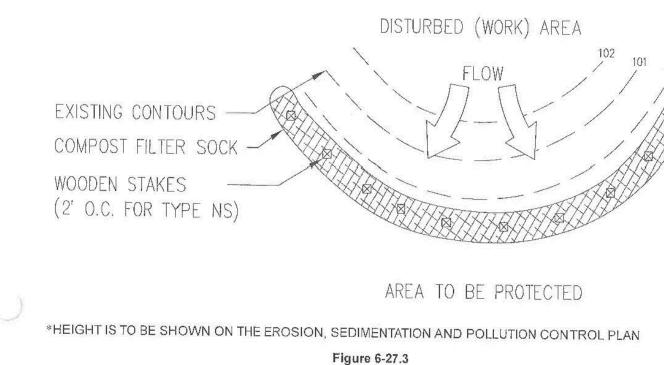

EROSION AND SEDIMENT CONTROL

TYPE B COMPOST FILTER SOCK

CROSS-SECTION

PLAN

— 48"x24" PLYWOOD PAINTED WHITE

- BLACK LETTERS

- 2" LAG SCREWS

WOOD POSTS

6" HEIGHT

- 3"x3"x8'

— FILTER SOCK*

6-143

AREA TO BE PROTECTED

GSWCC 2016 Edition CONCRETE WASHOUT - STRAW BALE PLASTIC LINING CONCRETE WASHOUT SIGN DETAIL **PLAN** STAPLE DETAIL 1. ACTUAL LAYOUT OF WASHOUT FACILITY TO BE 1. ACTUAL LAYOUT OF WASHOUT FACILITY TO BE DETERMINED IN FIELD.
2. CONCRETE WASHOUT SIGN SHALL BE INSTALLED WITHIN 30 FT. OF WASHOUT FACILITY.
3. PLASTIC LINING SHALL BE FREE OF TEARS OR HOLES THAT WOULD ALLOW THE WASHWATER TO ESCAPE.
4. DISPOSE OF HARDENED CONCRETE IN STATE—APPROVED LANDFILL OR RECYCLE WHERE STAPLES -PLASTIC LINING (2 PER BALE) - BINDING WIRE ACCEPTED.
5. DAMAGED HAYBALES OR PLASTIC LINER TO BE REPLACED AS NEEDED THROUGHOUT OPERATION OF REPLACED AS NEEDED THROUGHOUT OPERATION OF WASHOUT FACILITY.

6. AT END OF WASHOUT FACILITY SERVICE LIFE, ALL MATERIAL USED TO CONSTRUCT FACILITY MUST BE DISPOSED OF IN STATE—APPROVED LANDFILL.

7. NEVER DISPOSE OF WASHWATER IN STREETS, STORM DRAINS, OR STREAMS.

8. WASHOUT OF CONCRETE TRUCK DRUM ONSITE IS PROHIBITED. NATIVE MATERIAL -METAL STAKES (OPTIONAL) (2 PER BALE) SECTION A-A 9. EXACT QUANTITIES AND LOCATIONS OF CONCRETE WASHOUTS TO BE DETERMINED BY CONTRACTOR.

CONCRETE WASHOUT - ABOVE GRADE WITH STRAW BALES

DISTURBED

(WORK) AREA


NOTE: FILTER SOCK SIZED TO SUIT

CONDITIONS AND AT LEAST 18" DIA


FILTER SOCK HEIGHT

(SEE EQUIVALENT LIST)

TO BE MIN. 18"

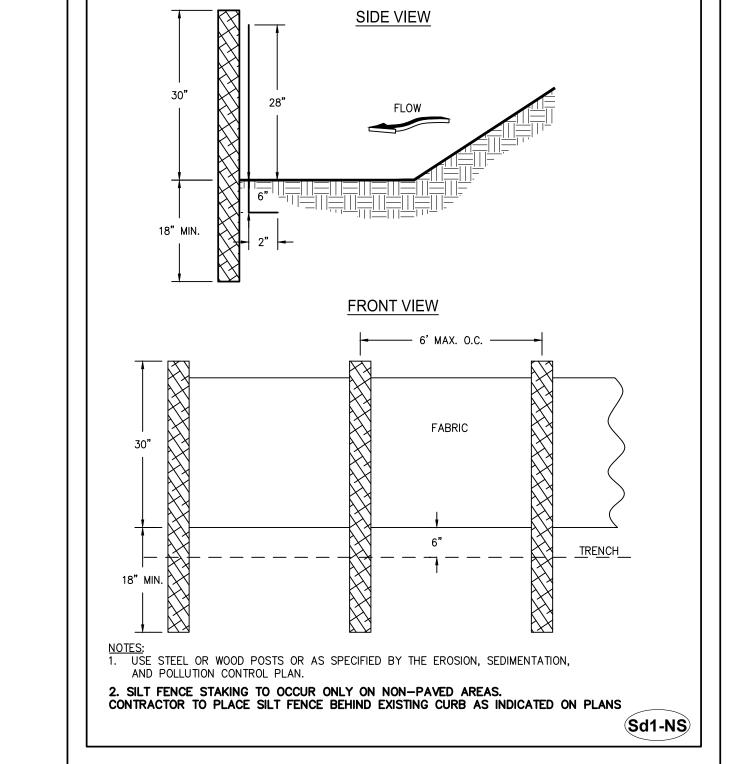





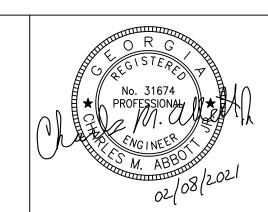

PLANS PREPARED BY: KAIZENCOLLABORATIVE Brookhaven 2390 Main Street | Tucker, GA 30084 | 404.239.2521

CHARLES M. ABBOTT JR, P.E. DESIGN ENGINEER LEVEL II CERTIFICATION GSWCC # 0000041686 EXPIRES: 04/13/2022 CHUCK.ABBOTT@KAIZENCOLLABORATIVE.COM T: 404-239-2521

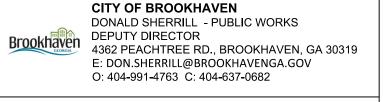

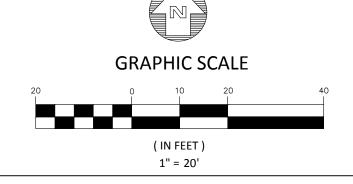

REVISION DAT	ES	STATE OF GEORGIA
100% ISSUE FOR PERMIT	11/20/2020	DEPARTMENT OF TRANSPORTATION OFFICE: DISTRICT 7
REV. 1 CITY COMMENTS	01/11/2021	OTTICE. DISTINICT /
REV. 2 AGENCY COMMENTS	02/08/2021	FROSION CONTROL DETAILS
		N.E. EXPRESSWAY FRONTAGE ROAD DRAWING No
		MUTI-USE PATH 56-000

2020-205

CONSTRUCTION SPECIFICATIONS Sediment traps may be constructed on natural ground surface, on an excavated surface, or on machine compacted fill provided they have a non-erodible outlet.

Filter Fabric with Supporting Frame This method of inlet protection is applicable where the inlet drains a relatively flat area (slope no greater than 5%) and shall not apply to inlets receiving concentrated flows, such as in street or highway medians. As shown in Figure 6-28.1, Type C silt fence supported by steel posts shall be used. The stakes shall be spaced evenly around the perimeter of the inlet a maximum of 3 feet apart, and securely driven into the ground, approximately 18 inches deep. The fabric shall be 36" tall and entrenched 12 inches and backfilled with crushed stone or compacted soil. Fabric and wire shall be securely fastened to the posts, and fabric ends must be overlapped a minimum of 18 inches or wrapped together around a post to provide a continuous fabric barrier

around the inlet.Block and Gravel Drop Inlet Protection

FABRIC AND SUPPORTING FRAME FOR

INLET PROTECTION

NOTES: I. DESIGN IS FOR SLOPES NO GREATER THAN 5% (NOT DESIGNED FOR CONCENTRATED FLOWS). THE STEEL POSTS SUPPORTING THE SILT FENCE

MATERIAL SHOULD BE SPACED EVENLY AROUND

THE PERIMETER OF THE INLET (MAXIMUM OF 3'

THE STEEL POSTS SHOULD BE SECURELY DRIVEN

THE FABRIC SHOULD BE ENTRENCHED AT LEAST

OR COMPACTED SOIL.

- BURIED FABRIC

- WIRE-BACKING

INLET SEDIMENT TRAP

- GATHER EXCESS AT CORNERS

— DROP INLET WITH GRATE

- CRUSHED STONE OR COMPACTED SOIL

12" AND THEN BACKFILLED WITH CRUSHED STONE

STEEL FRAME AND SILT FENCE INSTALLATION

This method of inlet protection is applicable where

1.5' MAX.

*FABRIC ENTRENCHED AT

LEAST 12" AND BACKFILLED WITH CRUSHED STONE OR

is necessary to prevent excessive ponding around the structure. As shown in Figure 6-21.3, one block is placed on each side of the structure on its side in the bottom row to allow pool drainage. The foundation should be excavated at least 2 inches below the crest of the storm drain. The bottom row of blocks are placed against the edge of the storm drain for lateral support and to avoid washouts when overflow occurs. If needed, lateral support may be given to subsequent rows by placing 2" x 4" wood studs through block openings. Hardware cloth or comparable wire mesh with 1/2 inch openings shall be fitted over all block openings to hold gravel in place. Clean gravel should be placed 2 inches below the top of the block on a 2:1 slope or flatter and smoothed to an even grade. DOT #57 washed stone is recommended Curb Inlet Protection

heavy flows are expected and where an overflow capacity

- 8-inch concrete blocks wrapped in filter fabric. See Figure 6—28.6. Another method uses gravel bags constructed by wrapping DOT #57 stone with filter fabric, wire, plastic mesh, or equivalent material. A gap of approximately 4 inches shall be left between the inlet filter and the inlet to allow for overflow and prevent hazardous ponding in the roadway. Proper installation and maintenance are crucial due to possible ponding in the roadway, resulting in a hazardous condition. Several other methods are available to prevent the entry of sediment into storm drain inlets. Figure 6-28.7 shows of one of these alternative methods

MAINTENANCE

Sediment shall be removed when the sediment has accumulated to one-half the height of the trap. Sediment shall be removed from curb inlet protection immediately. For excavated inlet sediment traps, sediment shall be removed when one—half of the sediment storage capacity has been lost to sediment accumulation. Sod inlet protection shall be maintained as specified in Ds4 — Disturbed Area Stabilization (With Sodding). Sediment shall not be washed into the inlet. It shall be removed from the sediment trap and disposed of and stabilized so that it will not enter the inlet, again. When the contributing drainage area has been permanently stabilized, all materials and any sediment shall be removed, and either salvaged or disposed of properly. The disturbed area shall be brought to proper grade, then smoothed and compacted. Appropriately stabilize all disturbed areas around the inlet.


and repairs made as needed

Sd2-P

Once pavement has been installed, a curb inlet filter

CURB INLET FILTER "PIGS IN BLANKET"

WRAPPED IN FILTER FABRIC - CATCH BASIN — Gutter PAVEMENT

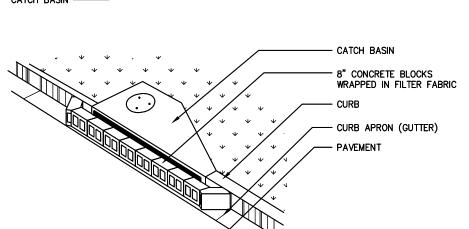


CURB INLET FILTER "PIGS IN

BLANKET"

The trap shall be inspected daily and after each rain

<u>{otes:</u> |. Install filter after any ASPHALT PAVEMENT INSTALLATION. 2. WRAP 8" CONCRETE BLOCKS IN FILTER FABRIC AND SPAN ACROSS CATCH BASIN INLET. FACE OPENINGS IN BLOCKS LEAVE A GAP OF APPROXIMATELY PAVEMENT -4 INCHES BETWEEN THE CURB AND THE FILTERS TO ALLOW FOR GUTTER ---8" CONCRETE OVERFLOW TO PREVENT BLOCK WRAPPED IN FILTER FABRIC BELOW STORM DRAIN OUTLETS.

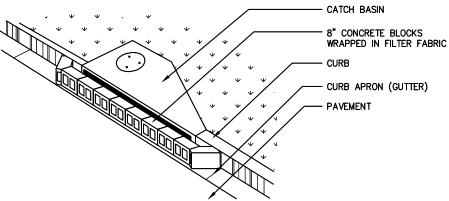

REQUIREMENT FOR REGULATORY COMPLIANCE

Mulch or temporary grassing shall be applied to all exposed areas within 14 days of disturbance. Mulch can be used as a singular erosion control device for up to six months, but it shall be applied at the appropriate depth, depending on the material used, anchored, and have a continuous 90% cover or greater of the soil surface. Maintenance shall be required to maintain appropriate depth and 90% cover. Temporary vegetation may be employed instead of mulch if the area will remain undisturbed for less than six months. If an area will remain undisturbed for greater than six months, permanent vegetative techniques shall be employed. Refer to Ds2-Disturbed Area Stabilization (With Temporary Seeding), Ds3—Disturbed Area Stabilization (With Permanent Seeding), and Ds4-Disturbed Area Stabilization (With Sodding). **SPECIFICATIONS**

This standard applies to grades or cleared areas where seedings may not have a suitable growing season to produce an erosion retardant cover, but can be

Site Preparation 1. Grade to permit the use of equipment for applying and anchoring mulch. 2. Install needed erosion control measures as required such as dikes, diversions, berms, terraces and sediment barriers.

3. Loosen compact soil to a minimum depth of 3 inches. **Mulching Materials**

Select one of the following materials and apply at the depth indicated: 1. Dry straw or hay shall be applied at a depth of 2 to 4 inches providing complete soil coverage. One advantage of this material is easy application. 2. Wood waste (chips,sawdust or bark) shall be applied at a depth of 2 to 3 inches. Organic material from the clearing stage of development should remain on site, be chipped, and applied as mulch. This method of mulching can greatly reduce erosion control costs.

3. Polyethylene film shall be secured over banks or stockpiled soil material for temporary protection. This material can be salvaged and re-used.

Applying Mulch

When mulch is used without seeding, mulch shall be applied to provide full coverage of the exposed area. 1. Dry straw or Hay mulch and wood chips shall be applied uniformly by hand

or by mechanical equipment. 2. If the area will eventual be covered with perennial vegetation, 20-30 pounds of nitrogen per acre in addition to the normal amount shall be applied to offset the uptake of nitrogen caused by the decomposition of the organic

3. Apply polyethylene film on exposed areas.

DISTURBED AREA STABILIZATION (WITH MULCHING ONLY)

Anchoring Mulch

1. Straw or hay mulch can be pressed into the soil with a disk arrow with the disk set straight or with a special "packer disk." Disks may be smooth or serrated and should be 20 inches or more in diameter and 8 to 12 inches apart. The edges of the disk should be dull enough no to cut the mulch but to press it into the soil leaving much of it in an erect position. STRAW OR HAY MULCH SHALL BE ANCHORED IMMEDIATELY AFTER APPLICATION. Straw or hav mulch spread with special blower-type equipment may be anchored. Tackifieers, binders and hydraulic mulch with tackifier specifically designed for tacking straw can be substirued for emulsified asphalt. Please refer to specification Tac—Tackifers. Plastic mesh or netting with mesh no larger than one inch by one inch shall be installed according to manufacturer's

Netting of the appropriate size shall be used to anchor wood waste. Openings of the netting shall not be larger than the average size of the wood 3. Polyethylene film shall be anchor trenched at the top as well as incrementally as necessary.

shall be installed on inlets receiving runoff from disturbed areas. This method of inlet protection shall be removed if a safety hazard is created. One method of curb inlet protection uses "pigs-in-ablanket"

> DESIGN ENGINEER LEVEL II CERTIFICATION GSWCC # 0000041686 EXPIRES: 04/13/2022 T: 404-239-2521

CITY OF BROOKHAVEN DONALD SHERRILL - PUBLIC WORKS DEPUTY DIRECTOR

4362 PEACHTREE RD., BROOKHAVEN, GA 30319 E: DON.SHERRILL@BROOKHAVENGA.GOV O: 404-991-4763 C: 404-637-0682

REQUIREMENT FOR REGULATORY COMPLIANCE Refer to specification Ds1 — Disturbed Area Stabilization (With Temporary

INSTALLATION SPECIFICATIONS

Grading and shaping Excessive water run-off shall be reduced by properly designed and installed erosion control practices such as closed drains, ditches, dikes, diversions, sediment barriers and others. No shaping or grading is required if slopes can be stabilized by hand—seeded vegetation or if hydraulic seeding equipment is

Seedbed preparation

When a hydraulic seeder is used, seedbed preparation is not required. When using conventional or hand—seeding, seedbed preparation is not required if the soil material is loose and not sealed by rainfall. When soil has been sealed by rainfall or consists of smooth cut slopes, the soil shall be pitted, trenched or otherwise scarified to provide a place for seed to lodge and germinate.

Lime and fertilizer Agricultural lime is required unless soil tests indicate otherwise. Apply

agricultrual lime at a reate determined by soil test for pH. Quick acting lime shold be incorporated to midify pH during th egermination period. Bio stimulants should also be considered when there is less than 3% organic matter in the soil. Graded areas require lime application. Soils must be tested to determine required amounts of fertilzer and amendments. Fertilizer should be applied before land prepreation and incorporaed with a disk, ripper or chisel. On slopes too steep for, or inaccessible to equipment, fertilizer shall be hydraulically applied, preferably in thefirst pass with seed. and shoume hydraulic mulch, then topped with the remaining required application rate.

Apply agricultural lime at a rate of one ton per acre. Graded areas require lime application. Soils can be tested to determine if fertilizer is needed. On reasonably fertile soils or soil material, fertilizer is not required. For soils with very low fertility, 500 to 700 pounds of 10-10-10 fertilizer or the equivalent per acre (12—16 lbs./1,000 sq. ft.) shall be applied. Fertilizer should be applied before land preparation and incorporated with a disk, ripper or chisel.

Select a grass or grass—legume mixture suitable to the area and season of the year. Seed shall be applied uniformly by hand, cyclone seeder, drill, cultipacker—seeder, or hydraulic seeder (slurry including seed and fertilizer). Drill or cultipacker seeders should normally place seed one-quarter to one-half inch deep. Appropriate depth of planting is ten times the seed diameter. Soil should be "raked" lightly to cover seed with soil if seeded by hand. See Table 6-4.1

Mulching

Temporary vegetation can, in most cases, be established without the use of mulch, provided there is little to no erosion poteintial. However, the use of mulch can often accelerate and enchance germination and vegetation establishement. Mulch without seeding should be considered for short term protection. Refer to Ds1-Disturbed Area Stabilization (With Mulching Only).

During times of drought, water shall be applied at a rate not causing runoff and erosion. The soil shall be thoroughly wetted to a depth that will insure germination of the seed. Subsequent applications should be made when needed.

SUGGESTED SEEDBED DEPTHS

	_
SLOPE	SEEDBED DEPTHS
3:1 OR FLATTER	LESS THAN 4" DEPTH
2:1 TO 3:1	1" TO 4" DEPTH
2:1 OR STEEPER	DEPRESSIONS EVERY 6"— 8" HAND DUG, IF

<u>Species</u> <u> Rates 2/ — PLS 3/ Area 4/</u> 1000 <u>sq.ft.</u> <u>Acre</u> (Hordeum vulgare) in mixtures 0.6 lb LESPEDEZA, ANNUAL Lespedeza striata) 40 lbs. 10 lbs. 0.2 lb n mixtures May last for several years. Mix with Sericea (Eragrostis curvula) n mixtures 2 lbs. 0.05 lb MILLET, BROWNTOP 37.000 seed per pound Will provide too much competition in mixtures if seeded at high rates. 40 lbs. 10 lbs. in mixtures MILLET, PEARL 88,000 seed per pound Quick dense cover. May reach 5 feet in ennesetum glaucum 50 lbs. 1.1 lb (Avena sativa) se on productive soi Not as winterhardy as rye or barley. 4 bu. (128 lbs.) in mixtures 0.7 lb. (32 lbs.) 18,000 seed per pound Secale cereale) Quick cover. Drought colerant and winterhard 3.9 lb 0.6 lb. in mixtures RYEGRASS, ANNUAL (Lolium temulentum) 7,000 seed per pound Dense cover. Very competitve and is <u>NOT</u> 40 lbs. 0.9 lb to be used in mixtur 55.000 seed per pound (Sorghum sudanese) ood on drought sites OT recommended for 60 lbs. Use on lower part o X-Triticosecale) Southern Coastal Pl in Atlantic Coastal Flatwoods only. 0.6 lb. n mixtures Triticum aestivum) Quick cover. Drough 4.1 lb. 0.7 lb. n mixtures / Temporary cover crops are very competitive and will crown out perennials if seeded too heavily. Reduce seeding rates by 50% when drilled. PLS is an abbreviation for Pure Live Seed / M-L represents the Mountain; Blue Ridge; and Ridges and Valleys MLRAs

MAINTENANCE

Re-seed areas where an adequate stand of temporary vegetation fails to emerge or where a poor stand exists.

DISTURBED AREA STABILIZATION (WITH TEMPORARY SEEDING)


Ds2

P represents the Southern Piedmont MLRA
C represents Southern Coastal Plain; Sand Hills; Black Lands and Atlantic Coastal Flatwoods MLRA

GSWCC Charles M Abbott Level II Certified Design Professional CERTIFICATION NUMBER _ ISSUED: 04/13/2019 EXPIRES: 04/13/2022


NO NPDES MONITORING TO OCCUR FOR THIS PROJECT



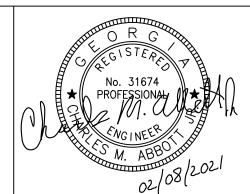



CHARLES M. ABBOTT JR, P.E. CHUCK.ABBOTT@KAIZENCOLLABORATIVE.COM

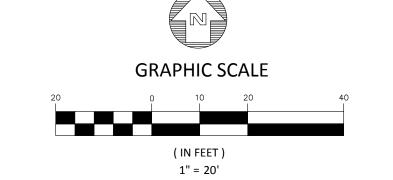

REVISION DATES		STATE OF GEORGIA
100% ISSUE FOR PERMIT	11/20/2020	DEPARTMENT OF TRANSPORTATION OFFICE: DISTRICT 7
REV. 1 CITY COMMENTS	01/11/2021	OTTIOL. DISTRICT /
REV. 2 AGENCY COMMENTS	02/08/2021	FROSION CONTROL DETAILS
		N.E. EXPRESSWAY FRONTAGE ROAD DRAWING No.
		MUTI-USE PATH 56-0008



The planting of perennial vegetation such as trees, shrubs, vines, grasses, or legumes on exposed areas for final permanent stabilization Permanent perennial vegetation shall be used to achieve final stabilization

 To protect the soil surface from erosion •To reduce damage from sediment and

runoff to down-stream areas To improve wildlife habitat and visual

 To improve aesthetics REQUIREMENT FOR REGULATORY

This practice shall be applied immediately to rough graded areas that will be undisturbed for longer than six months. This practice or sodding shall be applied immediately to all areas at fina grade. Final Stabilization means that all soil disturbing activities at the site have been completed, and that for unpaved areas and areas not covered by permanent structures and areas located outside the waste disposal limits of a

landfill cell that has been certified by the GA EPD for waste disposal, 100% of the soil surface is uniformlycovered in permanent vegetation with a density of 70% or greater, or landscaped acscaping materials in planned landscaped areas) or equivalent permanent stabilization measures.

Wildlife Plantings Commercially available plants beneficial to wildlife species include the following: Mast Bearing Trees

Beech, Black Cherry, Blackgum, Chestnut, Chinkapin, Hackberry, Hickory, Honey Locust Native Oak, Persimmon, Sawtooth Oak and

All trees that produce nuts or fruits are favored by many game species. Hickory provides nuts used mainly by squirrels and bear Shrubs and Small Trees

Bayberry, Bicolor Lespedeza, Crabapple, Dogwood, Huckleberry or Native Blueberry, Mountain Laurel, Native Holly, Red Cedar, Red Mulberry, Sumac, Wax Myrtle, Wild Plum and Blackberry.

Plant in patches without tall trees to develop stable shrub communities. All produce fruits used by many kinds of wildlife, except for lespedeza which produces seeds used by quail and songbirds. Grasses, Legumes, Vines and Temporary Cover

Bahiagrass, Bermudagrass, Grass-Legume mixtures, Partridge Pea, Annual Lespedeza, Orchardgrass (for mountains), Browntop Millet (for temporary cover), and Native grapes.

Provides herbaceous cover in clearings for a game bird brood-rearing habitat. Appropriate legumes such as vetches, clovers, and lespedezas may be mixed with grass, but they may die out

ment is to be used. Vertical banks shall be

CONSTRUCTION SPECIFICATIONS Grading and Shaping rading and shaping may not be required where hydraulic seeding and fertilizing equip-

sloped to enable plant establishment. to be done, grade and shape where feasible and practical, so that equipment can be used safely and efficiently during seedbed preparation, seeding, mulching and maintenance of the vegetation. Concentrations of water that will cause excessive

Finely ground limestone can be applied in the mulch slurry or in combination with the top dressing. When conventional planting is to be done, lime and fertilizer shall be applied uniformly in one of the following ways:

 Apply before land preparation so that it will be mixed with the soil during seedbed prepara-

2. Mix with the soil used to fill the holes, distribute in furrows. 3. Broadcast after steep surfaces are scarified,

4. A fertilizer pellet shall be placed at root depth in the closing hole beside each pine tree

Refer to Tables 6-4.1, 6-5.2, 6-5.3 and 6-5.4 for approved species. Species not listed shall be approved by the State Resource Conservationist of the Natural Resources Conservation Service before they are used.

Plants shall be selected on the basis of species characteristics, site and soil conditions, planned use and maintenance of the area; time of year o planting, method of planting; and the needs and Some perennial species are easily established

and can be planted alone. Examples of these are Common Bermuda, Tall Fescue, and Weeping Other perennials, such as Bahia Grass and Seri cea Lespedeza, are slow to become established and should be planted with another perennial species. The additional species will provide quick cover

and ample soil protection until the target perennial mon seeding combinations are 1) Weeping Lovegrass with Sericea Lespedeza (scarified) and 2) Tall Fescue with Sericea Lespedeza (unscarified). Plant selection may also include annual compan-

ion crops. Annual companion crops should be used only when the perennial species are not planted during their optimum planting period. A common

Permanent vegetation shall consist of, planted trees, shrubs, perennial vines; or a crop of perennial vegetation appropriate for the region, such that within the growing season a 70% coverage by perennial vegetation shall be achieved. Final stabilization applies to each phase of construct ion. For linear construction projects on land used for agricultural or silvicultural purposes equipment.

final stabilization may be accomplished by stabilizing the disturbed land for its agricultural or silvicultural use. Until this standard is satisfied and permanent control measures and facilities are operational, interim stabilization measures and temporary erosion and sedimentation control

Permanent perennial vegetation is used to provide a protective cover for exposed areas including cuts, fills, dams, and other denuded

. Where individual plants are to be set, the PLANNING CONSIDERATIONS 1. Use conventional planting methods where

2. For nursery stock plants, holes shall be 2. When mixed plantings are done during marginal planting periods, companion crops shall Where pine seedlings are to be planted

done following a summer or winter annual cover crop. Sericea lespedeza planted no-till into stands of rye is an excellent procedure. 4. Block sod provides immediate cover. It is especially effective in controlling erosion adjacent to concrete flumes and other struc-

tures. Refer to Specification Ds4-Disturbed (rea Stabilization (With Sodding) Irrigation should be used when the soil is dry or when summer plantings are done.

6. Low maintenance plants, as well as natives

3. No-till planting is effective when planting is

should be used to ensure long-lasting ero-. Mowing should not be performed during the the amount of innoculant recommended by the quail nesting season (May to September). manufacturer shall be used. 8. Wildlife plantings should be included in All inoculated seed shall be protected from the

soil erosion shall be diverted to a safe outlet. Diversions and other treatment practices shall conform with the appropriate standards and specifications.

Lime and Fertilizer Rates and Analysis Agricultural lime is required at the rate of one to two tons per acre unless soil tests indicate otherwise. Graded areas require lime application. If lime is applied within six months of planting manent perennial vegetation, additional lime is not required. Agricultural lime shall be within the specifications of the Georgia Department of

Lime spread by conventional equipment shall be ground limestone." Ground limestone is calcitic or dolomitic limestone ground so that 90 percent of the material will pass through a 10-mesh sieve, not less than 50 percent will pass through a 50-mesh sieve and not less than 25 percent will pass through a 100-mesh sieve.

equipment should be "finely ground limestone" spanning from the 180 micron size to the 5 micron size. Finely ground limestone is calcitic or dolomitic limestone ground so that 95 percent of the material will pass through a 100-mesh sieve. It is desirable to use dolomitic limestone in the Sand Hills, Southern Coastal Plain and Atlantic

Fast-acting lime spread by hydraulic seeding

Coast Flatwoods MLRAs. (See Figure 6-4.1) Agricultural lime is generally not required where Initial fertilization, nitrogen, topdressing, and

maintenance fertilizer requirements for each species or combination of species are listed in Table Lime and Fertilizer Application When hydraulic seeding equipment is used, the initial fertilizer shall be mixed with seed,

innoculant (if needed), and wood cellulose or wood pulp fiber mulch and applied in a slurry. the seed prior to being placed into the hydraulic seeder. The slurry mixture will be agitated during application to keep the ingredients thoroughly nixed. The mixture will be spread uniformly over

mixture is Brown Top Millet with Common Bermuda in mid-summer. Care should be taken in selecting companion crop species and seeding rates because annual crops will compete with perennial species for water, nutrients, and growing space. A high seeding rate of the companion crop may

prevent the establishment of perennial species. Ryegrass shall not be used in any seeding mixtures containing perennial species due to its ability to out-compete desired species choser for permanent perennial cover. Seed Quality

The term "pure live seed" is used to express the quality of seed and is not shown on the label. Pure live seed, PLS, is expressed as a percentage of the seeds that are pure and will germinate. Information on percent germination and purity can be found on seed tags. PLS is deter mined by multiplying the percent of pure seed

with the percent of germination; i.e., (PLS = % germination x % purity) EXAMPLE:

Common Bermuda seed 70% germination, 80% purity PLS = 70% germination x 80% purity

PLS = 56% The percent of PLS helps you determine the pounds PLS and the bulk seed is 56 % PLS, the bulk seeding rate is:

10 lbs. PLS/acre = 17.9 lbs/acre You would need to plant 17.9 lbs/acre to provide 10 lbs/acre of pure live seed.

Seedbed preparation may not be required where hydraulic seeding and fertilizing equipment is to be used (but is strongly recommended for any seeding process, when possible). When conventional seeding is to be used, seedbed

1. Tillage, at a minimum, shall adequately

loosen the soil to a depth of 4 to 6 inches; the same day inoculated. No inoculated seed shall alleviate compaction; incorporate lime and remain in the hydroseeder longer than one hour. fertilizer: smooth and firm the soil; allow for

4. On slopes too steep for the safe operation

of tillage equipment, the soil surface shall

be pitted or trenched across the slope with appropriate hand tools to provide two places

6 to 8 inches apart in which seed may lodge

and germinate. Hydraulic seeding may also

soil shall be prepared by excavating holes,

subsoil under the row 36 inches deep on the

contour four to six months prior to planting

dry, preferably in August or September.

facturer shall be used to bond the innoculant to

sun and high temperatures and shall be planted

tion establishment enhancement, and erosion

rial from the following and apply as indicated:

3/4:1 or steeper.

. Dry straw or dry hay of good quality and free

be applied at the rate of 2 tons per acre. Dry

hay shall be applied at a rate of 2 1/2 tons

. Wood cellulose mulch or wood pulp fiber

seed shall be applied at a rate of three tons

5. Pine straw or pine bark shall be applied at a

thickness of 3 inches for bedding purposes.

Other suitable materials in sufficient quantity

may be used where ornamentals or other

ground covers are planted. This is not ap-

When using temporary erosion control blan

Bituminous treated roving may be applied on

propriate for seeded areas.

of weed seeds can be used. Dry straw shall

Subsoiling should be done when the soil is

opening furrows, or dibble planting.

the proper placement of seed, sprigs, or plants; and allow for the anchoring of straw Mix the seed (innoculated if needed), fertilizer or hay mulch if a disk is to be used. and wood cellulose or wood pulp fiber mulch with 2. Tillage may be done with any suitable

water and apply in a slurry uniformly over the area to be treated. Apply within one hour after the mixture is made. Tillage should be done on the contour where Conventional Seeding

> and firmed seedbed. For broadcast planting, use a culti-packer-seeder, drill, rotary seeder, other the seed uniformly over the area to be treated. Cover the seed lightly with 1/8 to 1/4 inch of soil for small seed and 1/2 to 1 inch for large seed when using a cultipacker or other suitable equip-

Seeding will be done on a freshly prepared

No-till seeding is permissible into annual cover crops when planting is done following maturity of the cover crop or if the temporary cover stand is sparse enough to allow adequate growth of he permanent (perennial) species. No-till seeding shall be done with appropriate no-till seeding equipment. The seed must be uniformly distributed and planted at the proper depth.

Shrubs, vines and sprigs may be planted with appropriate planters or hand tools. Pine trees shall be planted manually in the subsoil furrow Each plant shall be set in a manner that will

Where individual holes are dug, fertilizer shall be

placed in the bottom of the hole, two inches of soil

All legume seed shall be inoculated with appropriate nitrogen-fixing bacteria. The innoculant Nursery stock plants shall be planted at the shall be a pure culture prepared specifically for same depth or slightly deeper than they grew at the seed species and used within the dates on the nursery. The tips of vines and sprigs must be at or slightly above the ground surface. A mixing medium recommended by the manu-

the seed. For conventional seeding, use twice shall be added and the plant shall be set in the hole. the amount of innoculant recommended by the manufacturer. For hydraulic seeding, four times Mulch is required for all permanent vegetation applications. Mulch applied to seeded areas shall achieve 75% to 100% soil cover. When

> ing. The mulch may be spread by blower-type spreading equipment, other spreading equipmen

selecting a mulch, design professionals should

Wood cellulose or wood fiber mulch shall be applied uniformly with hydraulic seeding equipment.

Anchor straw or hay mulch immediately after

application by one of the following methods:

or by hand. Mulch shall be applied to cover 75%

shall be used with hydraulic seeding. It shall be applied at the rate of 500 pounds per acre. . Hay and straw mulch shall be pressed Dry straw or dry hay shall be applied (at the into the soil immediately after the mulch is ate indicated above) after hydraulic seeding. spread. A special "packer disk" or disk harrow with the disks set straight may be used. 3. One thousand pounds of wood cellulose or The disks may be smooth or serrated and wood pulp fiber, which includes a tackifier, should be 20 inches or more in diameter and shall be used with hydraulic seeding on slopes 8 to 12 inches apart. The edges of the disks shall be dull enough to press the mulch into 4. Sericea Lespedeza hay containing mature the ground without cutting it, leaving much

plowed into the soil.

of the soil surface.

Synthetic tackifiers, binders or hydraulic mulch specifically designed to tack straw shall be applied in conjunction with or im ediately after the mulch is spread. Synthetic tackifiers shall be mixed and applied according to manufacturer's specifications All tackifiers, binders or hydraulic mulch specifically designed to tack straw should be ed nontoxic through EPA 2021.0 testing. Refer to Tackifiers-Tac

of it in an erect position. Mulch shall not be

planted areas, slopes, in ditches or dry water-3. Rve or wheat can be included with Fall and ways to prevent erosion. Bituminous treated Winter plantings to stabilize the mulch. They roving shall be applied within 24 hours after shall be applied at a rate of one-quarter to an area has been planted. Application rates one-half bushel per acre. and materials must meet Georgia Depart ent of Transportation specifications. Plastic mesh or netting with mesh no larger than one inch by one inch may be needed Wood cellulose and wood pulp fibers shall not to anchor straw or hay mulch on unstable

contain germination or growth inhibiting factors. soils and concentrated flow areas. These They shall be evenly dispersed when agitated in materials shall be installed and anchored water. The fibers shall contain a dve to allow visual according to manufacturer's specifications. metering and aid in uniform application during

Straw or hay mulch will be spread uniformly within 24 hours after seeding and/or plant-

Depth 4" to 6"

3" to 5" 4" to 6"

Wood waste

4" to 6"

Irrigation will be applied at a rate that will not

Topdressing will be applied on all temporary

and permanent (perennial) species planted alone

rates of application are listed in Table 6-5.1.

Second Year and Maintenance Fertilization

fertilizer rates are listed in Table 6-5.1.

requirements, if desired.

November and March.

Second year fertilizer rates and maintenance

Apply one ton of agricultural lime every 4 to

6 years or as indicated by soil tests. Soil tests

Mow Sericea Lespedeza only after frost to

ensure that the seeds are mature. Mow between

Bermudagrass, Bahiagrass and Tall Fescue may

be mowed as desired. Maintain at least 6 inches of top growth under any use and management

Moderate use of top growth is beneficial after es-

Exclude traffic until the plants are well estab-

lished. Because of the quail nesting season, mowing should not take place between May and

Mulch is used as a bedding material to conserve moisture and control weeds in nurserie ornamental beds, around shrubs, and on bare

DURABLE SHRUBS AND GROUND COVERS FOR PERMANENT COVER

<u>Remarks</u>

Low growing. 'Sod' fo Slow to establish. Pl

iame as above.

lant with winter annuals.

ant with Tall fescue.

ıbic feet or approximatel 30 sprigs.

outhern Coastal Plain only

gation is needed until

s Athens and Atlanta.

ttractive rose, pink and

7,000 seed per pound. e alone only on better

heavy use areas or alletic fields.

50,000 seed per pound

years to become fully established. Excellent

eed with EL inoculant

x with Tall fescue or

t when seed is mature

d Tall fescue or winte

in urban areas. Spré

to develop solid stand

ovide wildlife food and

For very wet sites. May

Grows well on coastal sand dunes, borrow areas, and gravel pits. Provides winter cover for wildlife. Mix with Sericea lespedeza except on

Grows similar to tall fescue.

227,000 seed per pound Mix with Weeping lovegra

and dunes.

white blossoms sring to late fall. Mix with 30

Same as above.

Ground covers include a wide range of low-growing plants planted together in considerable numbers to cover large areas of the landscape. Ground covers grow slower than grasses. Weeds are likely to compete. around covers will not be used unless proper maintenance is planned. Maintain mulch at three—inch theckness until plants provide adequate

Fall planting is encouraged because the need for constant watering is reduced and plants have time to establish new roots before hot OMMON | SCIENTIFIC | MATURE | PLANT | COMMENTS

COMMON NAME	SCIENTIFIC NAME	MATURE HEIGHT	PLANT SPACING	COMMENTS
Abelia	Abelia grandiflora	3–4 ft.	5 ft.	Also a prostrate form 2 feet high. Sun, semi-shade. Semi-
Carolina Yellow Jasmine	Gelsemium sempervirens	low	3 ft.	evergreen. Vine. Yellow, trumpet— like flowers. Hardy, one of the best vines. Evergreen. Native to Georgia.
Carpet Bugle	Ajuga reptans	2-4 in.	3 ft.	Needs good drainage, partial shade. Blue or white flowers. Evergreen.
Bearberry Cotoneaster	Cotoneaster dammeri	2-4 ft.	5 ft.	White flowers, red fruit. Sun. Evergreen
Ground Cover Cotoneaster	Cotoneaster salicifoluis 'Repens'	1-2 ft.	5 ft.	White flowers, red fruit. Sun. Evergreen
Rock Cotoneaster	Cotoneaster horizontalis	1-2 ft.	5 ft.	Semi-evergreen. Sun.
Virginia Creeper	Parthenocissue quinquefolia	low	3 ft.	Red in fall. Vine. Deciduous. Native to Georgia.
Daylily	Hemerocallis spp. quinquefolia	2-3 ft.	2 ft.	Many flower colors. Full sun. Very hardy.
English Ivy Compacta	Hedera helix Iļex crenata	low 3-4 ft.	3 ft. 5 ft.	Shade only. Climbs. Sun, semi-shade.
Holly	"Compacta"	3–4 ft.	5 ft.	·
Chinese Holly	llex cornuța Rotunda			Very durable. Sun, semi—shade.
warf Burford Holly	llex, burfordii Nana	5–8 ft.	8 ft.	
warf Yaupon Holly	llex vomitoria Nana	3–4 ft.	5 ft.	Very durable. Sun, semi-shade.
Repandens Holly	ļļex crenata Repandens	2-3 ft.	5 ft.	Sun, semi-shade.
Andorra Juniper	Juniperus horizontalis 'Plumosa'	2-3 ft.	5 ft.	Excellent for slopes. Sun.
Andorra Compacta Juniper	Juniperus horizontalis 'Plumosa, compacta'	1–2 ft.	5 ft.	More compact than andorra.
Blue Chip Juniper	Juniperus horizontalis 'Blue Chip'	8–10 in.	4 ft.	
Blue Rug Juniper	Juniperus horizontaļis Wiltonii	4-6 in.	3 ft.	Very low. Sun.
Parsons Juniper	Juniperus davurica Expansa (Squamata Parsoni)	18-24 in.	5 ft.	One of the best, good winter cover.
Pfitzer Juniper	Juniperus chinensis Pfitzerana	6-8 ft.	6 ft.	Needs room.
Prince of Vales Juniper	Juniperus horizontalis 'Prince of Wales'	8–10 in.	4 ft.	Feathery appearance.
Sargent Juniper	Juniperus chinensis 'Sargentii'	1–2 ft.	5 ft.	Full sun. Needs good drainage. Good winter color.
hore Juniper	Juniperus conferta	2-3 ft.	5 ft.	Emerald Sea or Blue Pacicfic cultivars are good.
Liriope	Liriope muscari	8–10 in.	3 ft.	
Creeping Liriope	Liriope spicata	10-12 in.	1 ft.	Spreads by runners.
Big Leaf Periwinkle	Vinca major	12-15 in.	4 ft.	Lilac flowers in spring. Semi—shade.
Common Periwinkle	Vinca minor	5–6 in.	4 ft.	Lavender-blue flowers in spring. Semi-shade.
Cherokee Rose	Rose laevigata	2 ft.	5 ft.	Rampant grower. Not for restricted spaces. State flower.
lemoria Rose	Rose weuchuriana	2 ft.	5 ft.	Rampant grower.
it. Johnswort	Hypericum calycenun	n 8-12 in.	3 ft.	Semi-shade.
Anthony Water Spirea	Spirea bumalda	3–4 ft.	5 ft.	Sun.
Thunberg Spirea	Spirea thinbergii	3–4 ft.	5 ft.	Sun.

SITE	SOIL MATERIAL	COMMON SOILS	PLANTING TREE SPECIES 1/	SPACING	PLANTING DATES 3/
Borrow areas, graded areas, and spoil material	Sandy	Lakeland Troup	Loblolly pine (Pinus taeda) Longleaf pine (Pinus palustris)	2/	M-L, P12/1-3/15 C 12/1-3/1
	Loamy	Orangeburg, Tifton	Loblolly pine Slash pine	2/	M-L, P12/1-3/15 C 12/1-3/1
	Clay	Cecil, Faceville	Loblolly pine	2/	M-L, P12/1-3/15 C 12/1-3/1

/ Other trees and shrubs listed in the previous tables may be interplanted with the pines for improved wildlife benefits. 2/ Type of Planting Tree Spacing No. of Trees per Acre Trees in combination 6 ft.x6 ft.

Willows 4/

2 ft.x2ft. ALL 11/15-3/1

with grasses and/ or other plants / M—L represents the Mountains; Blue Ridge; and Ridges and Valleys MLRAs C represents the Southern Coastal Plain; Sand Hills; Black lands; and Atlantic Coast Flatwoods MLRAs

1/ Fertilization of companion crop is ample for this species.

TYPE OF SPECIES	YEAR	ANALYSIS OR EQUIVALENT N-P-K	RATE	N TOP DRESSING RATE
1. Cool season grasses	First Second Maintenance	6-12-12 6-12-12 10-10-10	1500 lbs./ac. 1000 lbs./ac. 400 lbs./ac.	50-100 lbs./ac. 1/ 2/ 30
2. Cool season	First	6-12-12	1500 lbs./ac.	0-50 lbs./ac. 1/
grasses and	Second	0-10-10	1000 lbs./ac.	-
legumes	Maintenance	0-10-10	400 lbs./ac.	-
3. Ground covers	First	10-10-10	1300 lbs./ac. 3/	-
	Second	10-10-10	1300 lbs./ac. 3/	-
	Maintenance	10-10-10	1100 lbs./ac.	-
Pine seedlings	First	20–10–5	one 21—gram pelle per seedling placed in the closing hole	
5. Shrub	First	0-10-10	700 lbs./ac.	-
Lespedeza	Maintenance	0-10-10	700 lbs./ac.	
6. Temporary cover crops seeded alone	First	10-10-10	500 lbs./ac.	30 lbs./ac. 5/
7. Warm season grasse	First	6-12-12	1500 lbs./ac.	50 -100 bs./ac. 2/ 6/
	Second	6-12-12	800 lbs./ac.	50 -100 bs./ac. 2/ 6/
	Maintenance	10-10-10	400 lbs./ac.	30 lbs./ac. 5/
8. Warm season	First	6-12-12	1500 lbs./ac.	50 lbs./ac. 6/
grasses and	Second	0-10-10	1000 lbs./ac.	-
legumes	Maintenance	0-10-10	400 lbs./ac.	-

pply in split applications when high rates are used. 5/ Apply to grass species only.
pply in 3 split applications. 6/ Apply when plants grow to a height of 2 to 4 inches. 3/ Apply in 3 split applications.

CONSTRUCTION SPECIFICATIONS INSTALLATION

Bring soil surface to final grade. Clear surface of trash, woody debris, stones and clods larger than 1". surfaces only and not frozen surfaces, or gravel type soils.

Topsoil properly applied will help guarantee a stand. Don't use topsoil recently treated with herbicides or

Mix fertilizer into soil surface. Fertilize based on soil tests or Table 6-6.1. Table 6-6.1

Fertilizer Requirements for Soil Surface Application

(lbs./acre (lbs./sq.ft.) 10-10-10 1000 Fall

Agricultural lime should be applied based on soil tests or at a rate of 1 to 2 tons per acre.

Lay sod with tight joints and in straight lines. Don't overlap joints. Stagger joints and do not stretch sod

On slopes steeper than 3:1, sod should be anchored with pins or other approved methods. Installed sod should be rolled or tamped to provide good contact between sod and soil.

Irrigate sod and soil to a depth of 4" immediately after installation. Sod should not be cut or spread in extremely wet or dry weather. Irrigation should be used to supplement

minimum of 2-3 weeks. MATERIALS

> Sod selected should be certified. Sod grown in the general area of the project is desirable. 1. Sod should be machine cut and contain $\frac{3}{4}$ " (+ or $-\frac{1}{4}$ ") of soil, not including shoots or thatch. Sod should be cut to the desired size within + or - 5%. Torn or uneven pads should be rejected.

3. Sod should be cut and installed within 36 hours of diagina. 4. Avoid planting when subject to frost heave or hot weather if irrigation is not available. 5. The sod type should be shown on the plans or installed according to Table 6-6.2. Se Figure 6-4.1 for your

Table 6-6.2 Sod Planting Requirements

Grass	Varieties	Resource Area	Growing Season
Bermudagrass	Common Tifway Tifgreen Tiflawn	M-L, P,C P,C P,C P,C	Warm Weather
Bahiagrass	Pensacola	P,C	Warm Weather
Centipede	-	P,C	Warm Weather
St. Augustine	Common Bitterblue Raleigh	С	Warm Weather
Zoysia	Emerald Myer	P,C	Warm Weather
Tall Fescue	Kentucky	M-L,P	Cool Weather

Re—sod areas where an adequate stand of sod is not obtained. New sod should be mowed sparingly. Grass height should not be cut less than 2"-3" or as specified (See Figure 6-6.2) Apply one ton of agricultural lime as indicated by soil test or every 4—6 years. Fertilize grasses in

Fertilizer Requirements for Sod

tests or Table 6-6.3.

Types of Species	Planting Year	Fertilizer (N-P-K)	Rate (lbs./acre)	Nitrogen Top Dressing Rate (lbs./acre)
Cool	First	6-12-12	1500	50-100
season	Second	6-12-12	1000	-
grasses	Maintenance	10-10-10	400	30
Warm	First	6-12-12	1500	50-100
season	Second	6-12-12	800	50-100
grasses	Maintenance	10-10-10	400	30


DISTURBED AREA STABILIZATION

Ds4

Charles M Abbott Level II Certified Design Professional CERTIFICATION NUMBER ___ ISSUED: 04/13/2019 EXPIRES: 04/13/2022

NO NPDES MONITORING TO OCCUR FOR THIS PROJECT

Know what's **below**. **Call** before you dig.

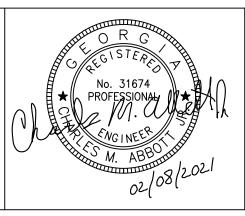

DISTURBED AREA STABILIZATION (WITH PERMANENT VEGETATION) De3

PLANS PREPARED BY: KAIZENCOLLABORATIVE 2390 Main Street | Tucker, GA 30084 | 404.239.2521

PLANTS, PLANTING RATES AND PLANTING DATES FOR PERMANENT COVER

temporary cover

with other perennials

with other perennials

(ynodon dactylon) Hulled seed

ith other perennial:

ith temporary cove

with other perennials

BERMUDA SPRIGS (Cynodon dactylon

Coastal, Common Midland, or Tift

Coastal, Common, or Tift 44

with winter annuals

estuca arundinace

with other perennials

ınscarified

scarified

unscarified

ESPEDEZA, SHRUB Lespedeza bicolor) Lespedeza thumbergii)

ragrostis curvula

Panicum hemitomor

REED CANARY GRASS (Phalaris arundinacea)

with other perennials

MAIDENCANE

seed-bearing hay

Block sod only

15 lbs. 0.3

30 lbs.

60 lbs.

75 lbs.

3 tons

60 lbs.

75 lbs.

30 lbs.

Reduce seeding rates by 50% when drilled.

PLS is an abbreviation for Pure Live Seed. Refer to section V.E of

3/ M—L represents to Mountain; Blue Ridge; and Ridges and Valleys MLRAs.

C represents Southern Coastal Plain; Sand Hills; Black Lands and Atlantic Coastal Flatwoods MLRA

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Tift 78

alone or with


<u>Planting Dates by Resource Areas</u>

dotted lines indicate permissible

Planting Dates
(Solid lines indicate optimum dates,

CHARLES M. ABBOTT JR, P.E. DESIGN ENGINEER LEVEL II CERTIFICATION GSWCC # 0000041686 EXPIRES: 04/13/2022 CHUCK.ABBOTT@KAIZENCOLLABORATIVE.COM T: 404-239-2521

CITY OF BROOKHAVEN DONALD SHERRILL - PUBLIC WORKS DEPUTY DIRECTOR 4362 PEACHTREE RD., BROOKHAVEN, GA 30319 E: DON.SHERRILL@BROOKHAVENGA.GOV O: 404-991-4763 C: 404-637-0682

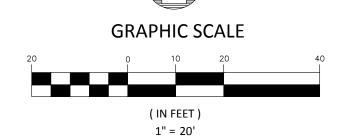

REVISION DATES 100% ISSUE FOR PERMIT 11/20/2020 REV. 1 CITY COMMENTS 01/11/2021 REV. 2 AGENCY COMMENTS 02/08/2021

STATE OF GEORGIA DEPARTMENT OF TRANSPORTATION OFFICE: DISTRICT 7 EROSION CONTROL DETAILS

N.E. EXPRESSWAY FRONTAGE ROAD MUTI-USE PATH